DEFINITIVE SUBDIVISION PLAN "FISKE HILL EAST"

30 MAIN STREET & 20 FISKE HILL ROAD

STURBRIDGE, MASSACHUSETTS OWNED BY:

FISKE HILL EAST REALTY TRUST
97 ARNOLD ROAD
FISKDALE, MA 01518

DATE: 11/11/20

PROJECT ENGINEERS:

McCLURE


ENGINEERING, INC

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SITE LOCUS



NOTES:

- 1. PROPERTY KNOWN AS MAP 3534, LOT 20 & MAP 3914, LOT 30 AS SHOWN ON THE GIS MAPS OF THE TOWN OF STURBRIDGE, WORCESTER COUNTY, COMMONWEALTH OF MASSACHUSETTS.
- 2. AREA OF LOT 20 = 5,063,431 SF OR $116\pm$ AC. (PER RECORD PLAN) AREA OF LOT 30 = 791,866 SF OR 18.179 AC. TOTAL = 5,855,297 SF OR 134 AC. \pm
- 3. THE BEARING BASIS OF THIS SURVEY IS BASED ON THE NORTH AMERICAN DATUM OF 1983 MASSACHUSETTS MAINLAND STATE PLANE COORDINATE SYSTEM.
- 4. THIS PLAN IS BASED ON INFORMATION PROVIDED BY A SURVEY PREPARED IN THE FIELD BY LEVESQUE GEOMATICS INC AND OTHER REFERENCE MATERIAL AS LISTED HEREON.
- 5. THIS SURVEY WAS PREPARED WITHOUT THE BENEFIT OF A TITLE REPORT AND IS SUBJECT TO THE RESTRICTIONS, COVENANTS AND/OR EASEMENTS THAT MAY BE
- THE WETLAND DELINEATION LINE WAS PLACED IN THE FIELD BY LEC ENVIRONMENTAL CONSULTANTS IN FEBRUARY 2020 AND FIELD LOCATED BY LEVESQUE GEOMATICS INC APRIL 2020.
- 7. ELEVATIONS REFER TO THE NORTH AMERICAN VERTICAL DATUM OF 1988 (NAVD88), BASED ON RTK GPS OBSERVATIONS ON THE KEYSTONE REAL TIME NETWORK AND ARE SUBJECT TO LOCAL BENCHMARK ADJUSTMENT.
- 8. THE PROPERTY SHOWN IS LOCATED IN FLOOD HAZARD ZONE X (AREAS DETERMINED TO BE OUTSIDE THE 0.2% ANNUAL CHANCE FLOODPLAIN) AS SHOWN ON FLOOD INSURANCE RATE MAP 25027C0933E & 25027C0931E WITH AN EFFECTIVE DATE OF 7/04/2011.
- . LOT 20 SHOWN HEREON IS BASED UPON RECORD PLAN 371 / 114 ONLY AND IS NOT THE RESULT OF AN INSTRUMENT SURVEY BY LEVESQUE GEOMATICS INC.

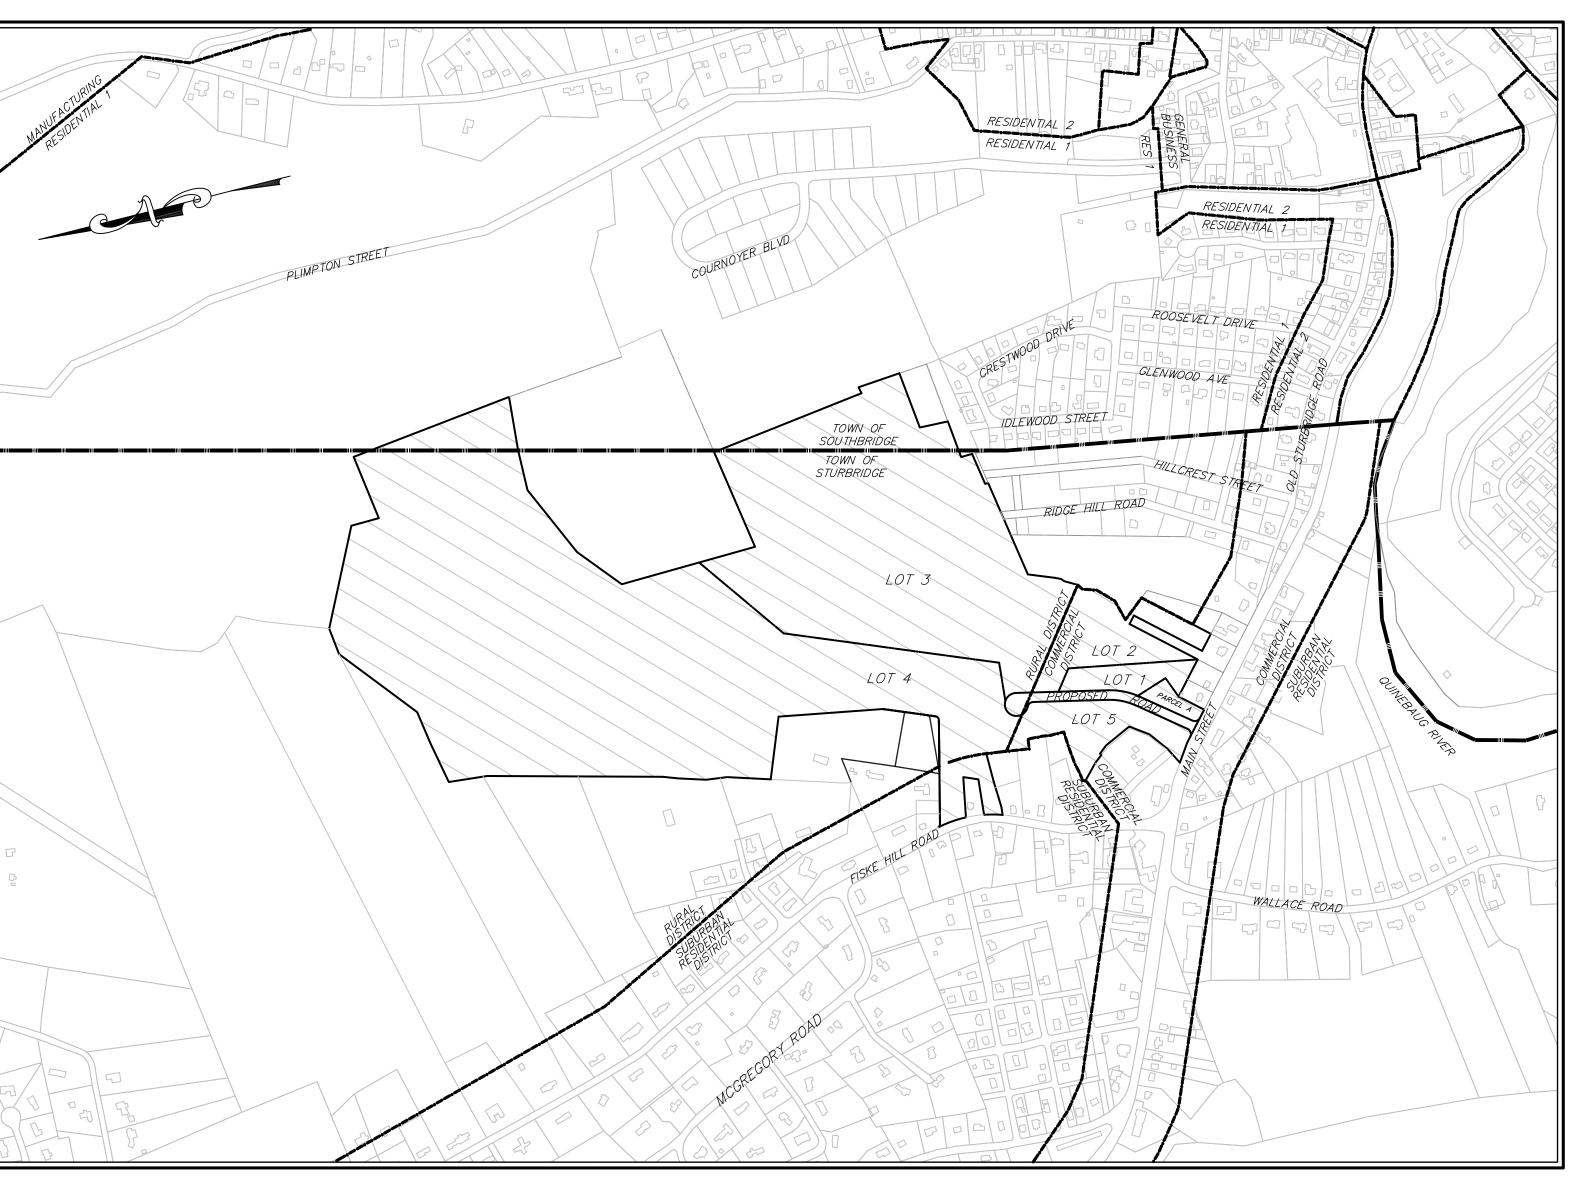REFERENCES:

PLAN BOOK / PLAN #
23 / 79
68 / 31
104 / 36
207 / 69
371 / 114
400 / 100
438 / 54
474 / 39
681 / 96
682 / 105
798 / 13
853 / 51

PROJECT SURVEYORS:

LEVESQUE GEOMATICS INC

43 GLENDALE ROAD STURBRIDGE, MA 01518 PHONE: (508) 868-0041

IN ACCORDANCE WITH SECTION 6.5 OF THE TOWN OF STURBRIDGE PLANNING BOARD'S SUBDIVISION RULES AND REGULATION, IT IS REQUESTED THAT WAIVERS BE ALLOWED FOR THE FOLLOWING:

- 1. SECTION 8.1.C THAT THE PLAN SHOWS ALL EXISTING INDIVIDUAL TREES OF 10-INCH
- DIAMETER OR GREATER WITHIN 50' OF THE PROPOSED RIGHT-OF-WAY.

 2. SECTION 8.1.J 8.5X11 INCH SHEET SHOWING OUTLINE OF SUBDIVISION AT 100 OR 300 SCALE.
- 3. SECTION 10.C.1 MAJOR STREET WIDTH AND PAVEMENT WIDTH TO BE 60' AND 32'. 52' AND
- 28' PROVIDED.
- 4. SECTION 10.E.2 DEAD END STREET LENGTH OF NO GREATER THAN 500'. 1,030'± PROVIDED.

 5. SECTION 11.B.2.A MINIMUM 36" COVER PROVIDED ON DRAINAGE PIPES. 24" PROVIDED AT CB1
- 6. SECTION 12.A.2.A WATER MAINS SHALL BE NOT LESS THAN 8" DIAMETER. 6" PROVIDED.


			SUBDIVISION TURBRIDGE	CONTROL	LAW
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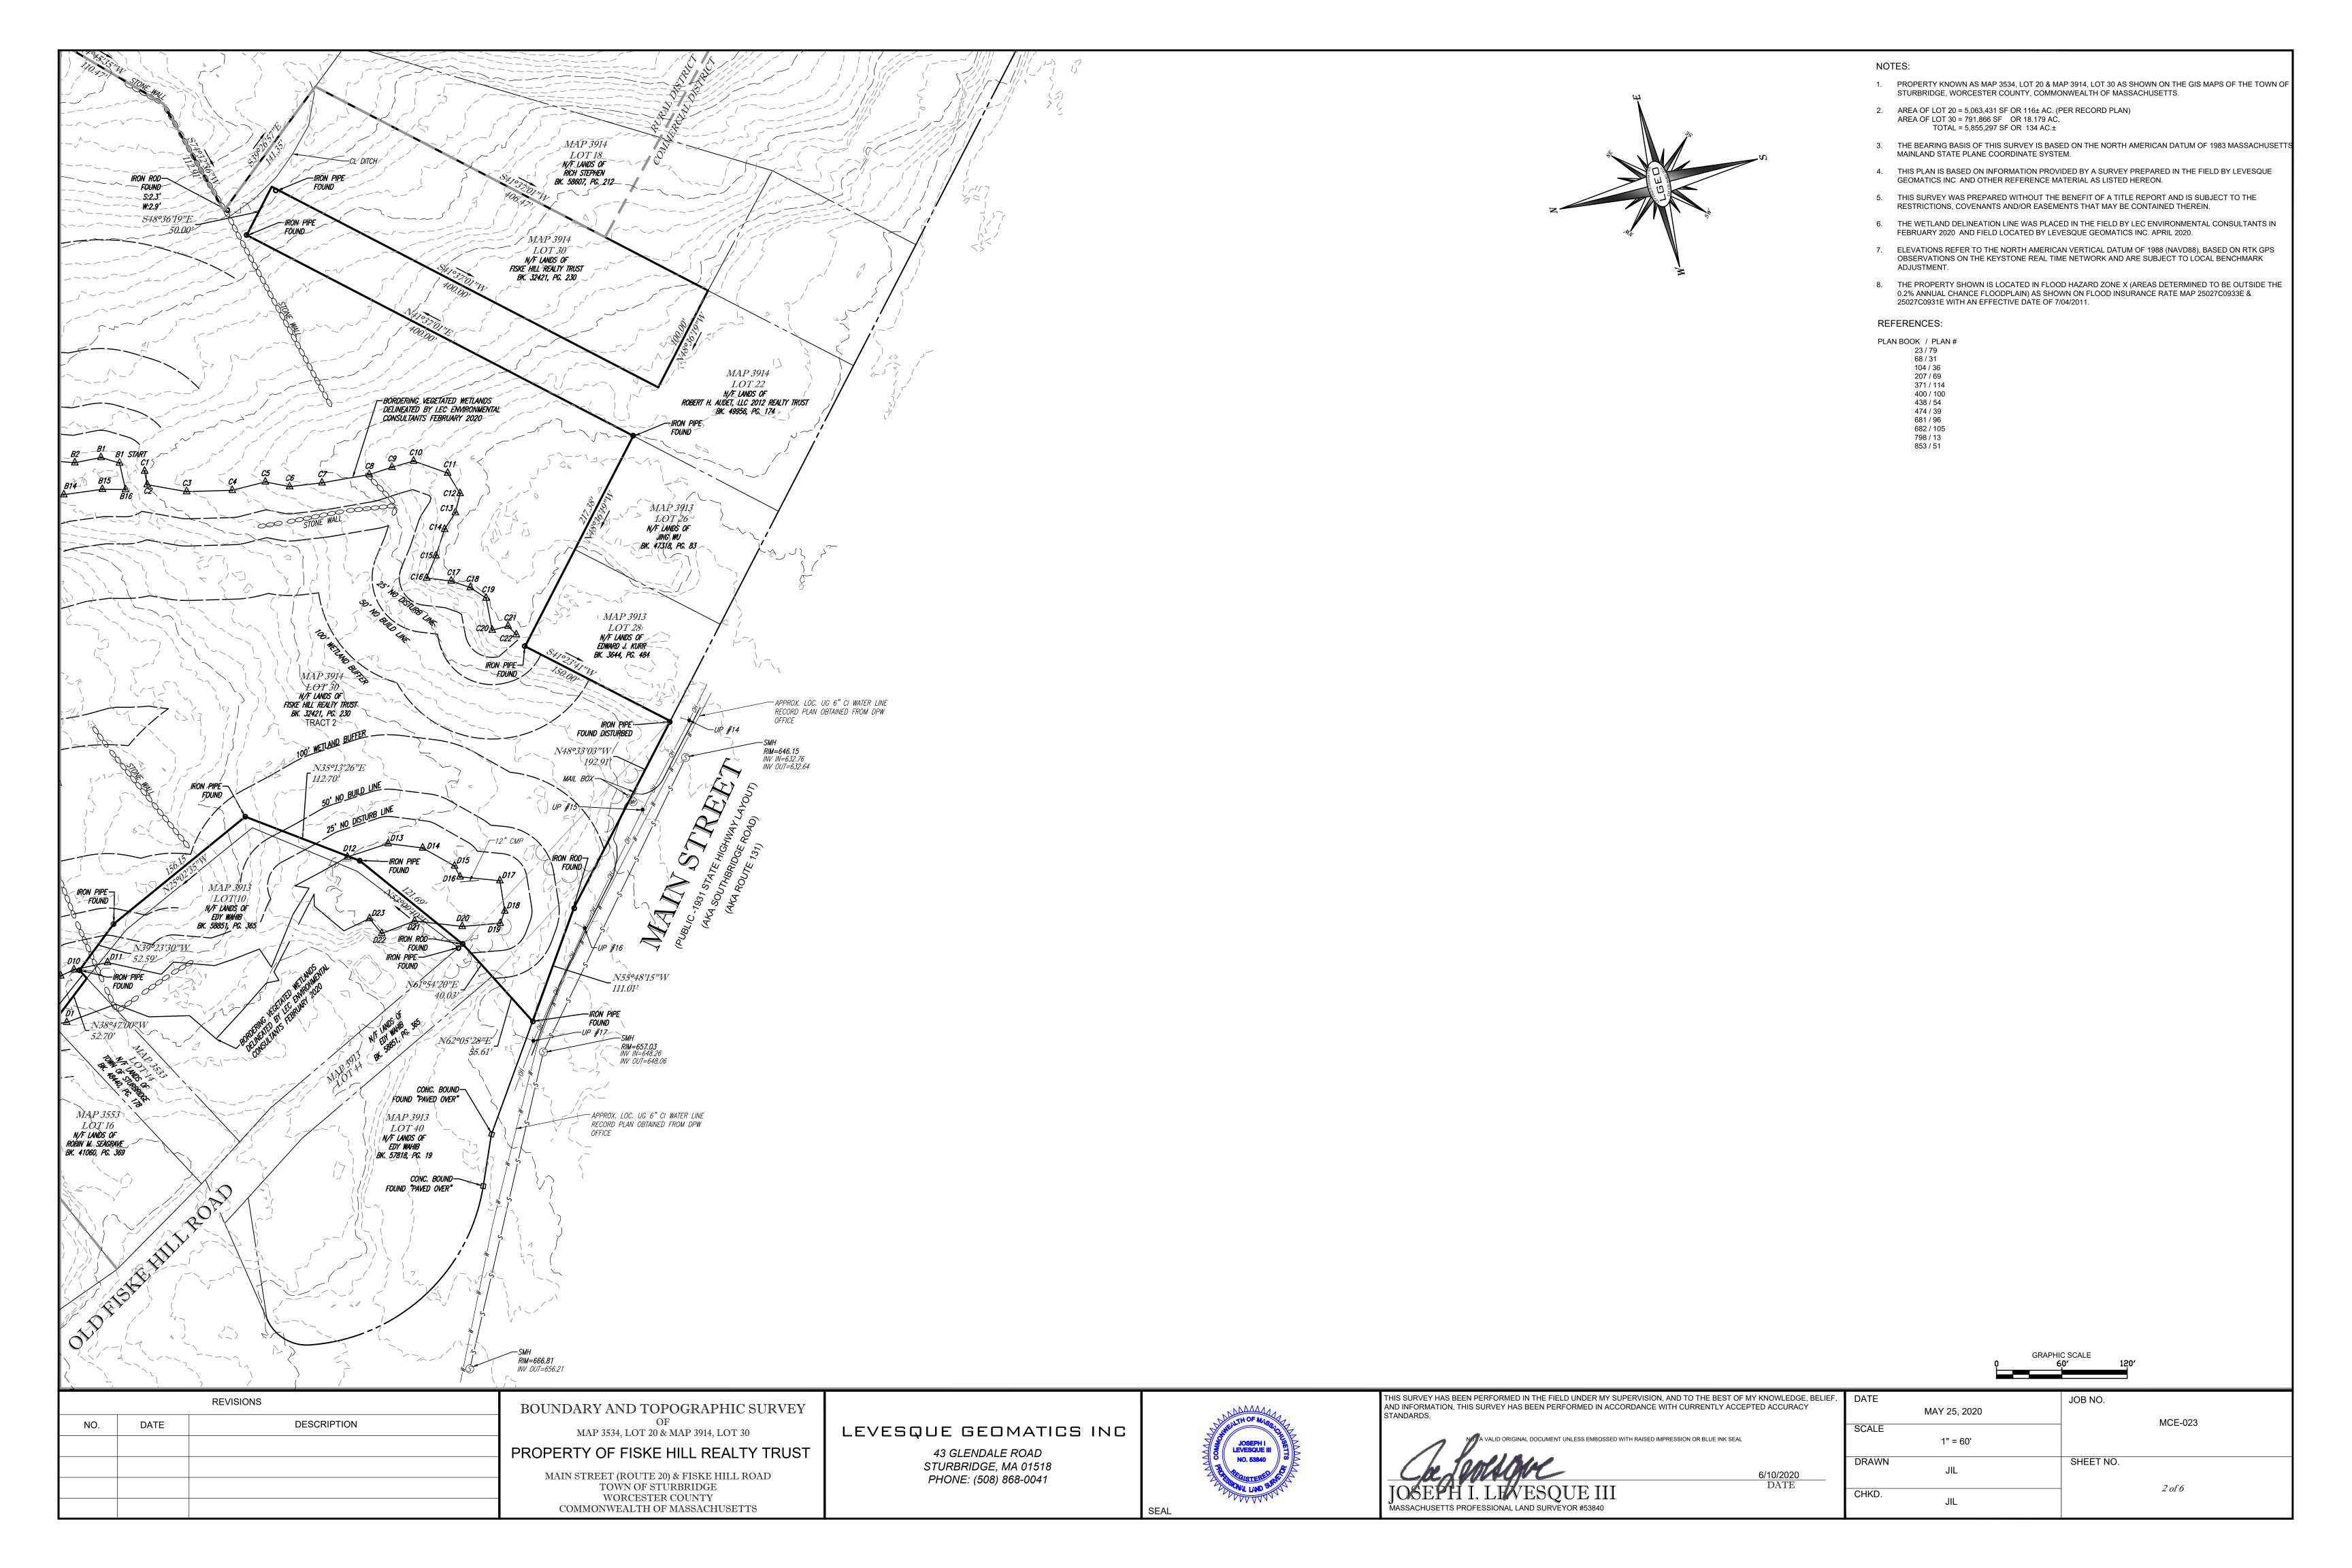
THIS IS TO CERTIFY THAT NOTICE FROM THE PLANNING BOARD OF STURBRIDGE APPROVAL OF THIS PLAN WAS RECEIVED FROM _______ (AT TIME) _____ AND RECORDED BY ME ON (DATE) ______ (AT TIME) _____ AND NO NOTICE OF APPEAL FROM SUCH APPROVAL WAS RECEIVED BY ME DURING THE TWENTY DAYS NEXT AFTER RECEIPT AND RECORDING OF SUCH NOTICE OF APPROVAL.


TOWN CLERK


APPROVED ON ______, SUBJECT TO COVENANT CONDITIONS SET FORTH IN A COVENANT EXECUTED BY_____, AND TO BE (RECORDED) (REGISTERED) HEREWITH, AND SUBJECT TO CONDITIONS LISTED WITHIN THE PLAN.


<	DATE	DESCRIPTION	MADE	APP.
	12.29.20	REV. PER CLIENT	PE	JL
	5.28.21	REV. PER PEER REVIEW	WN	PE




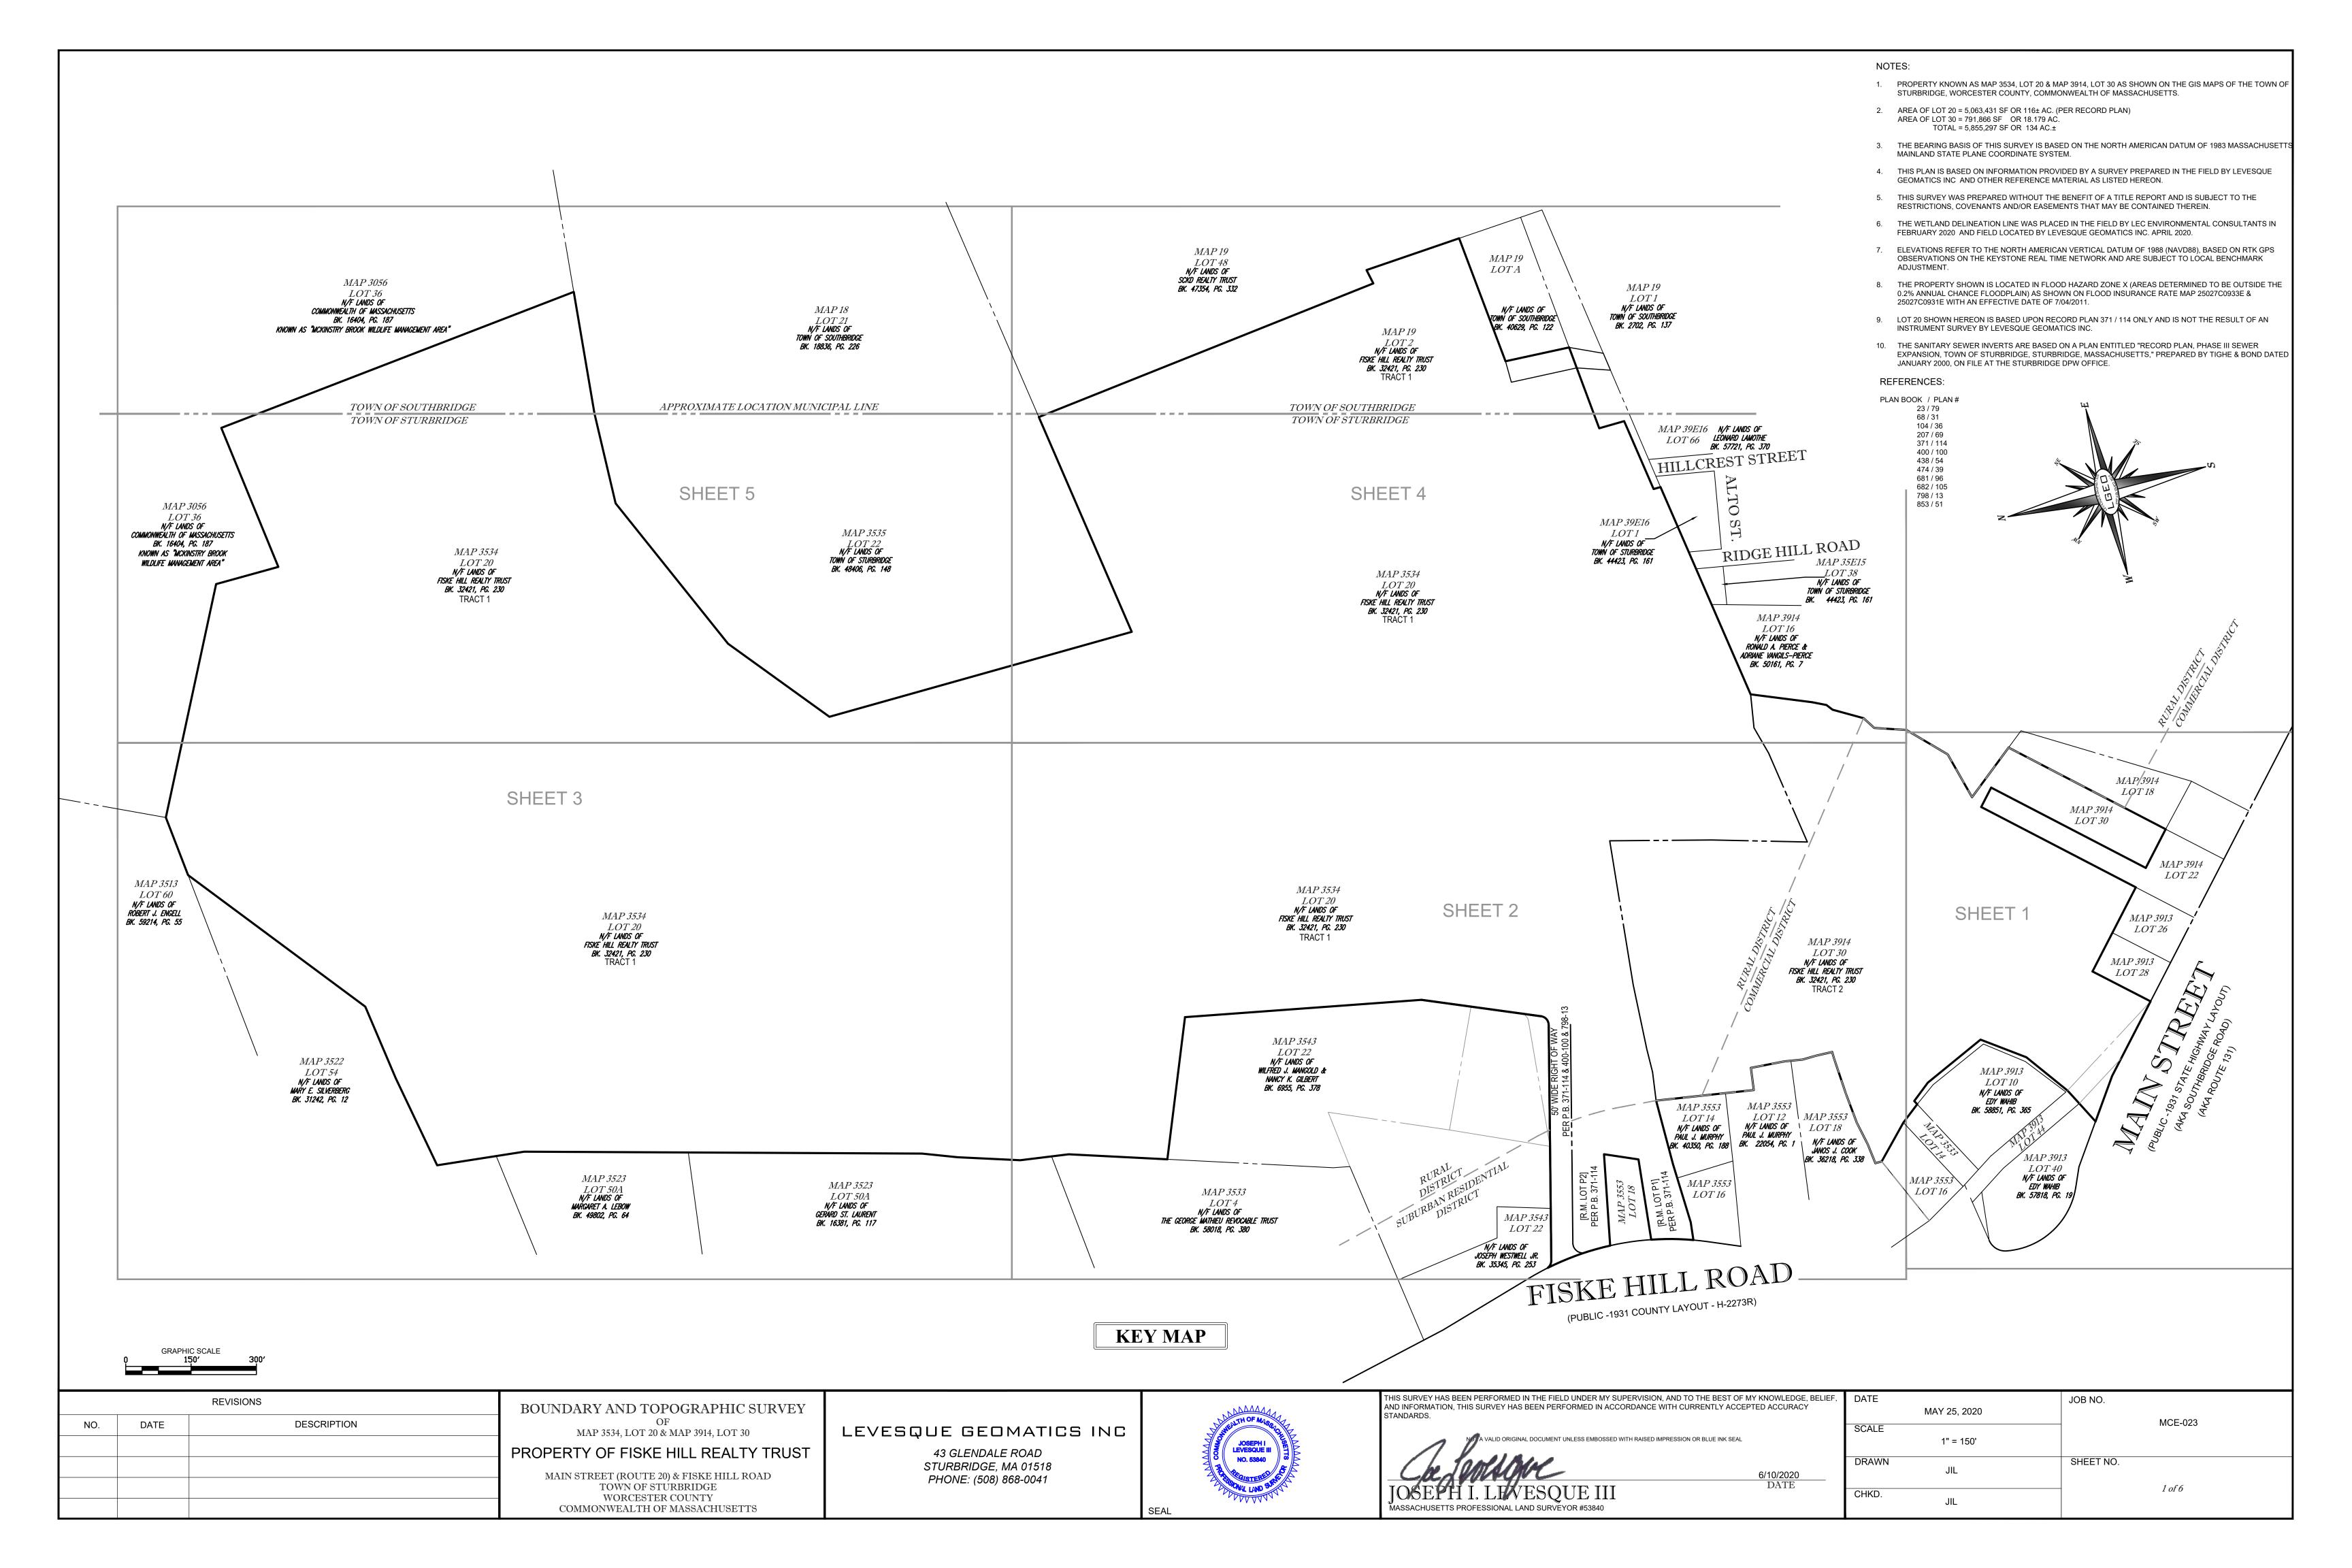


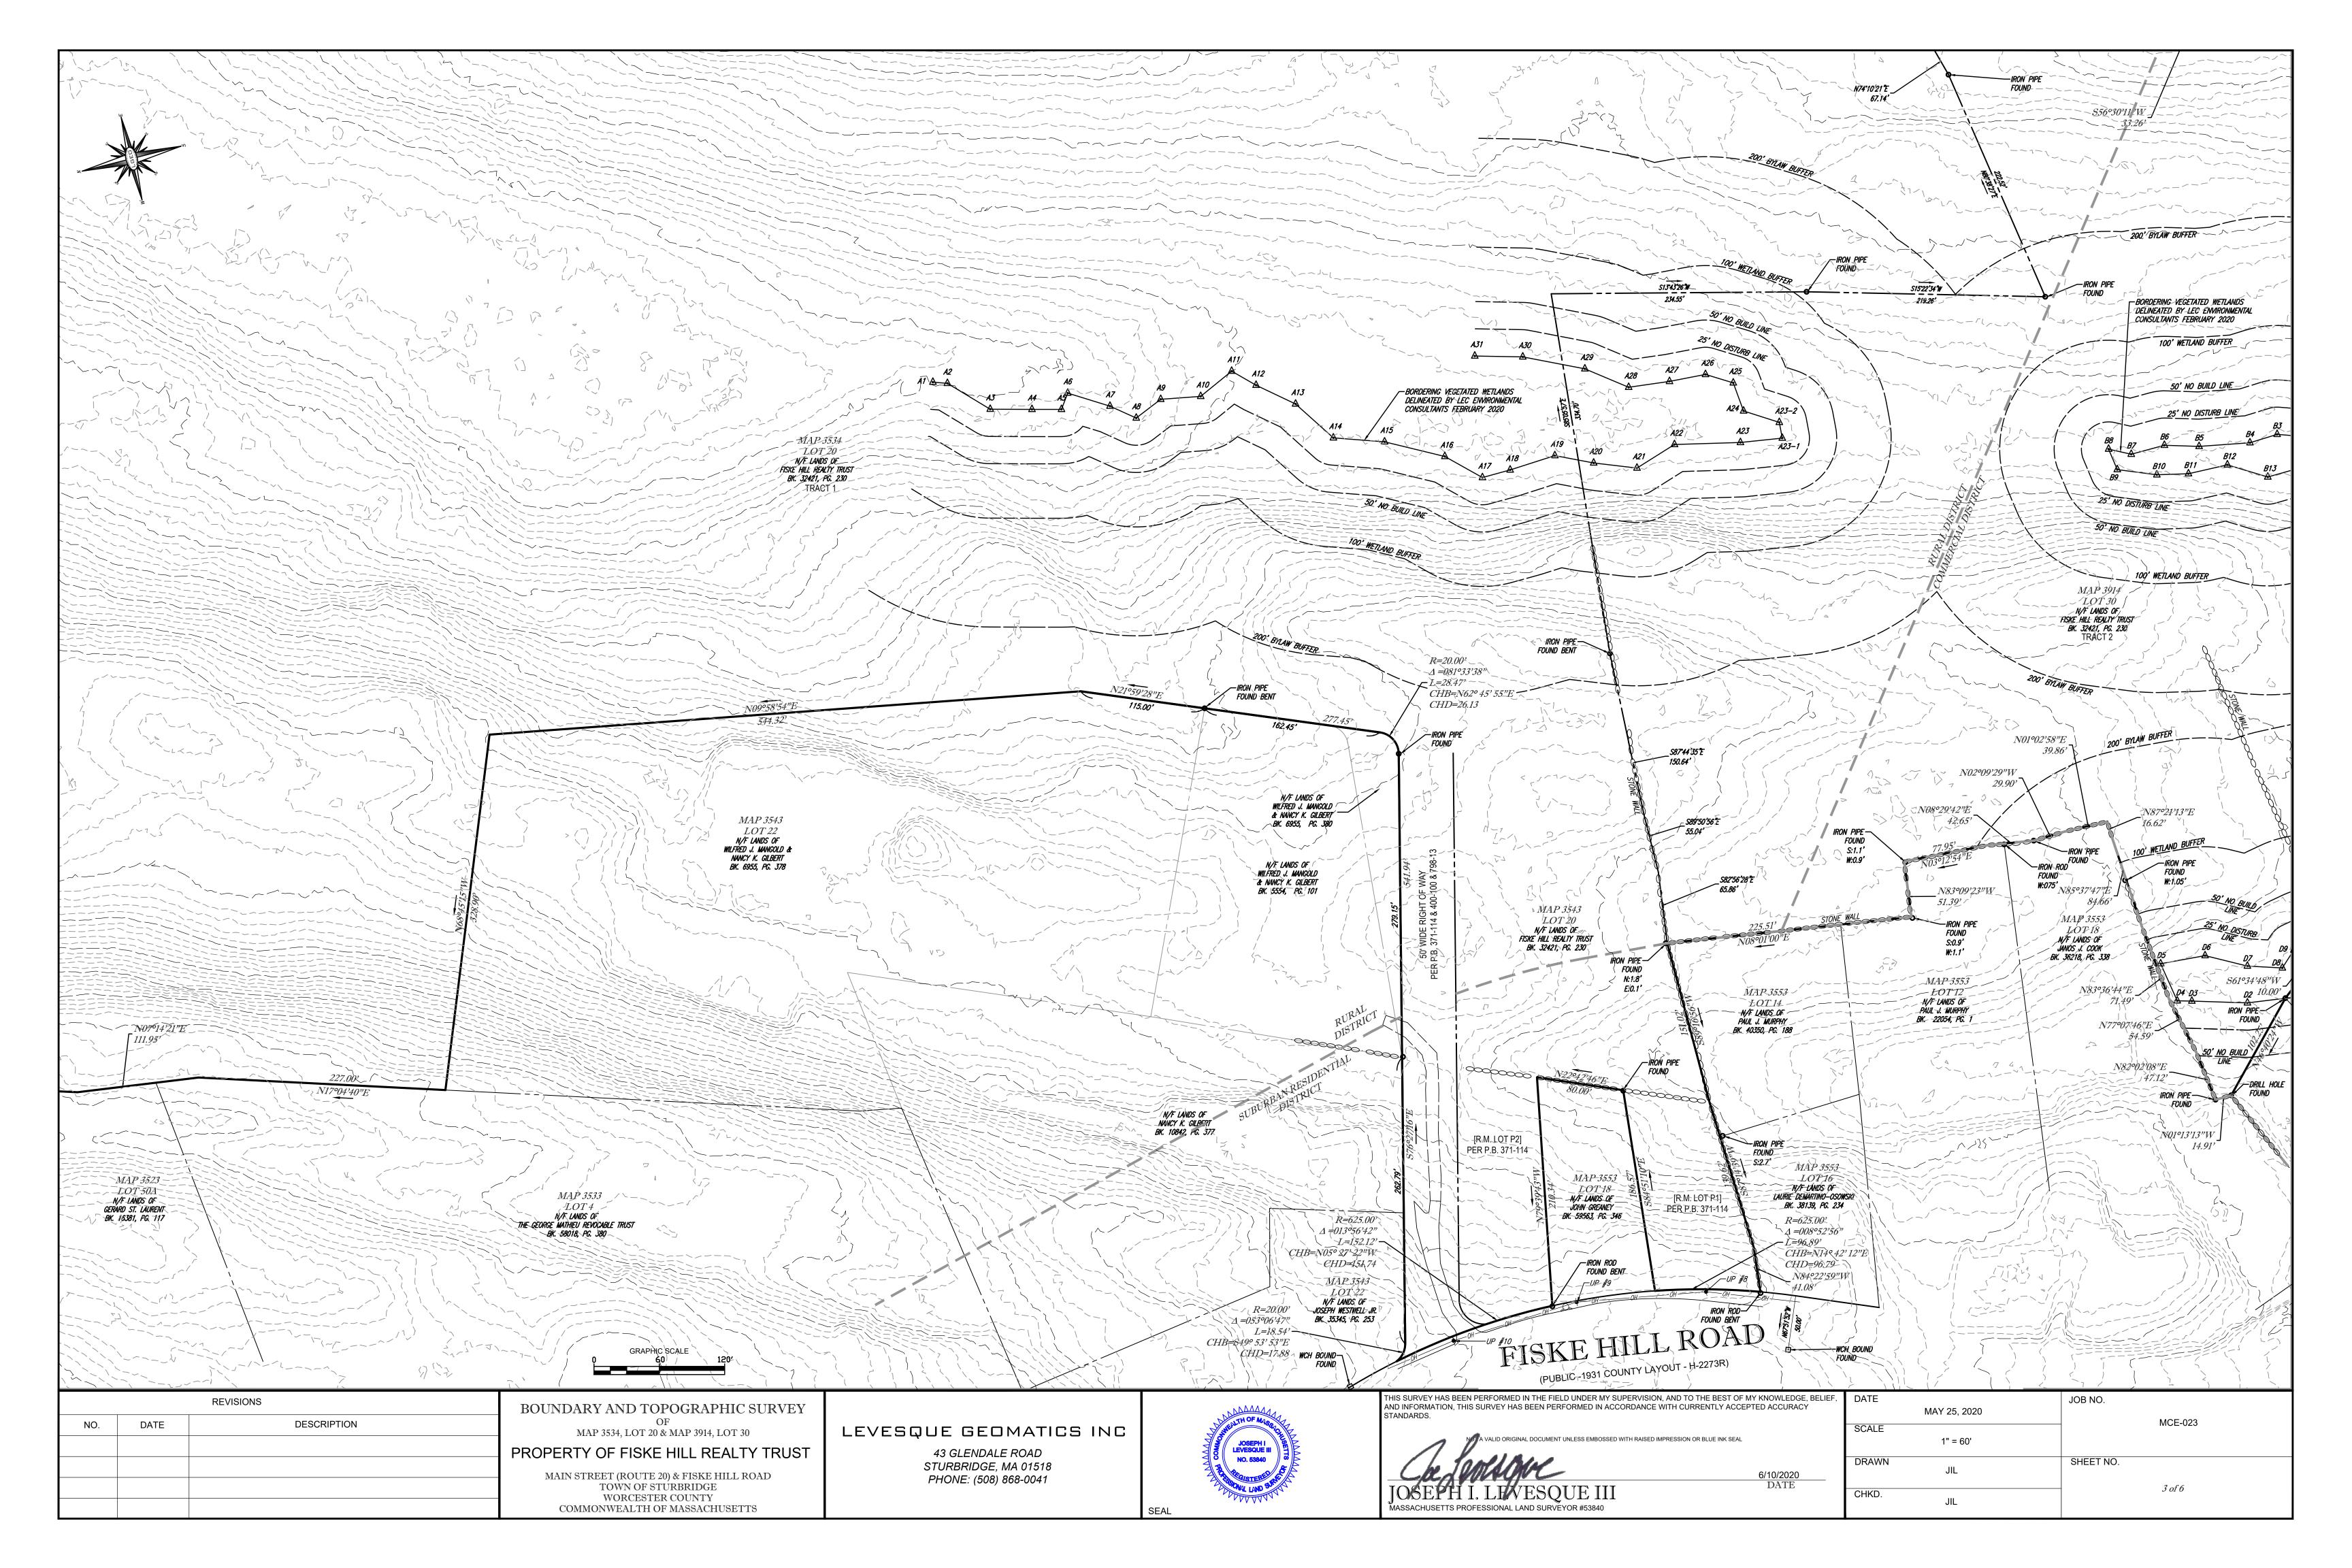


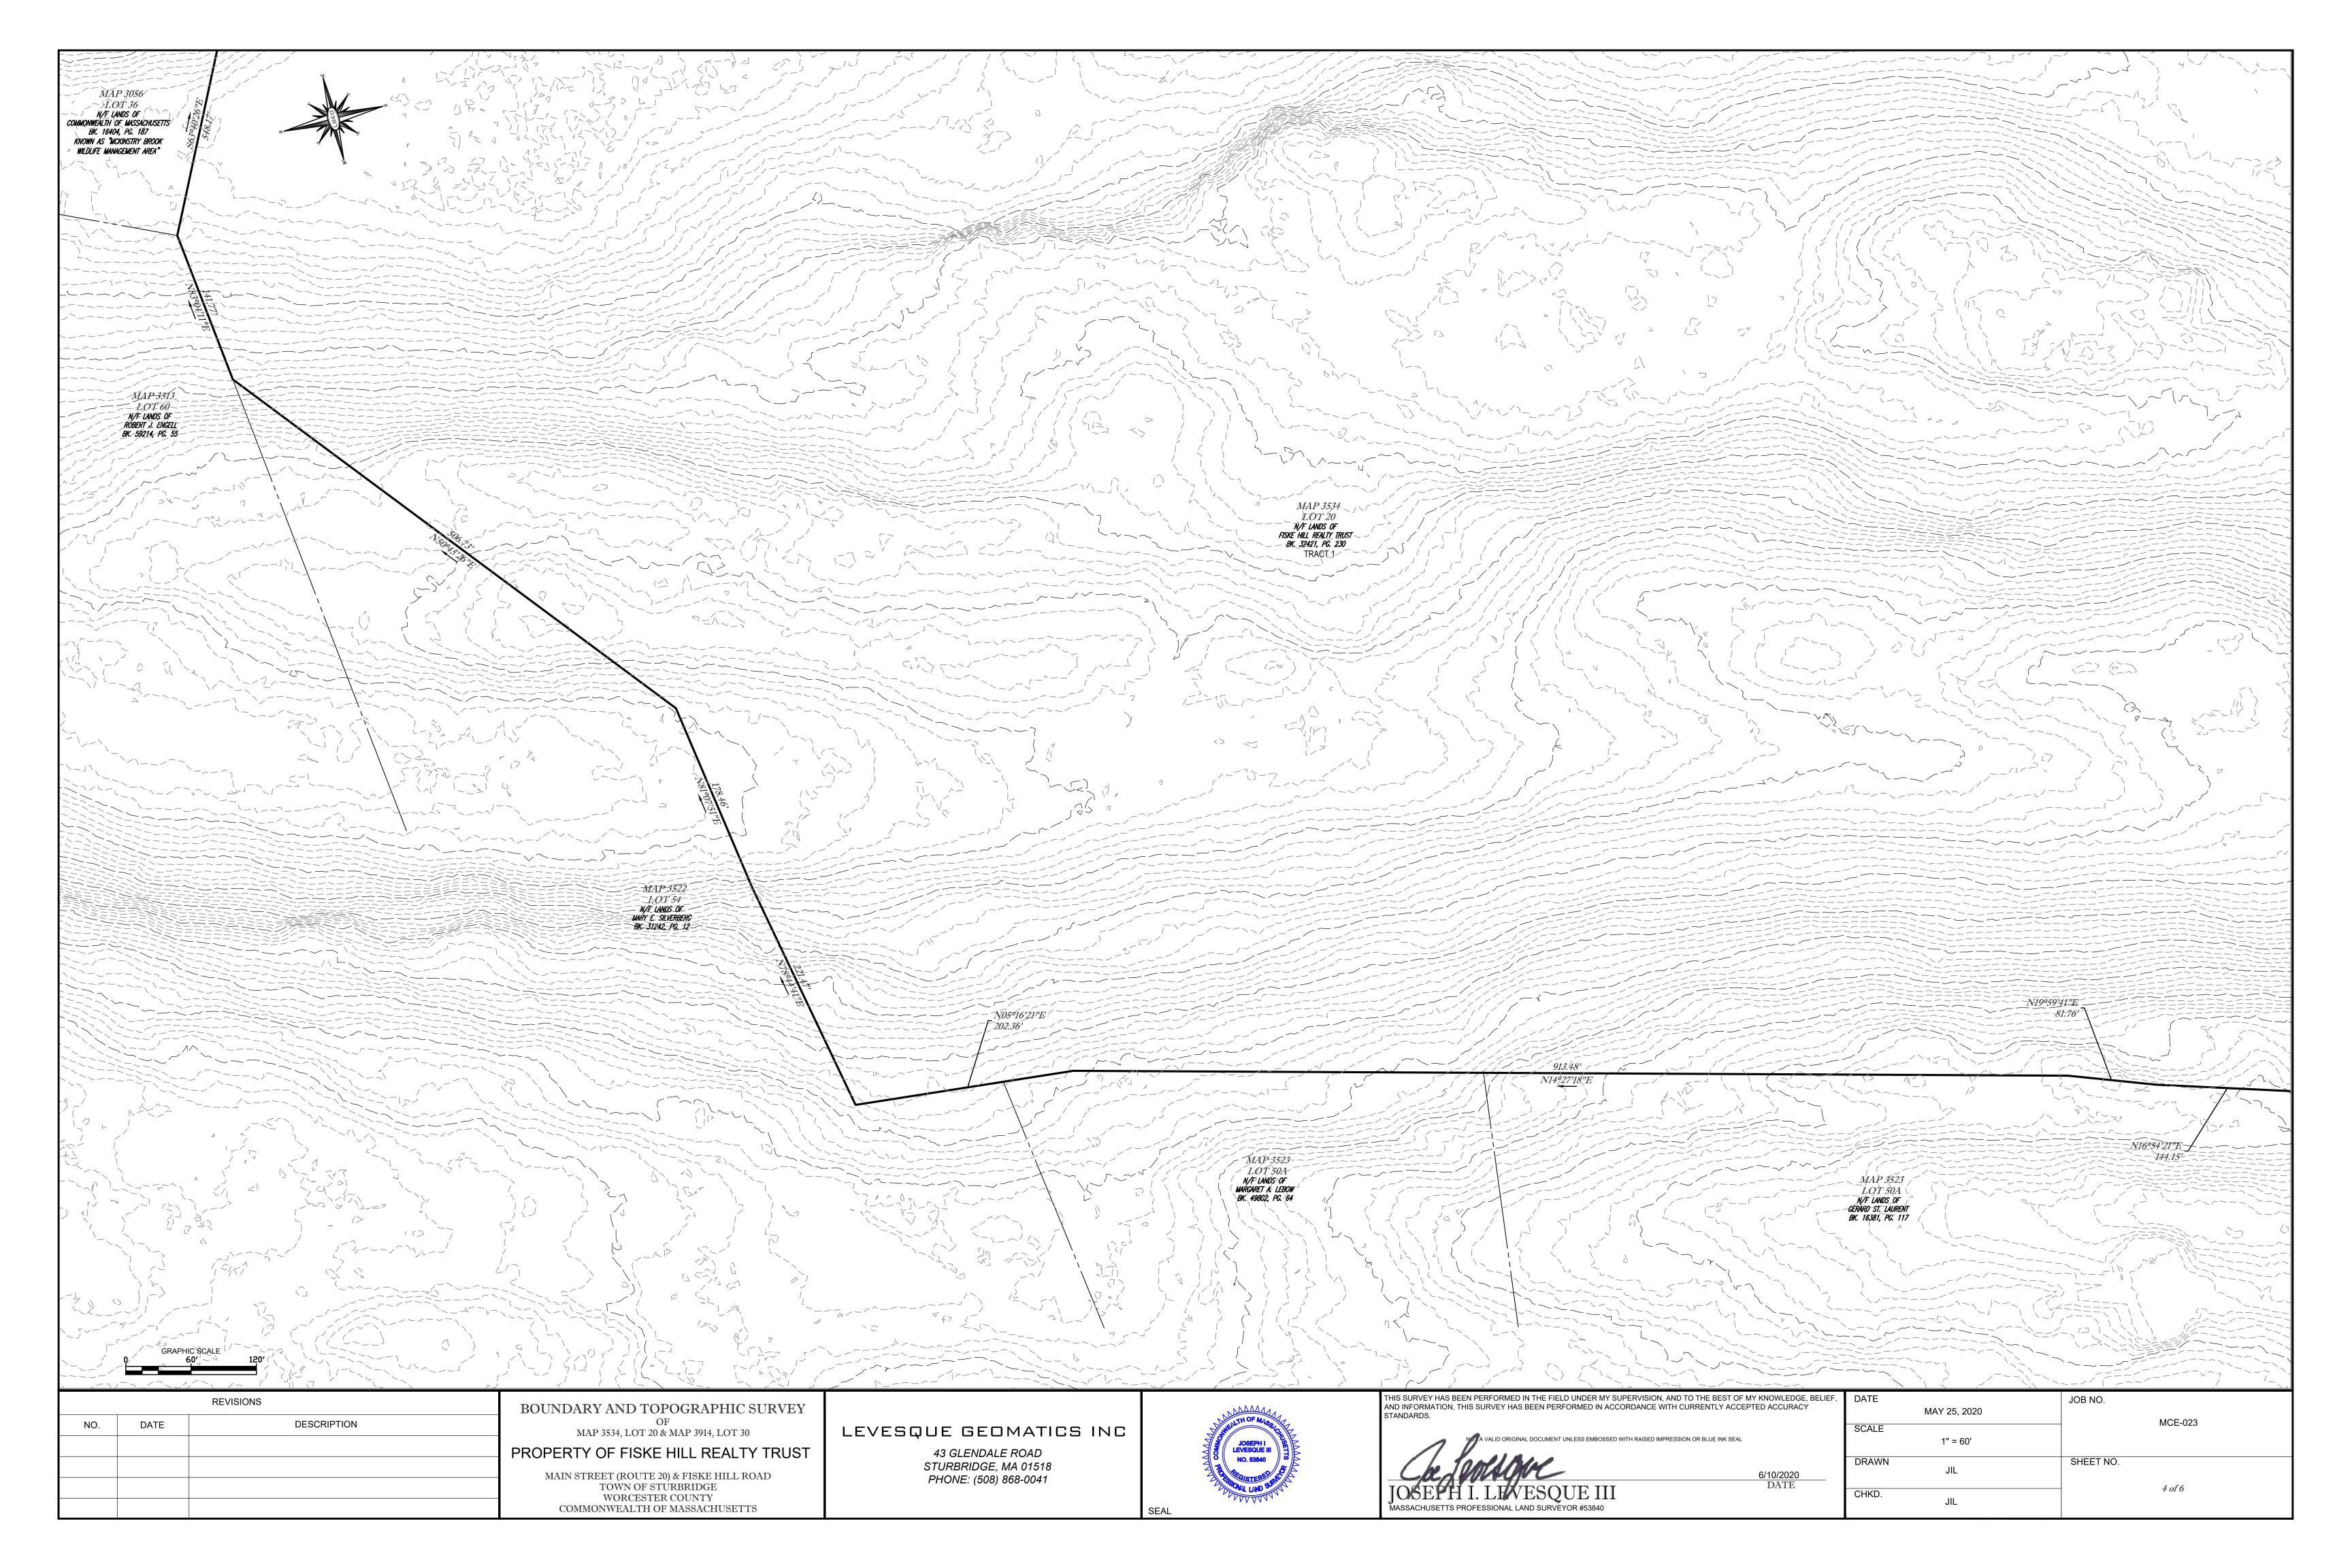


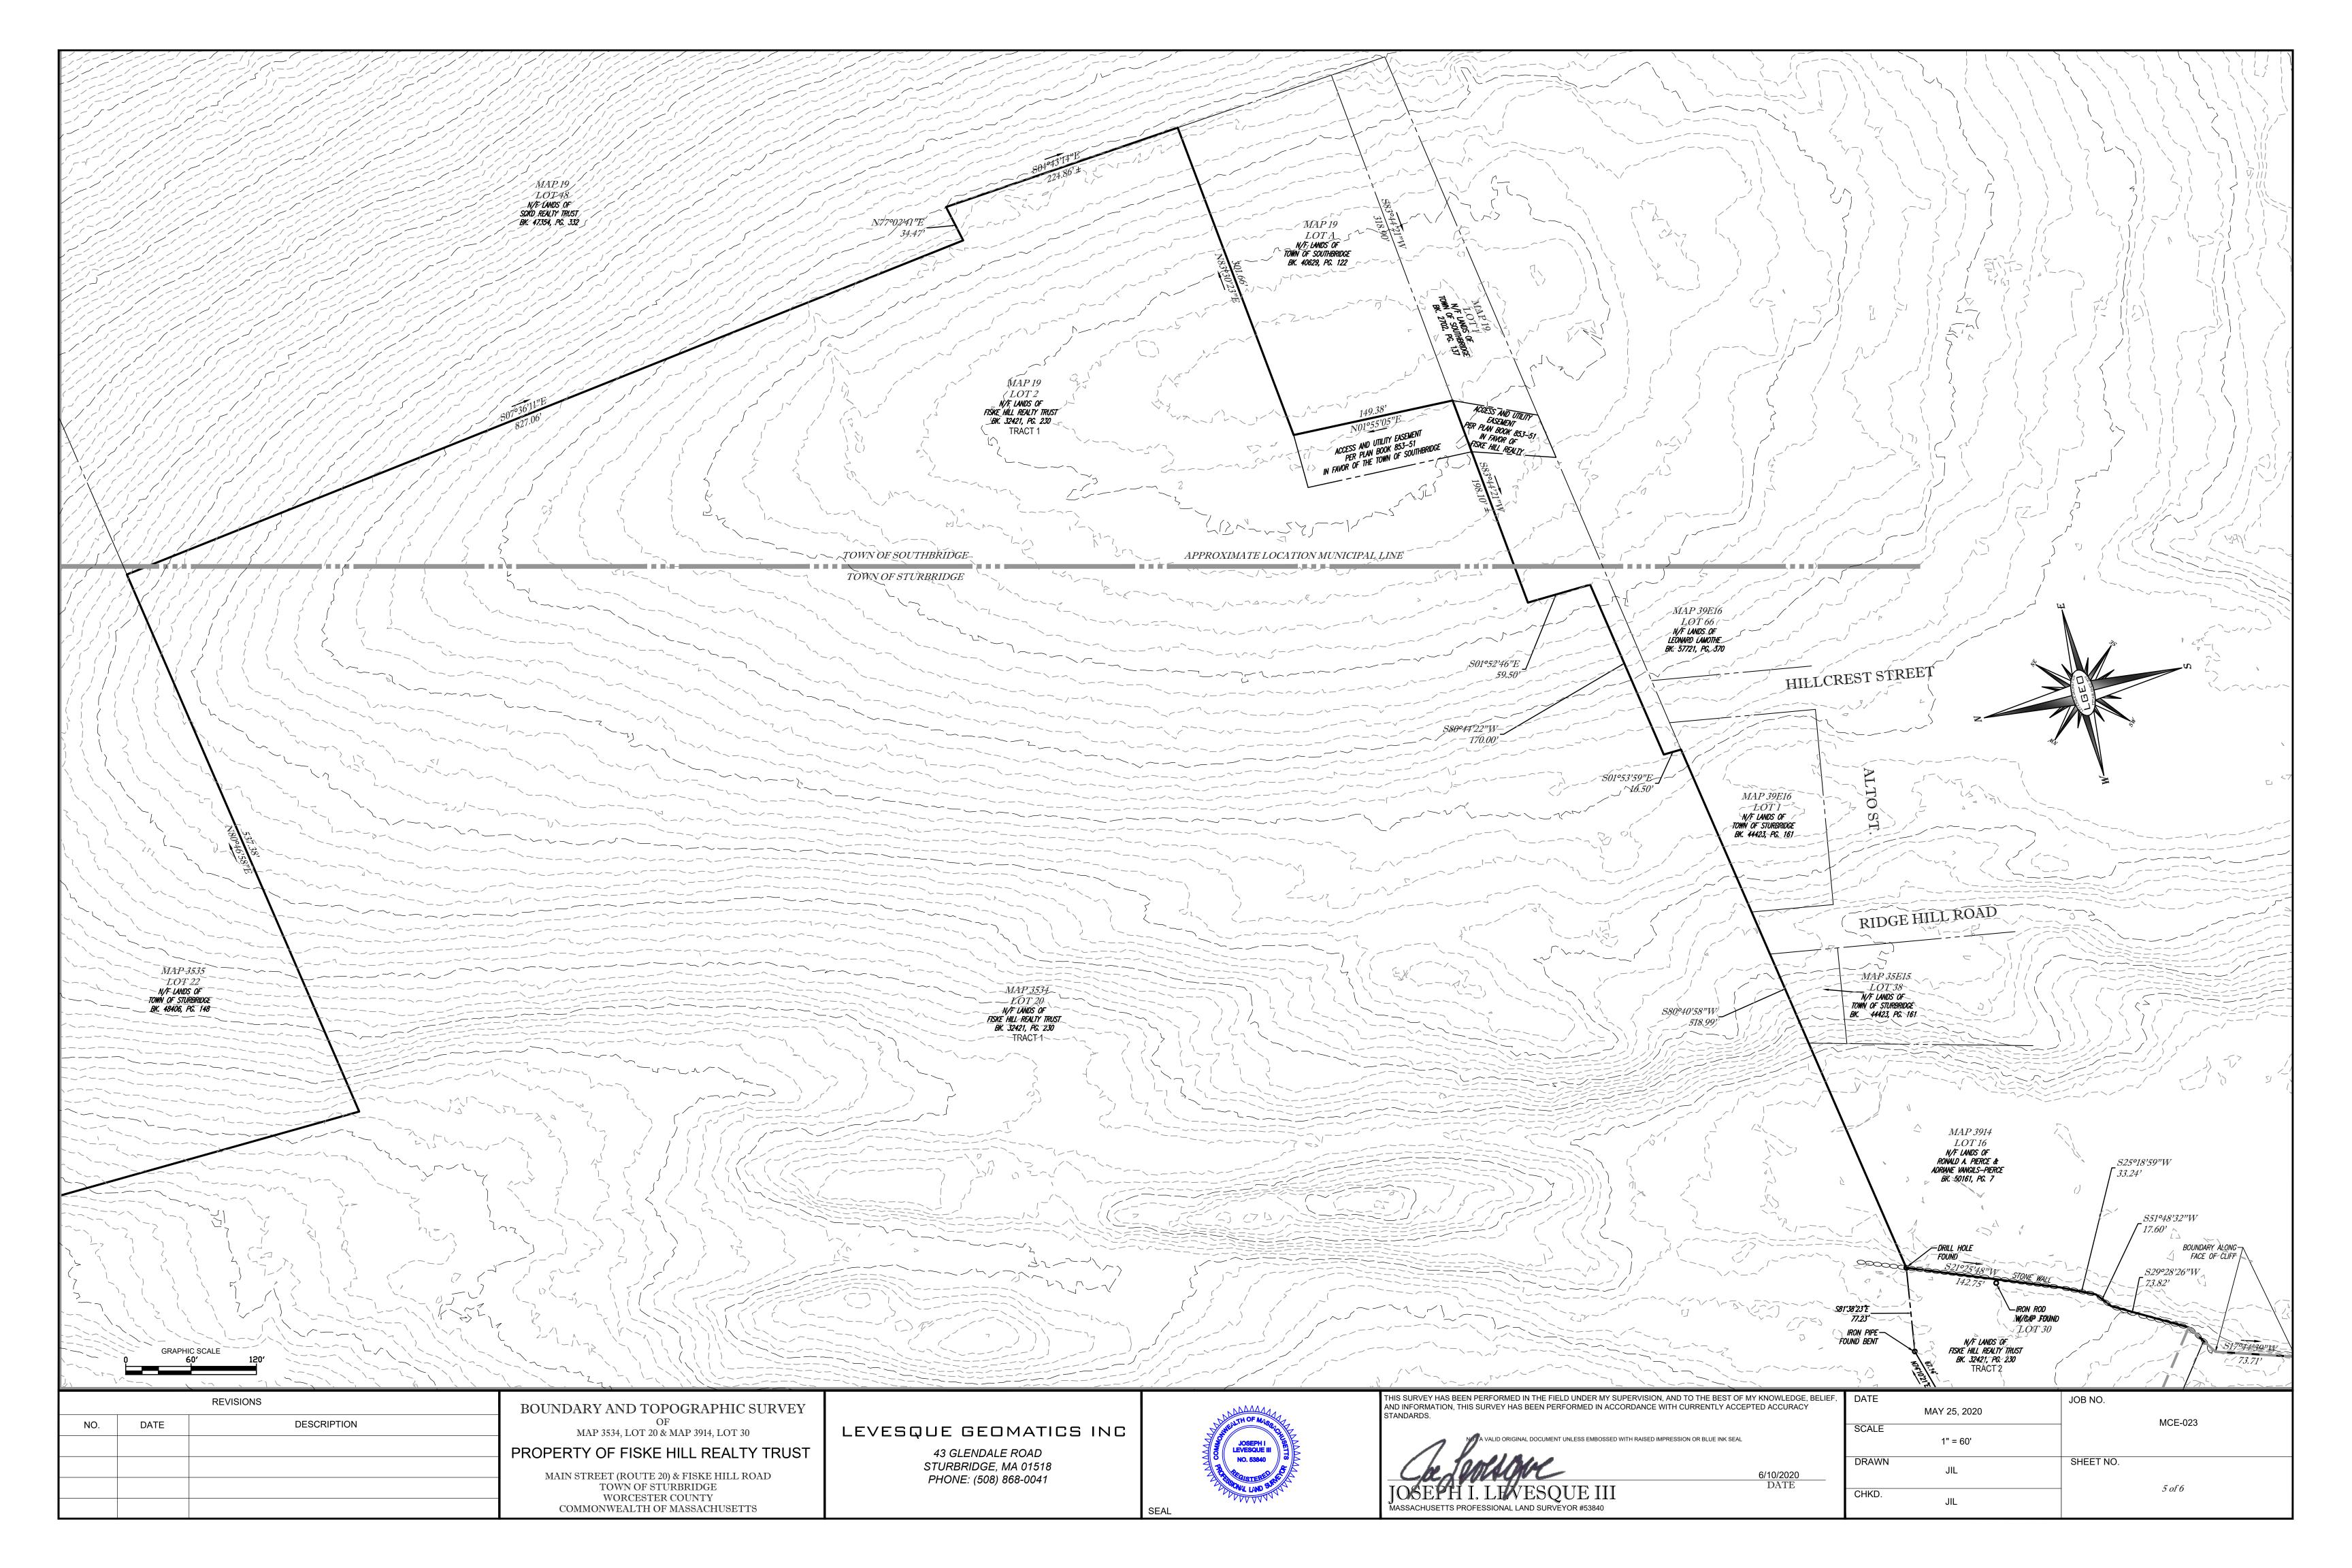


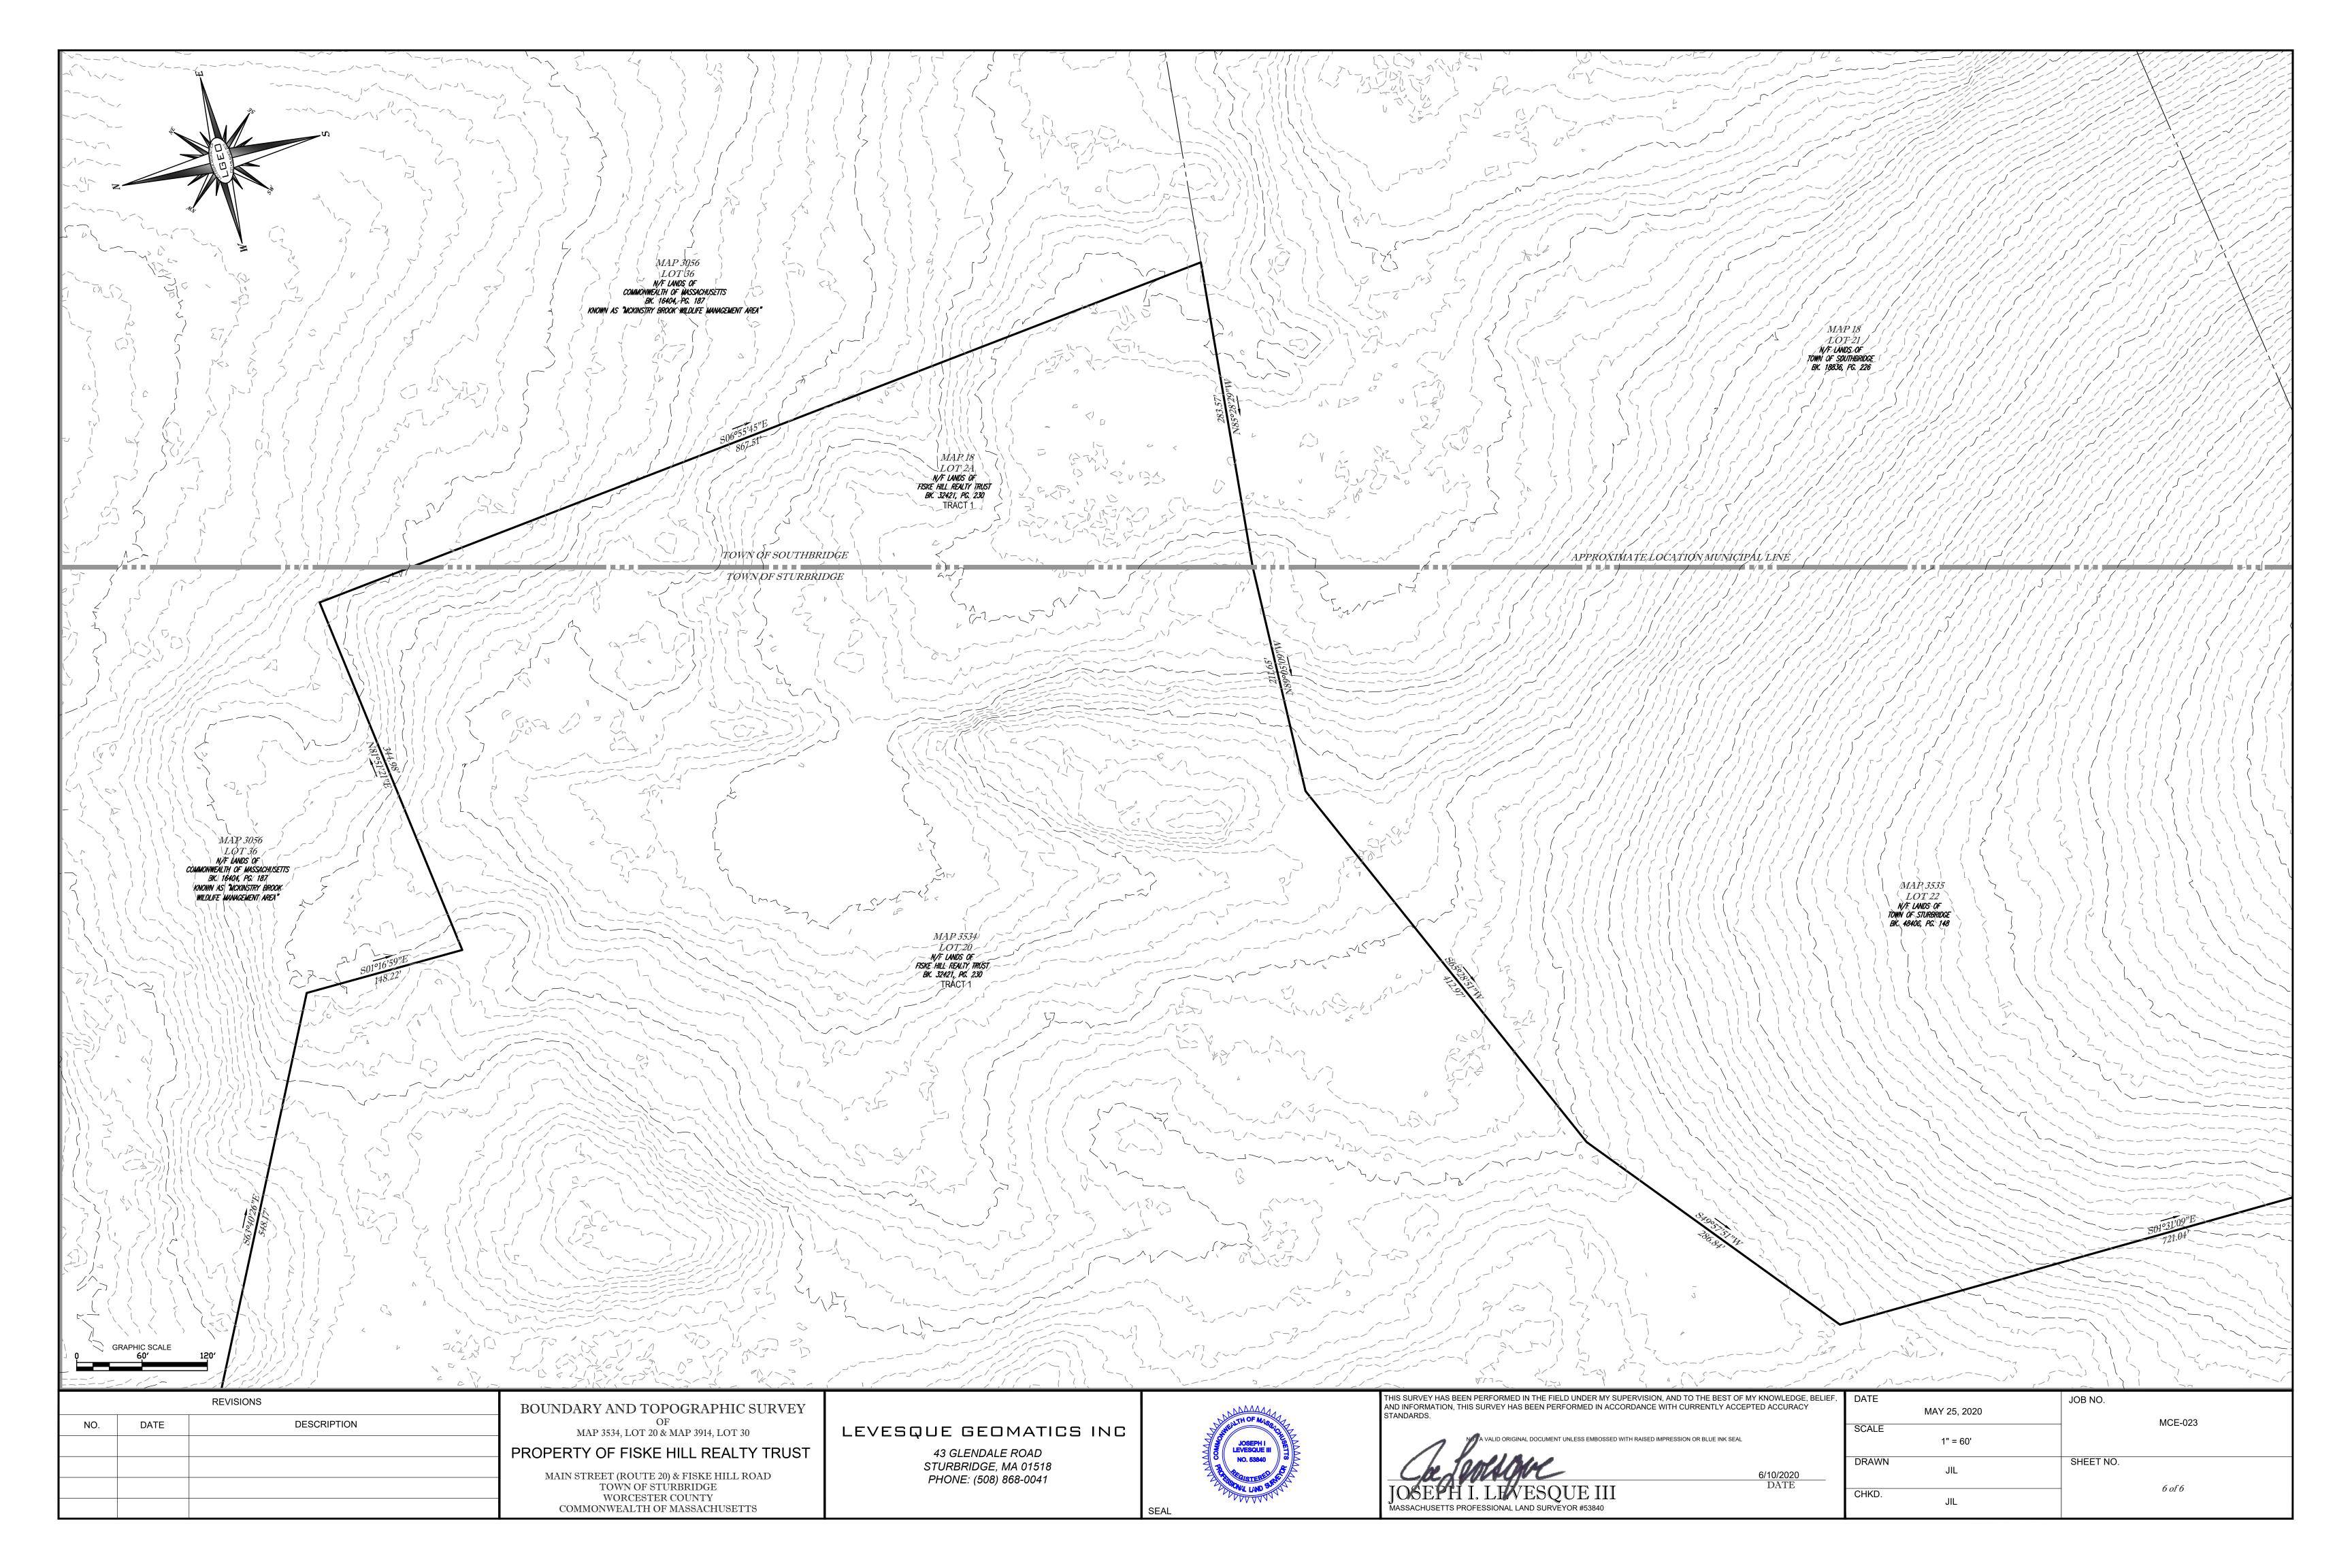


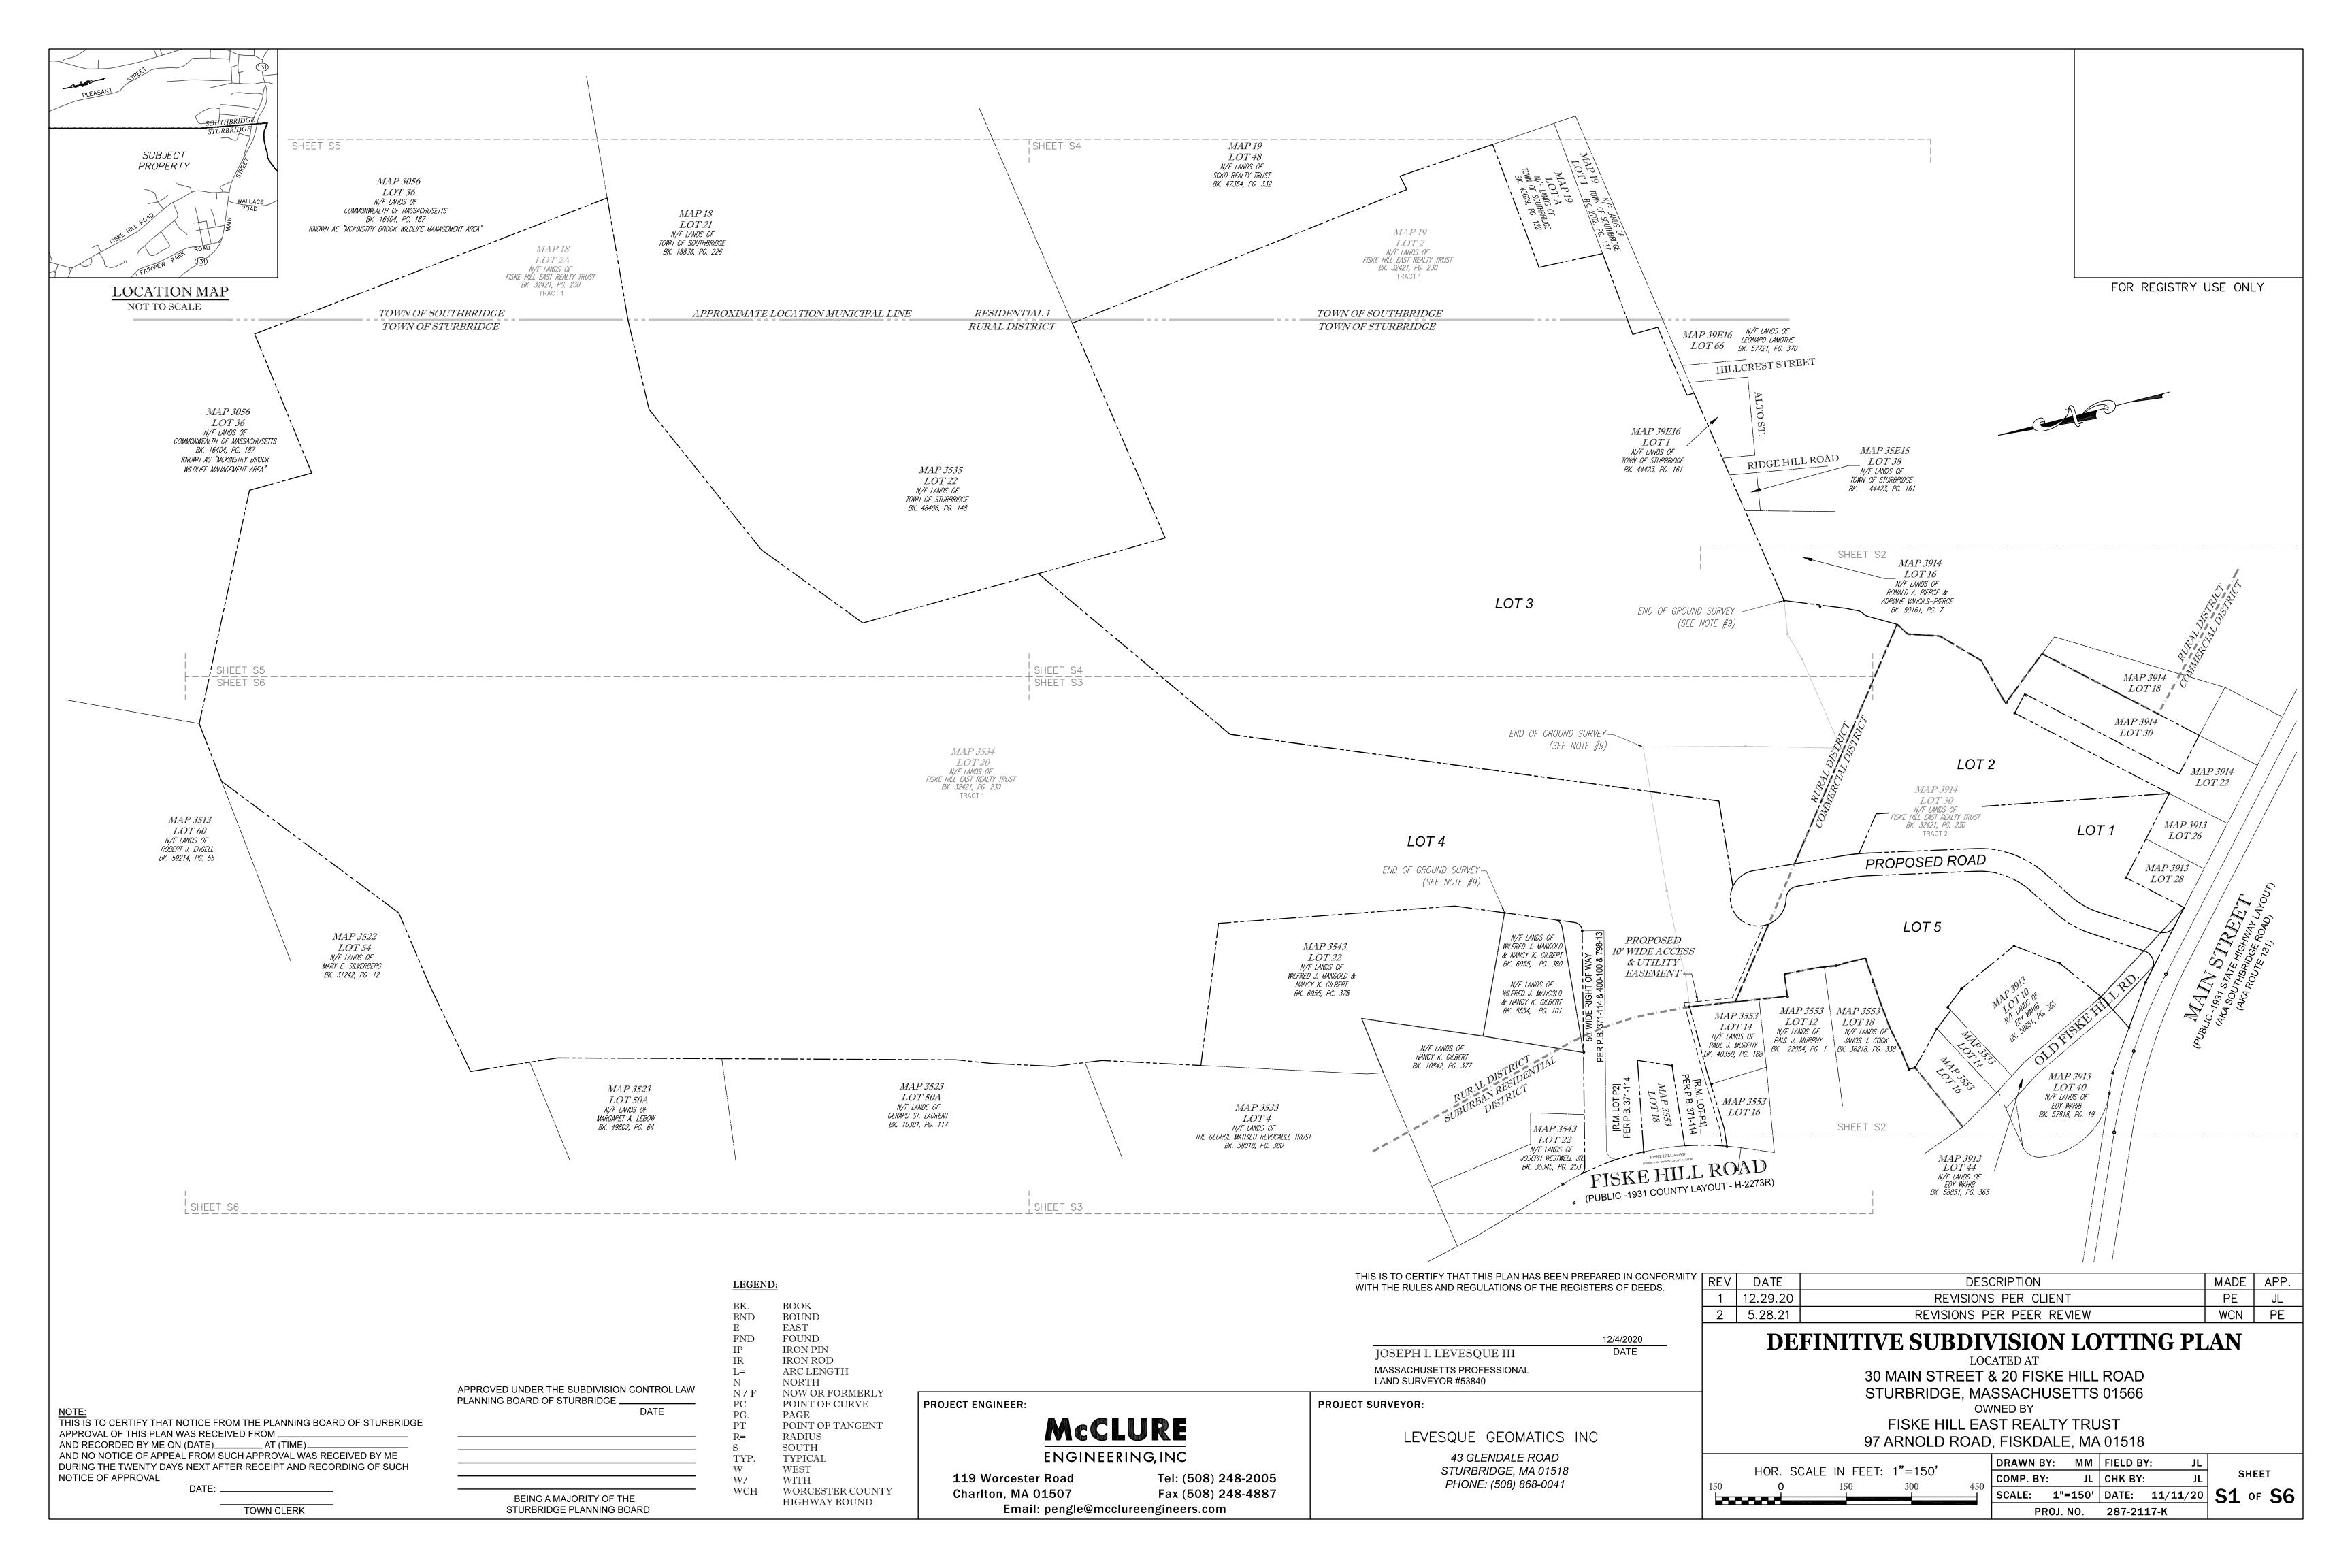


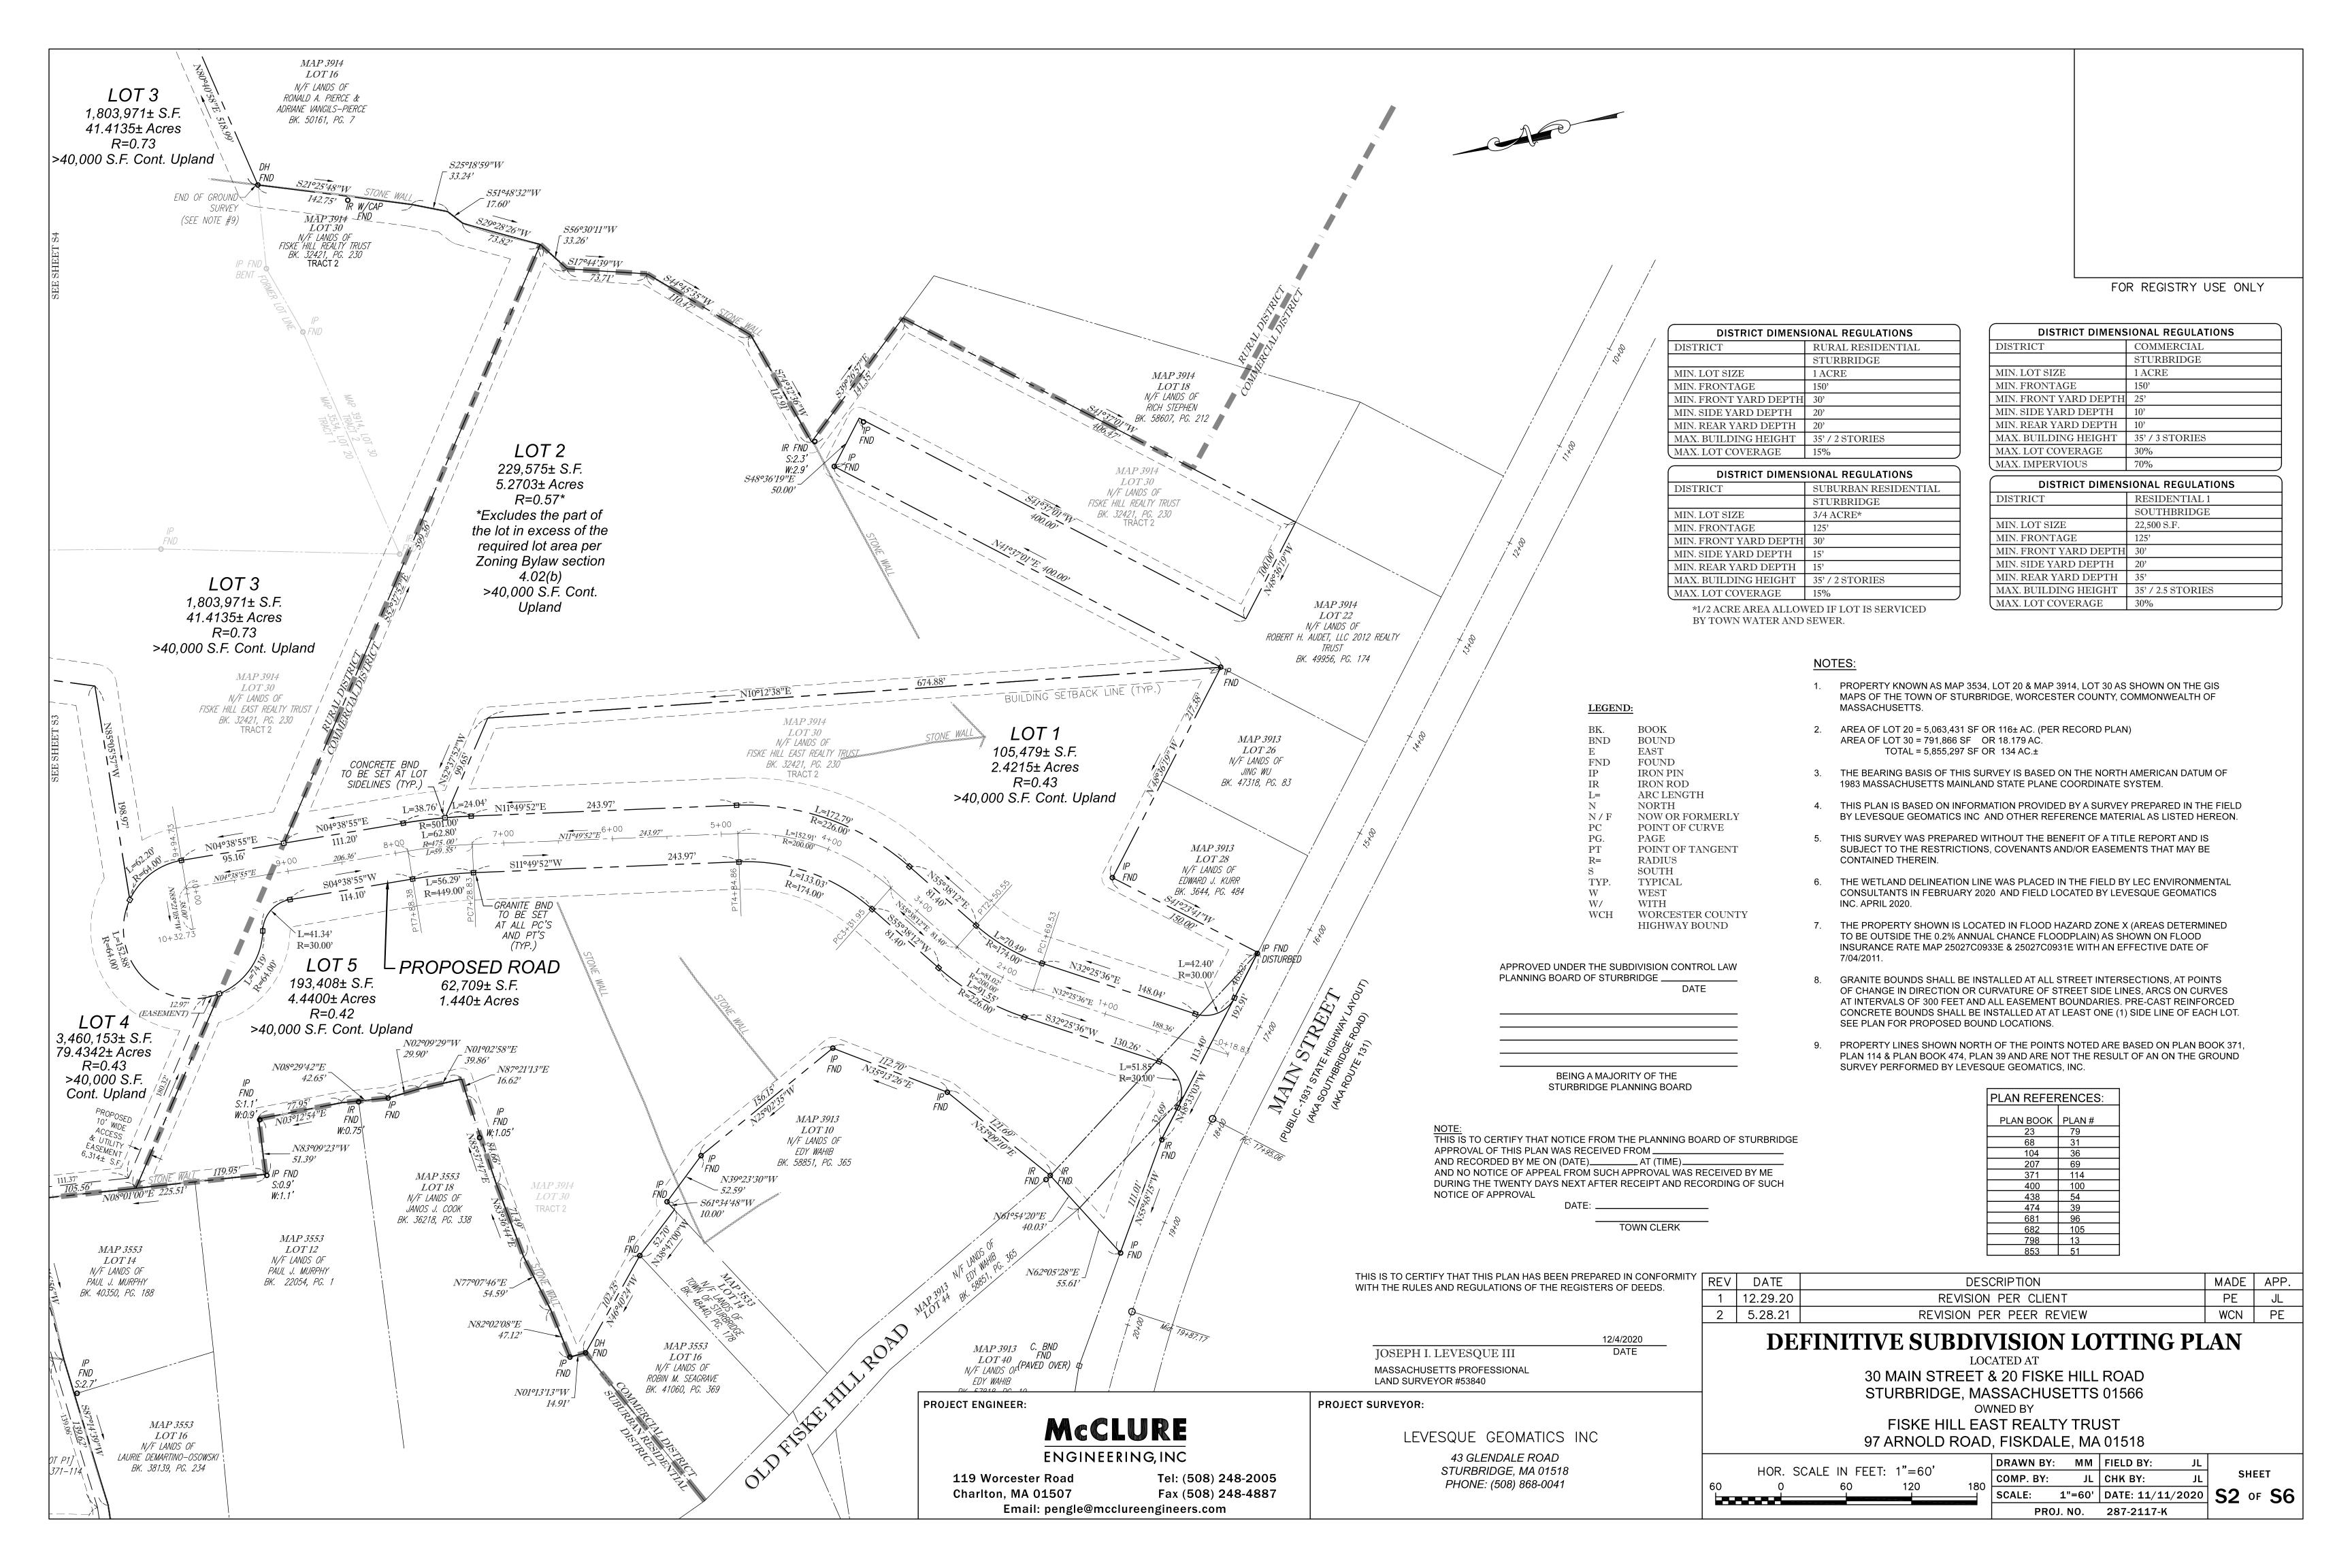


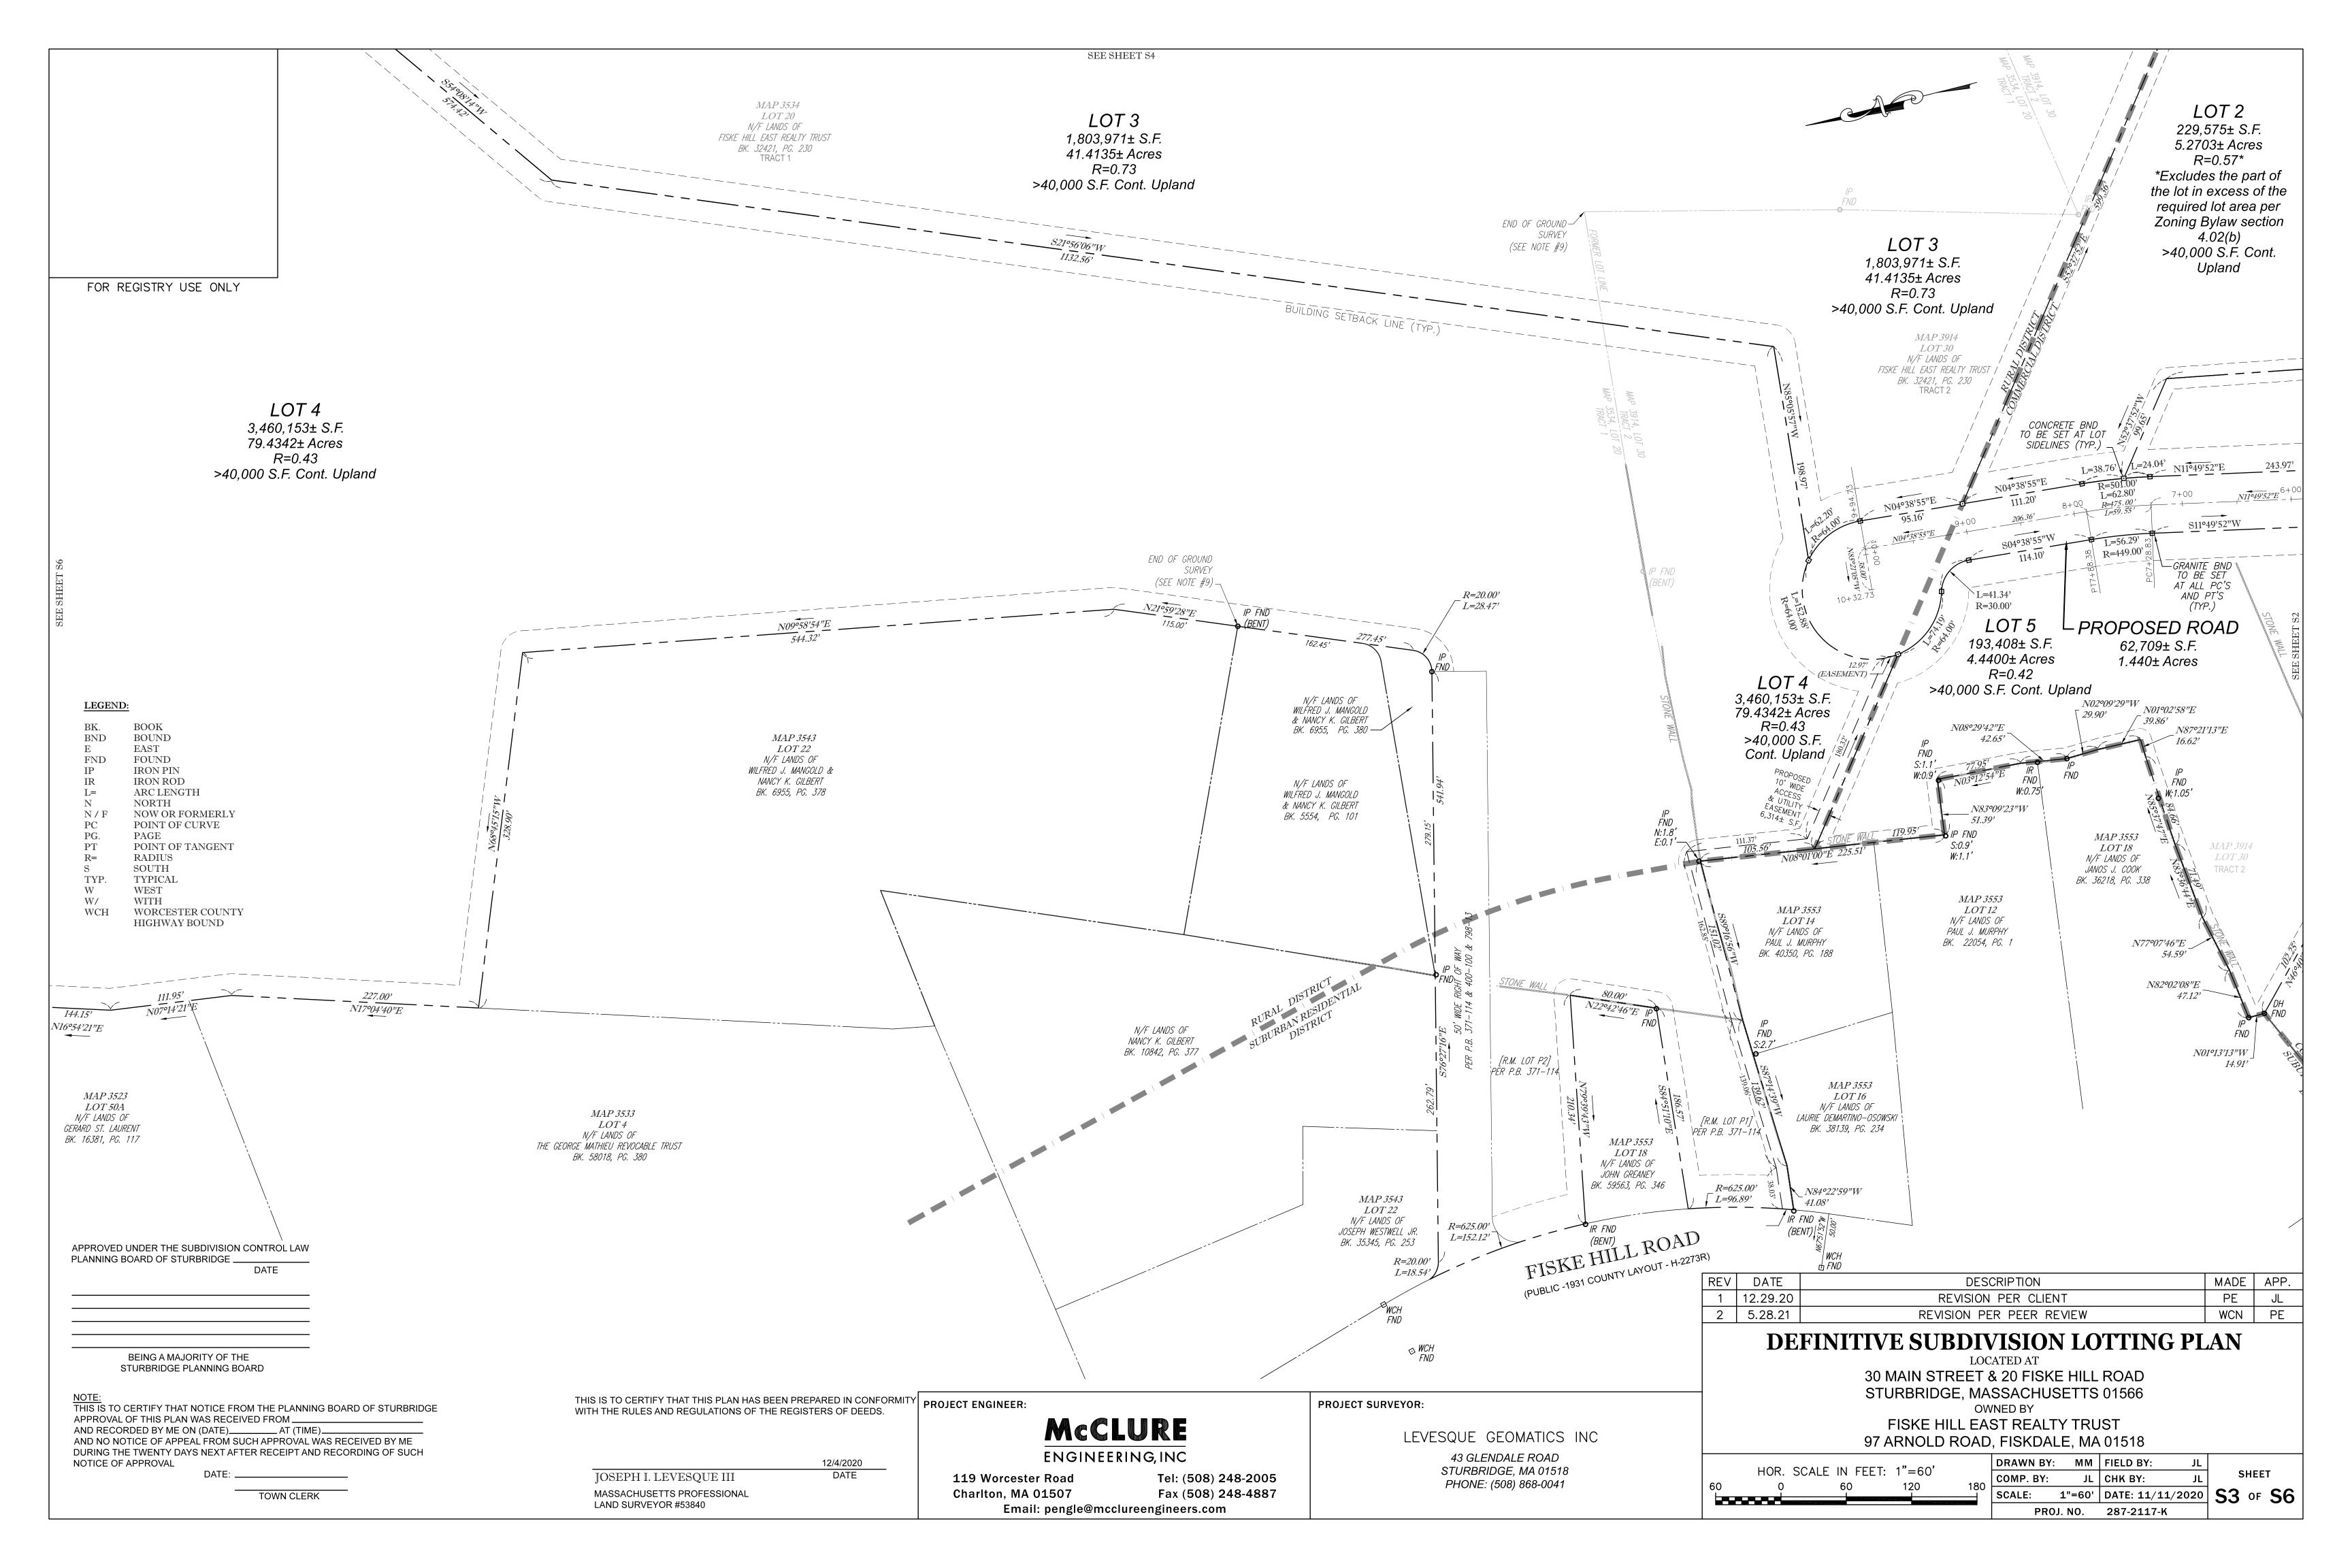


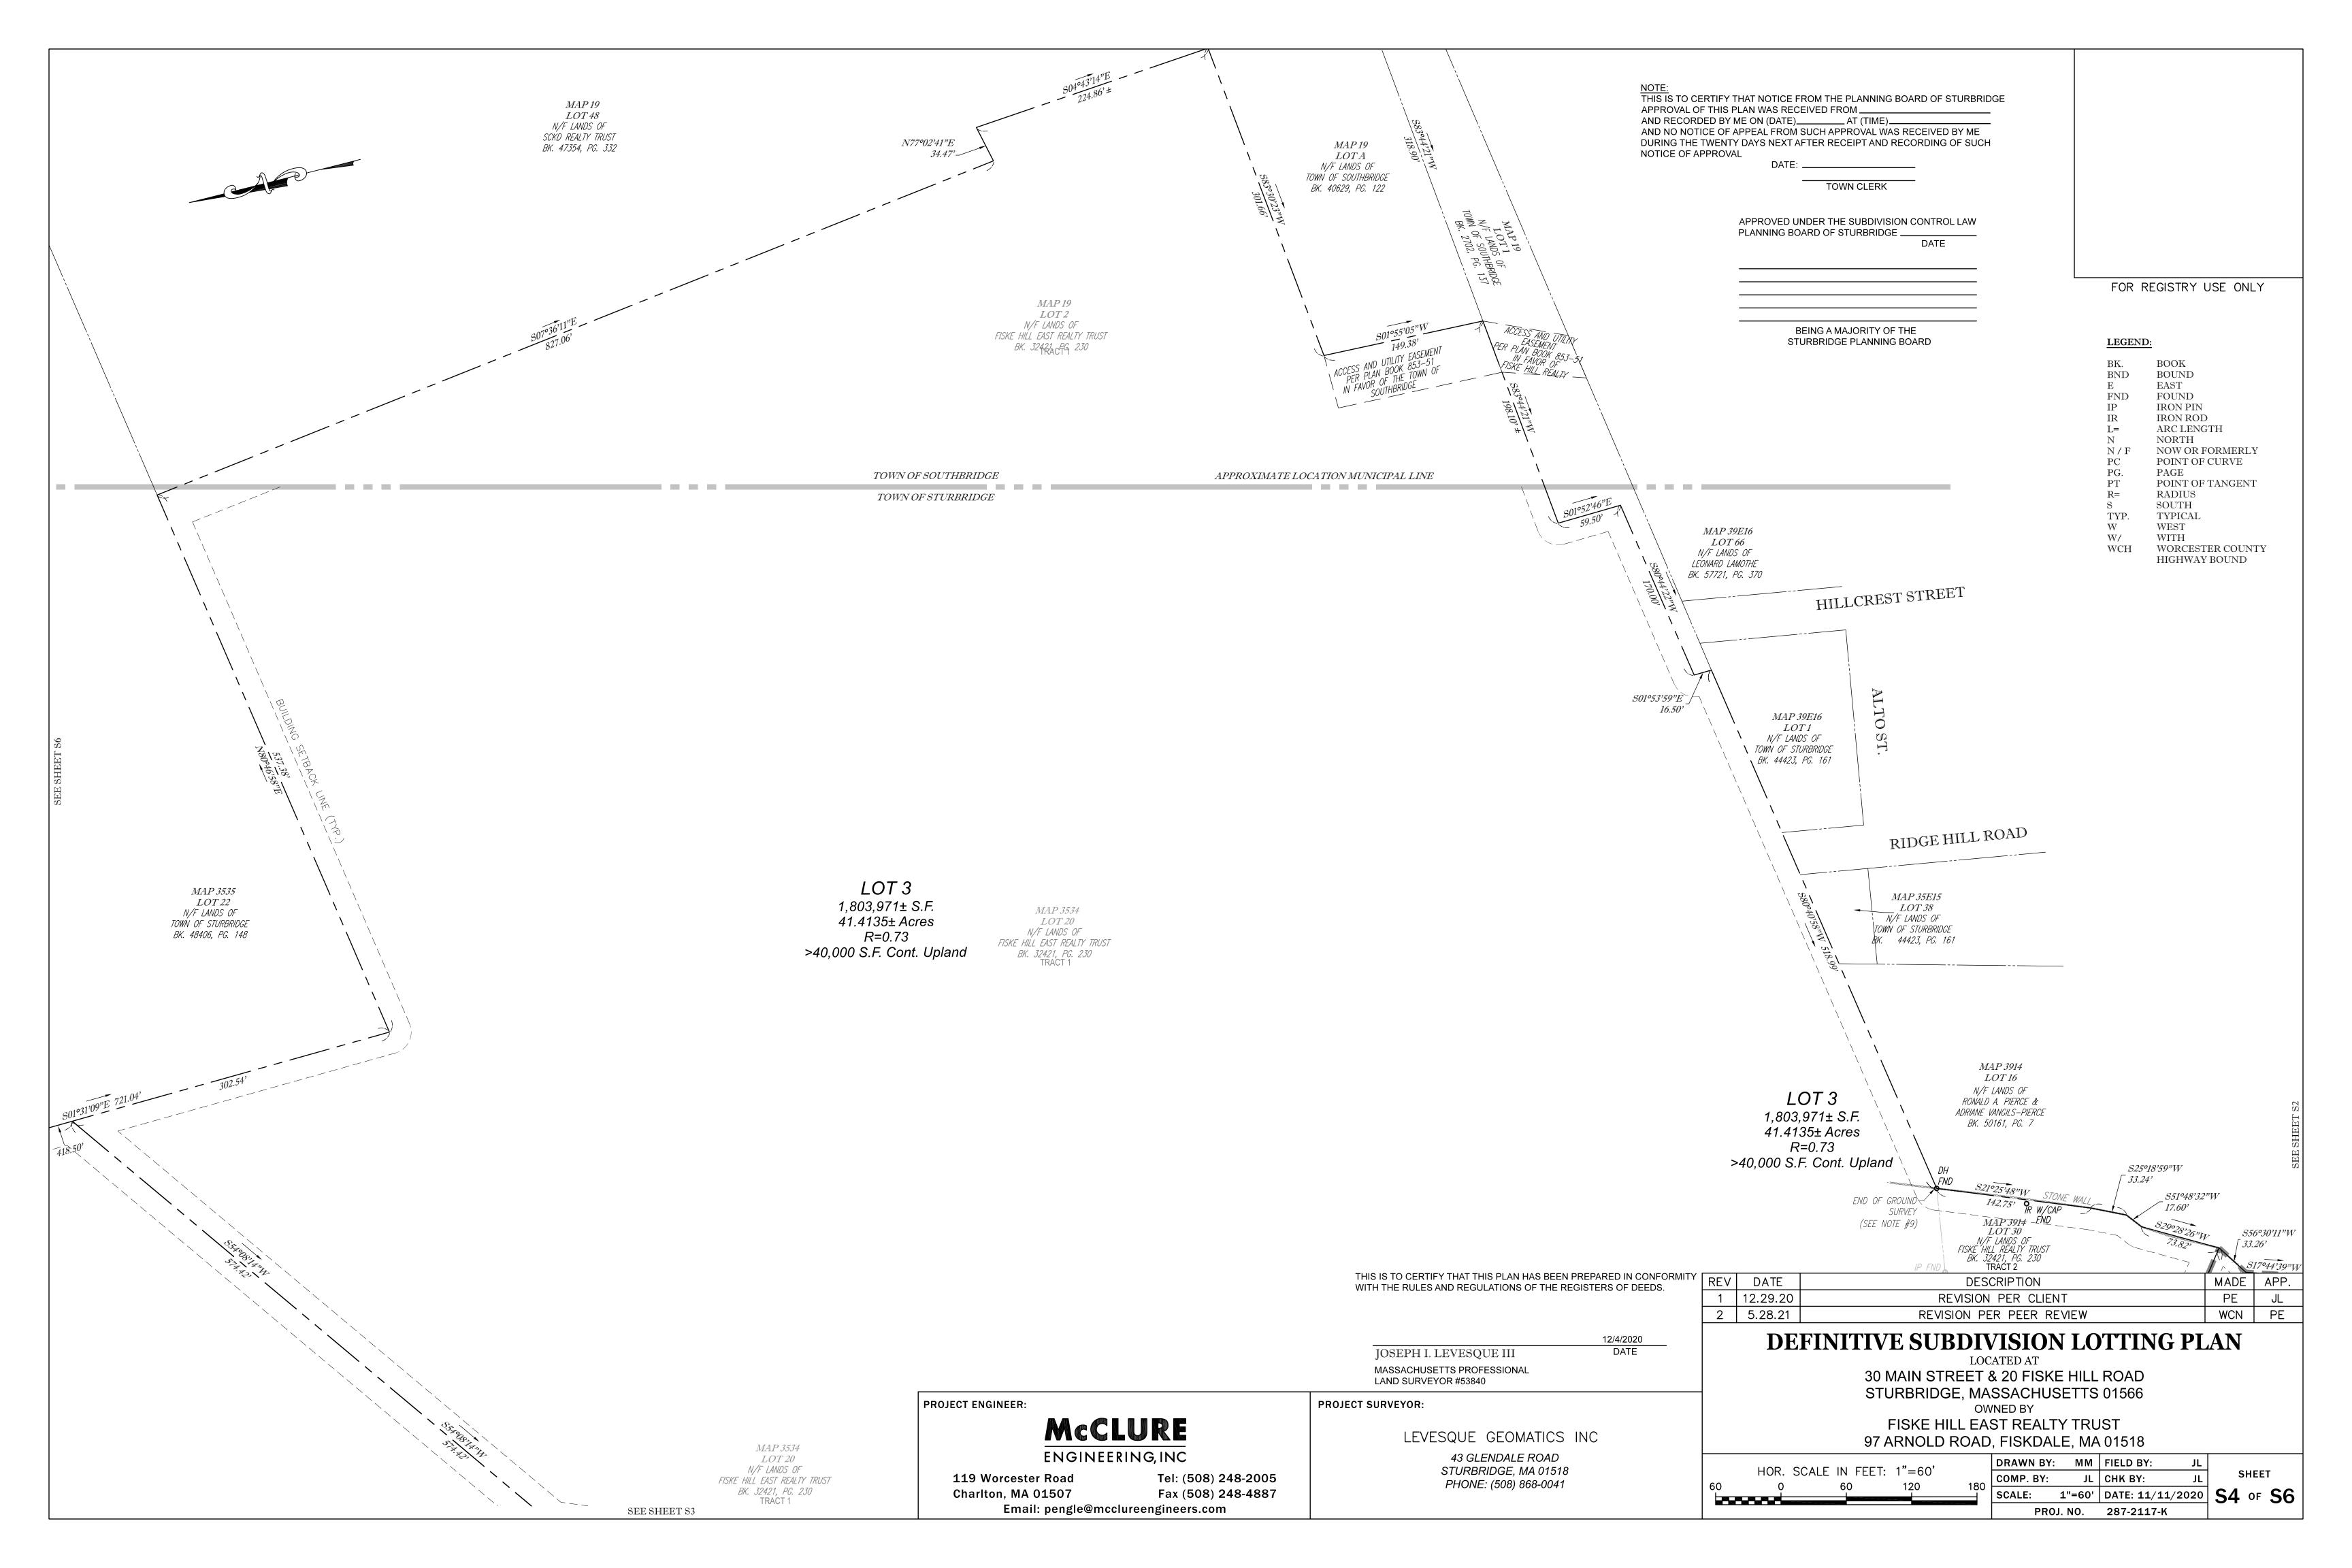


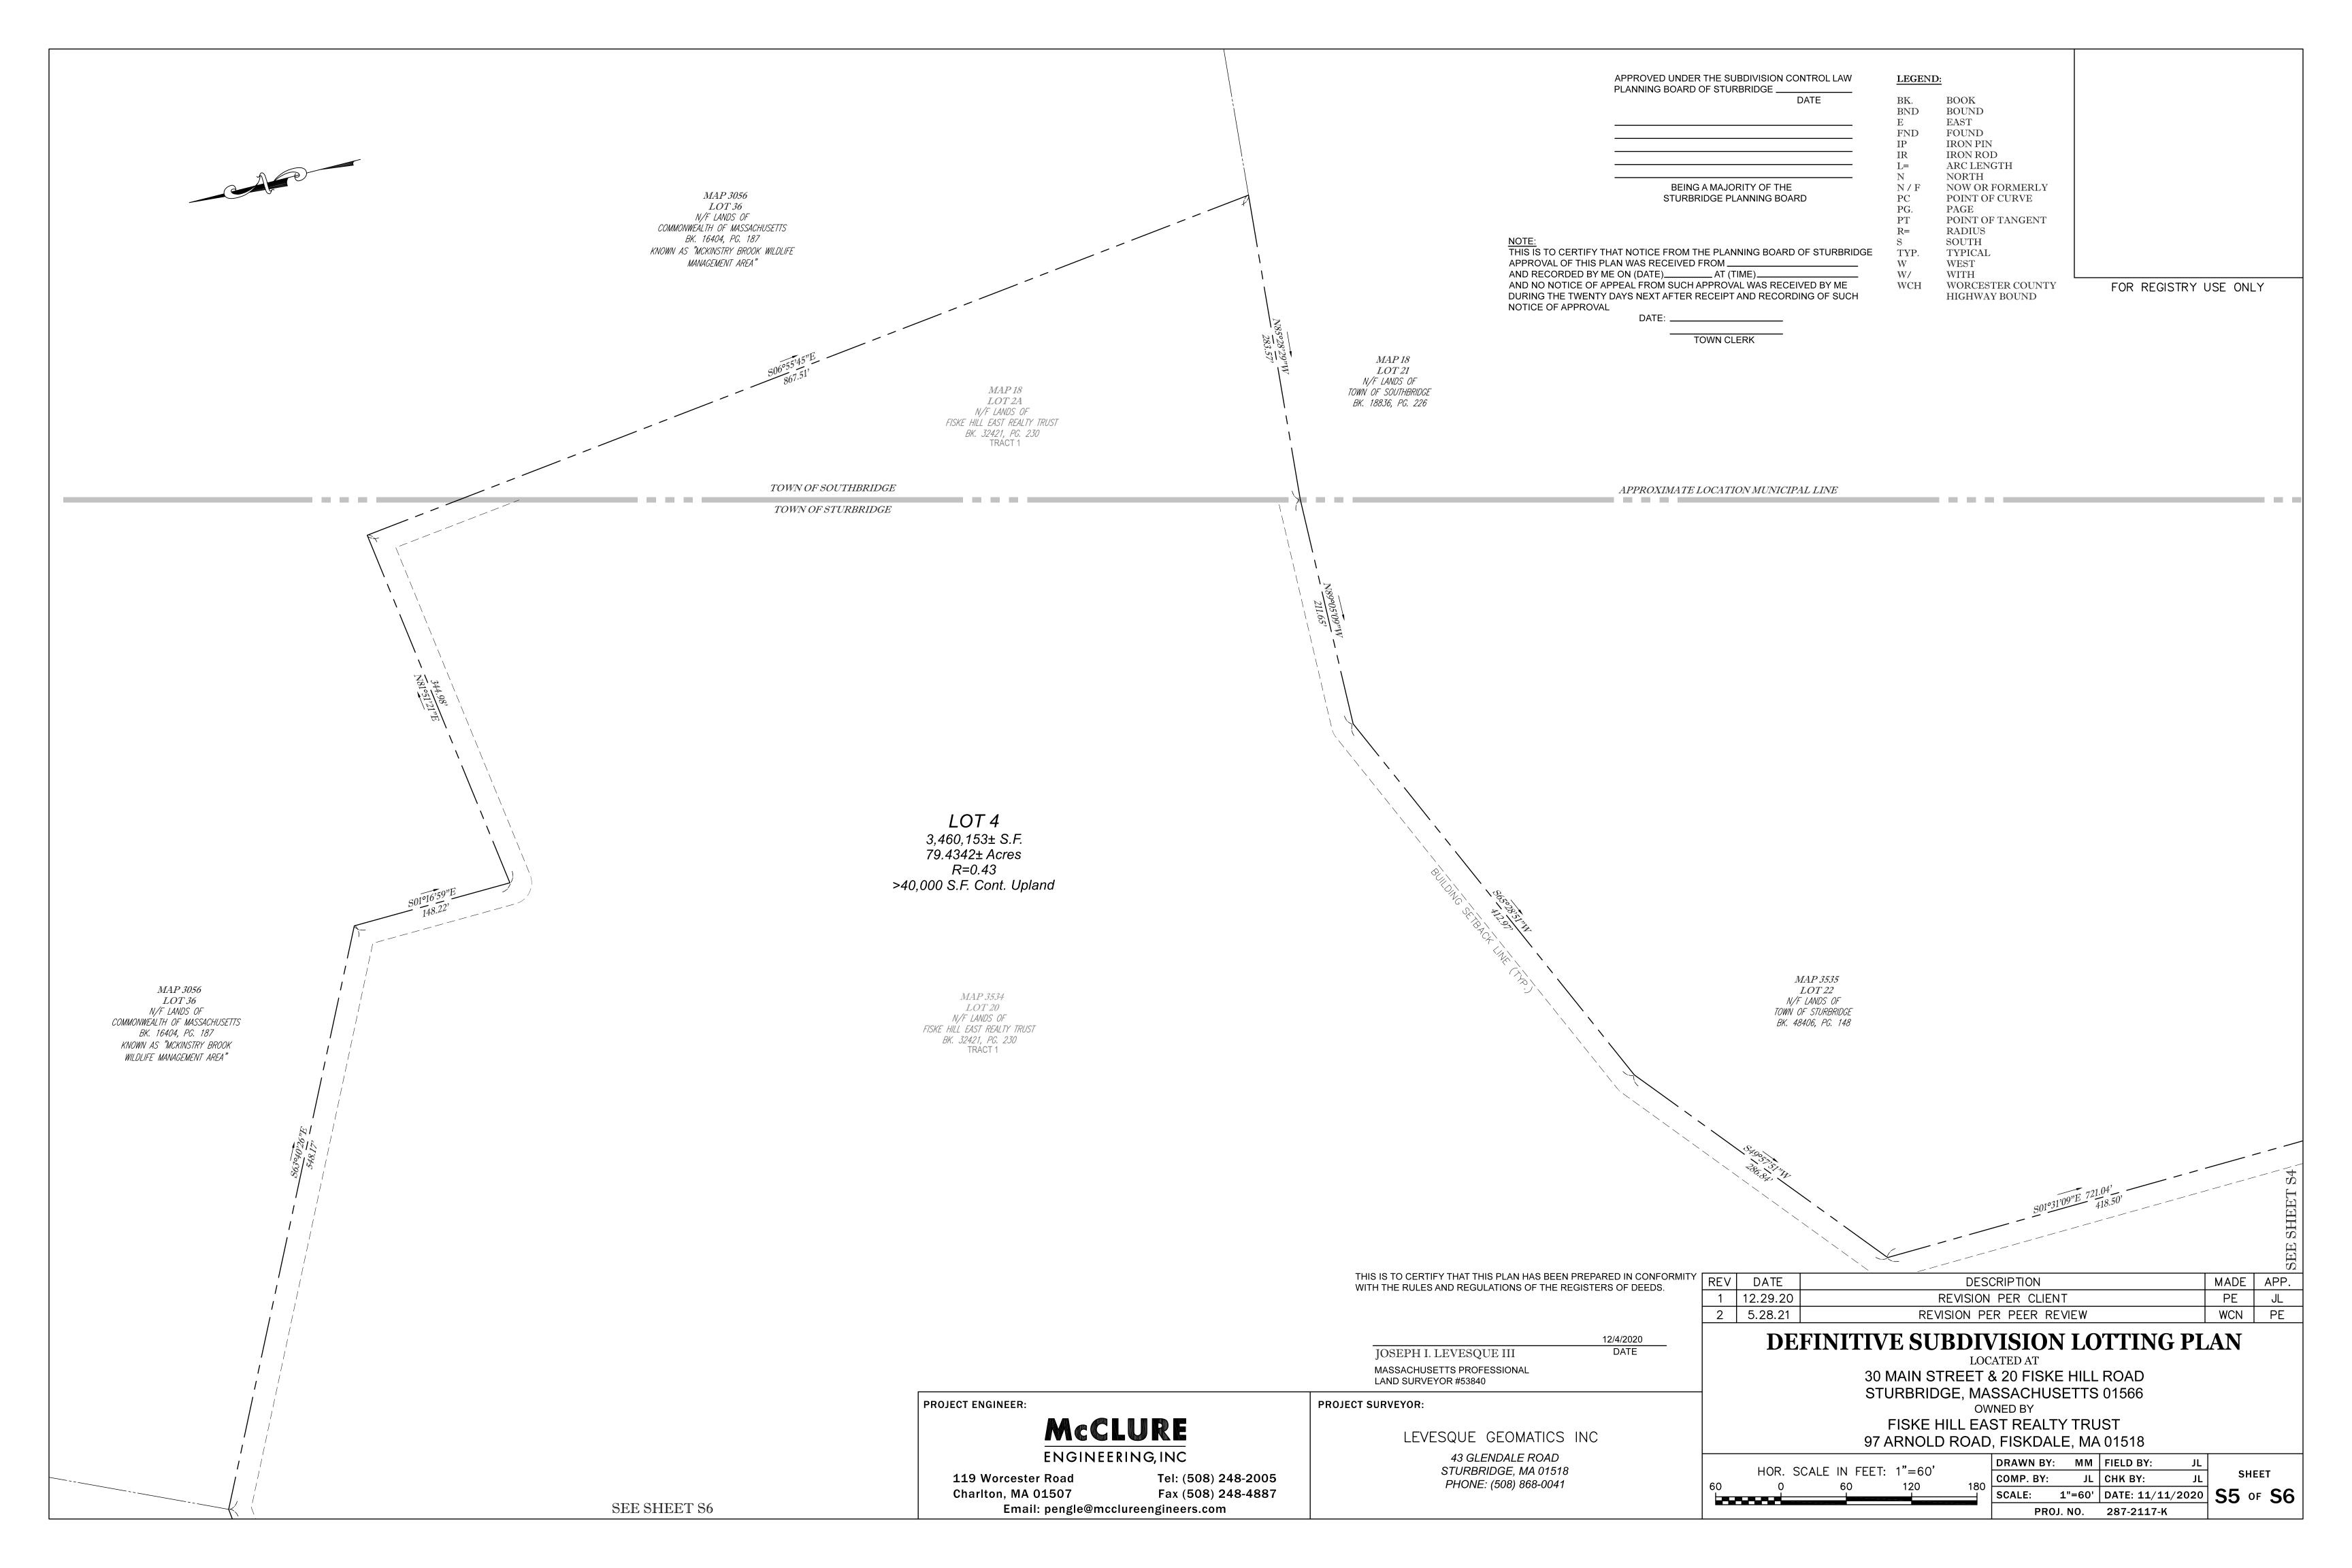


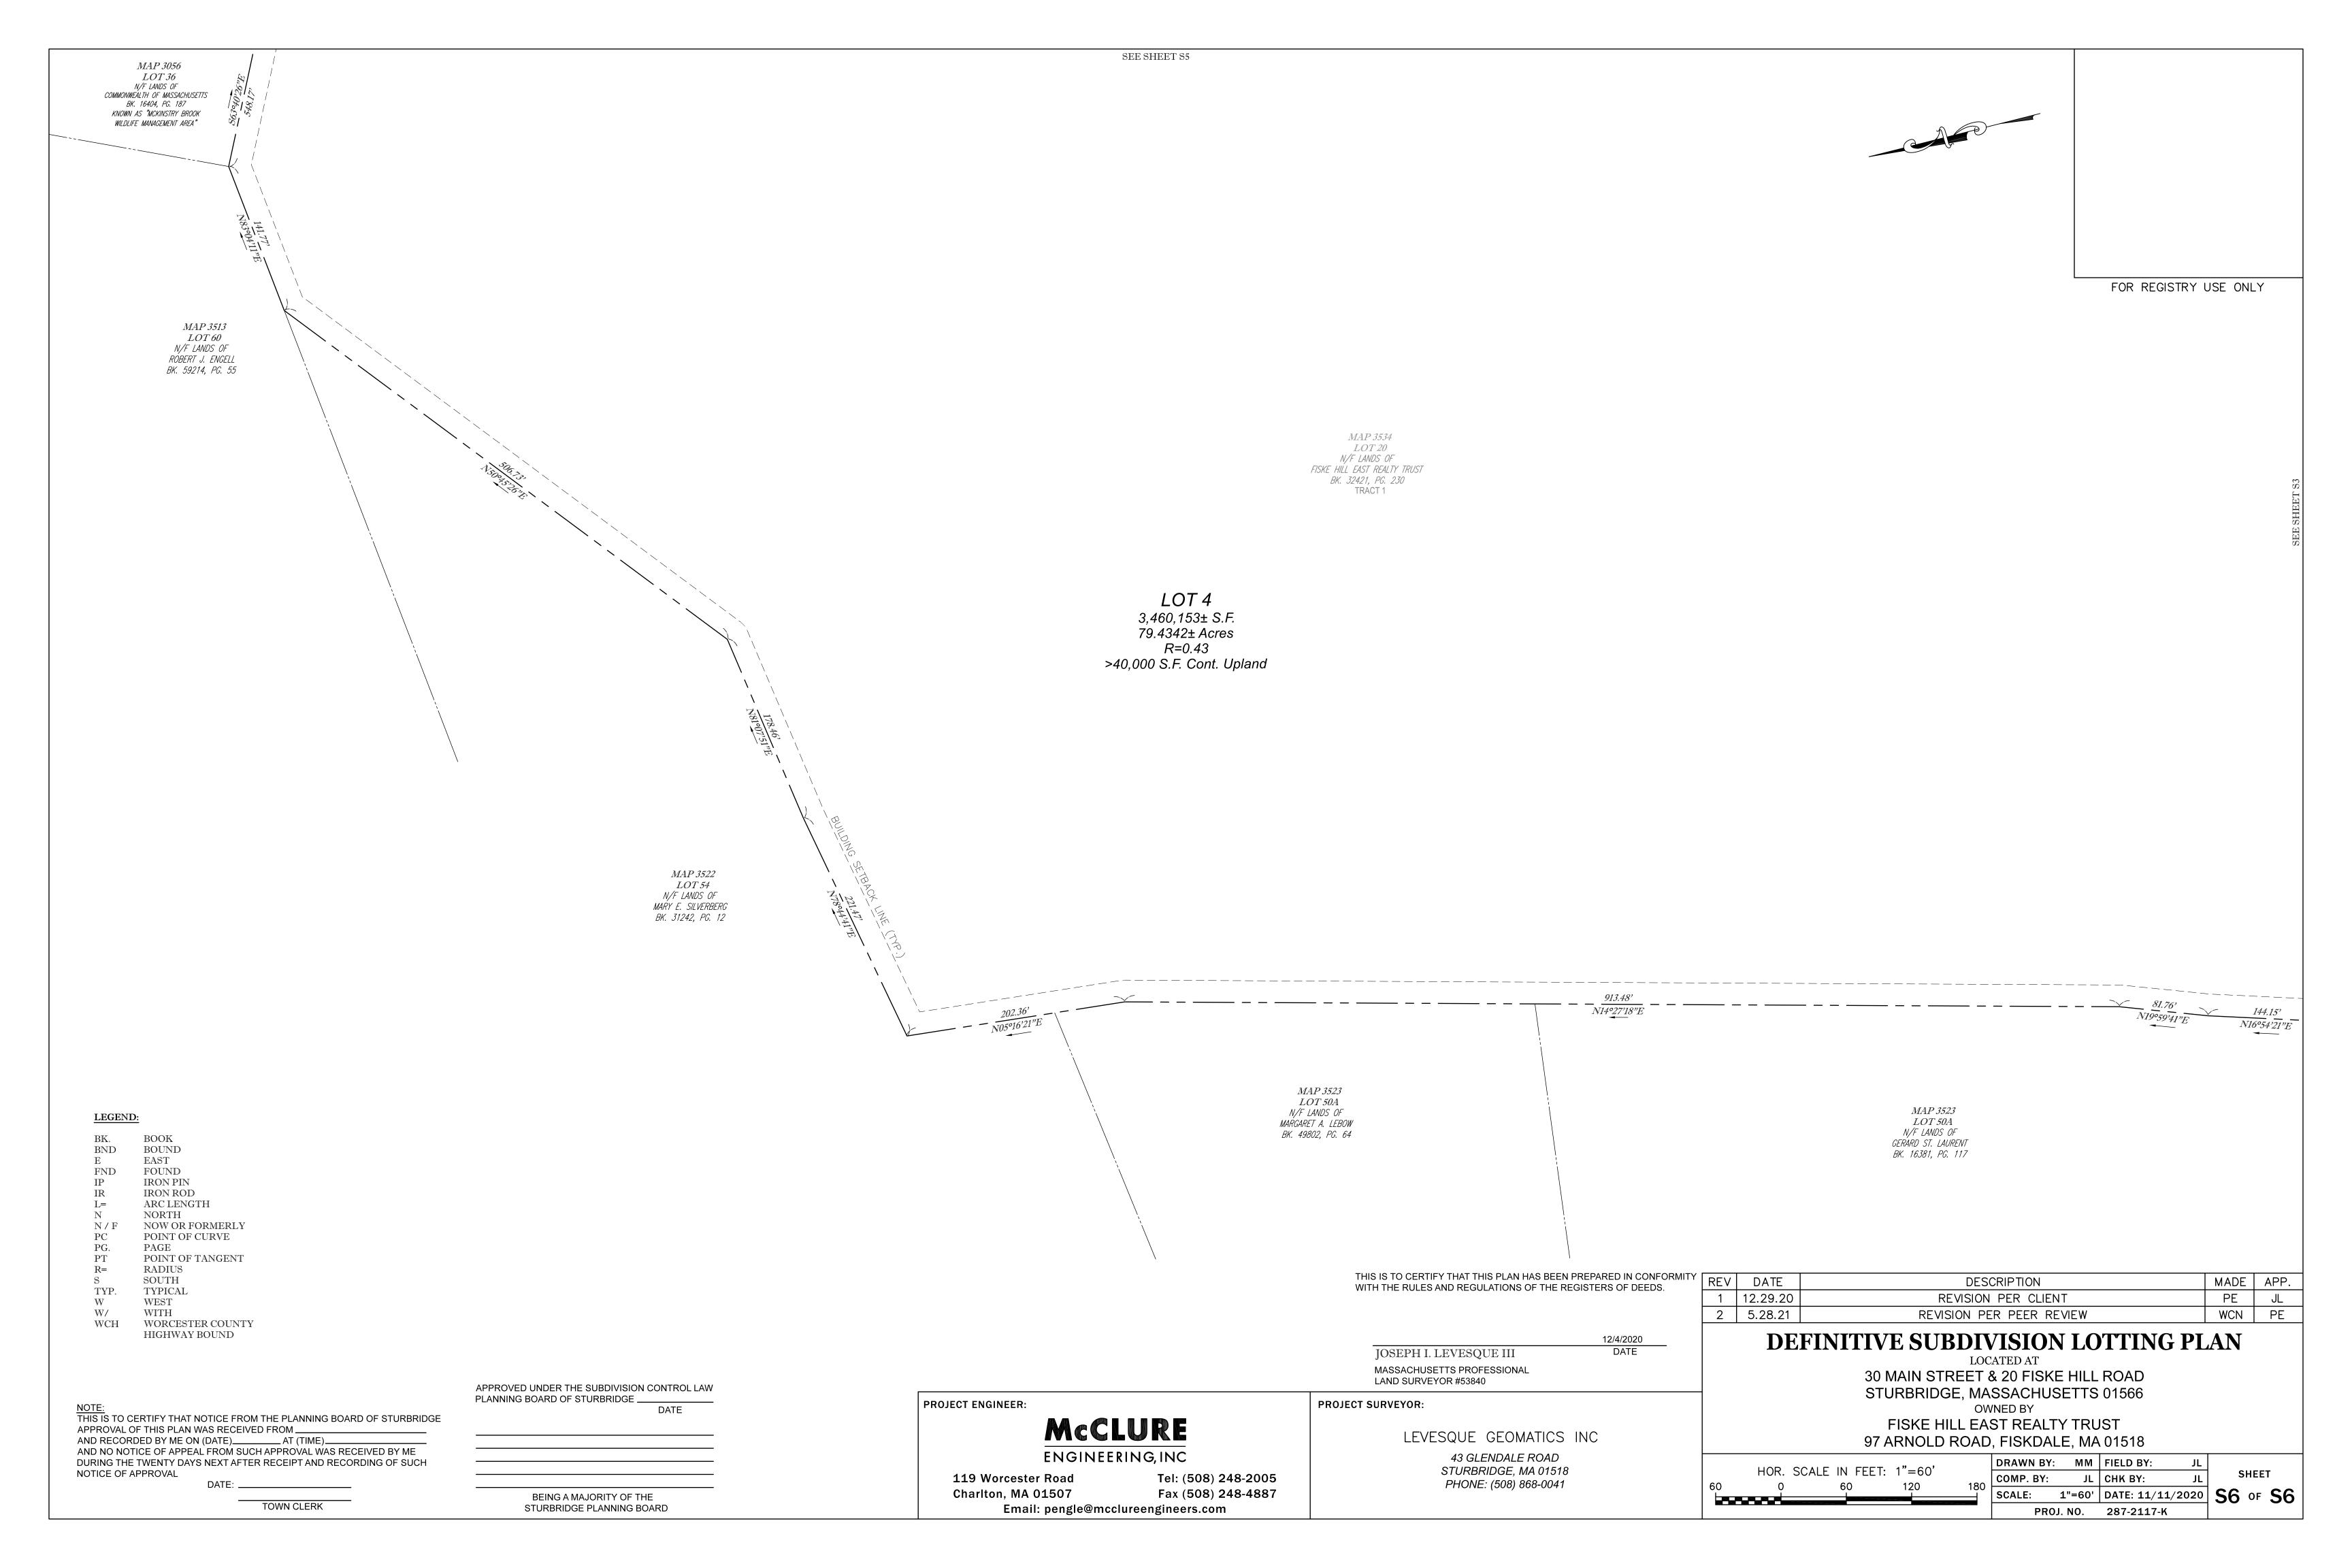


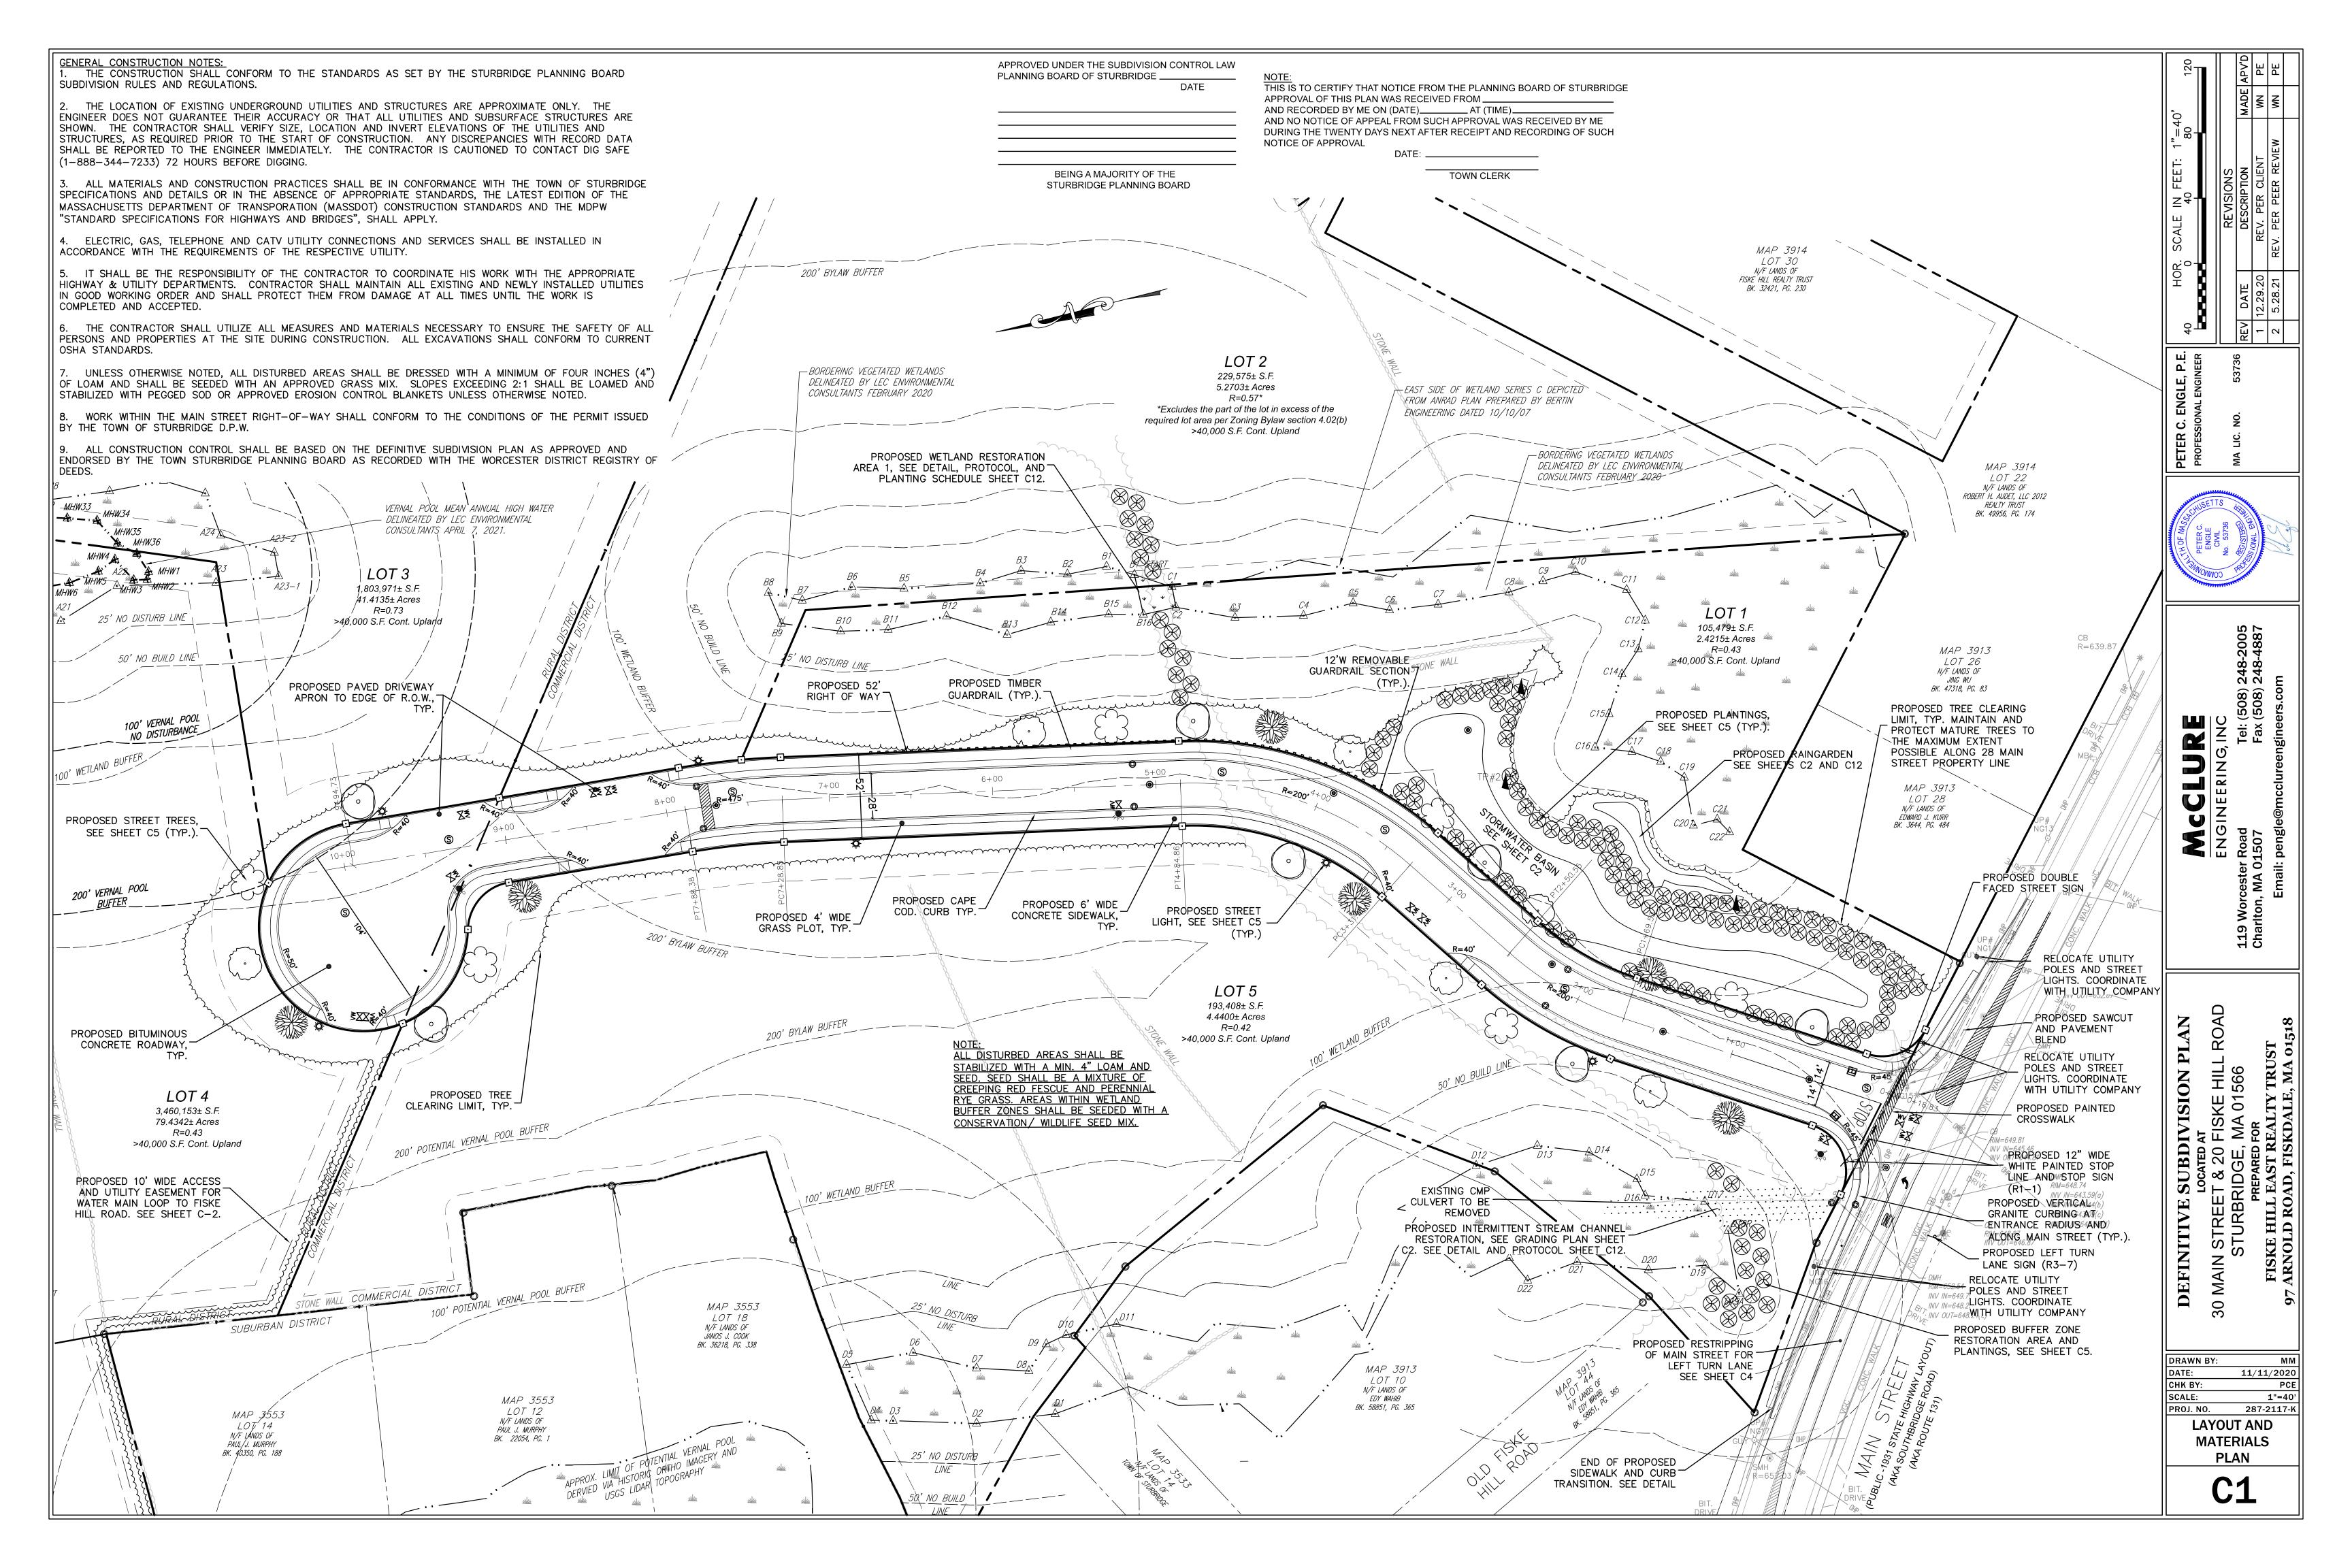

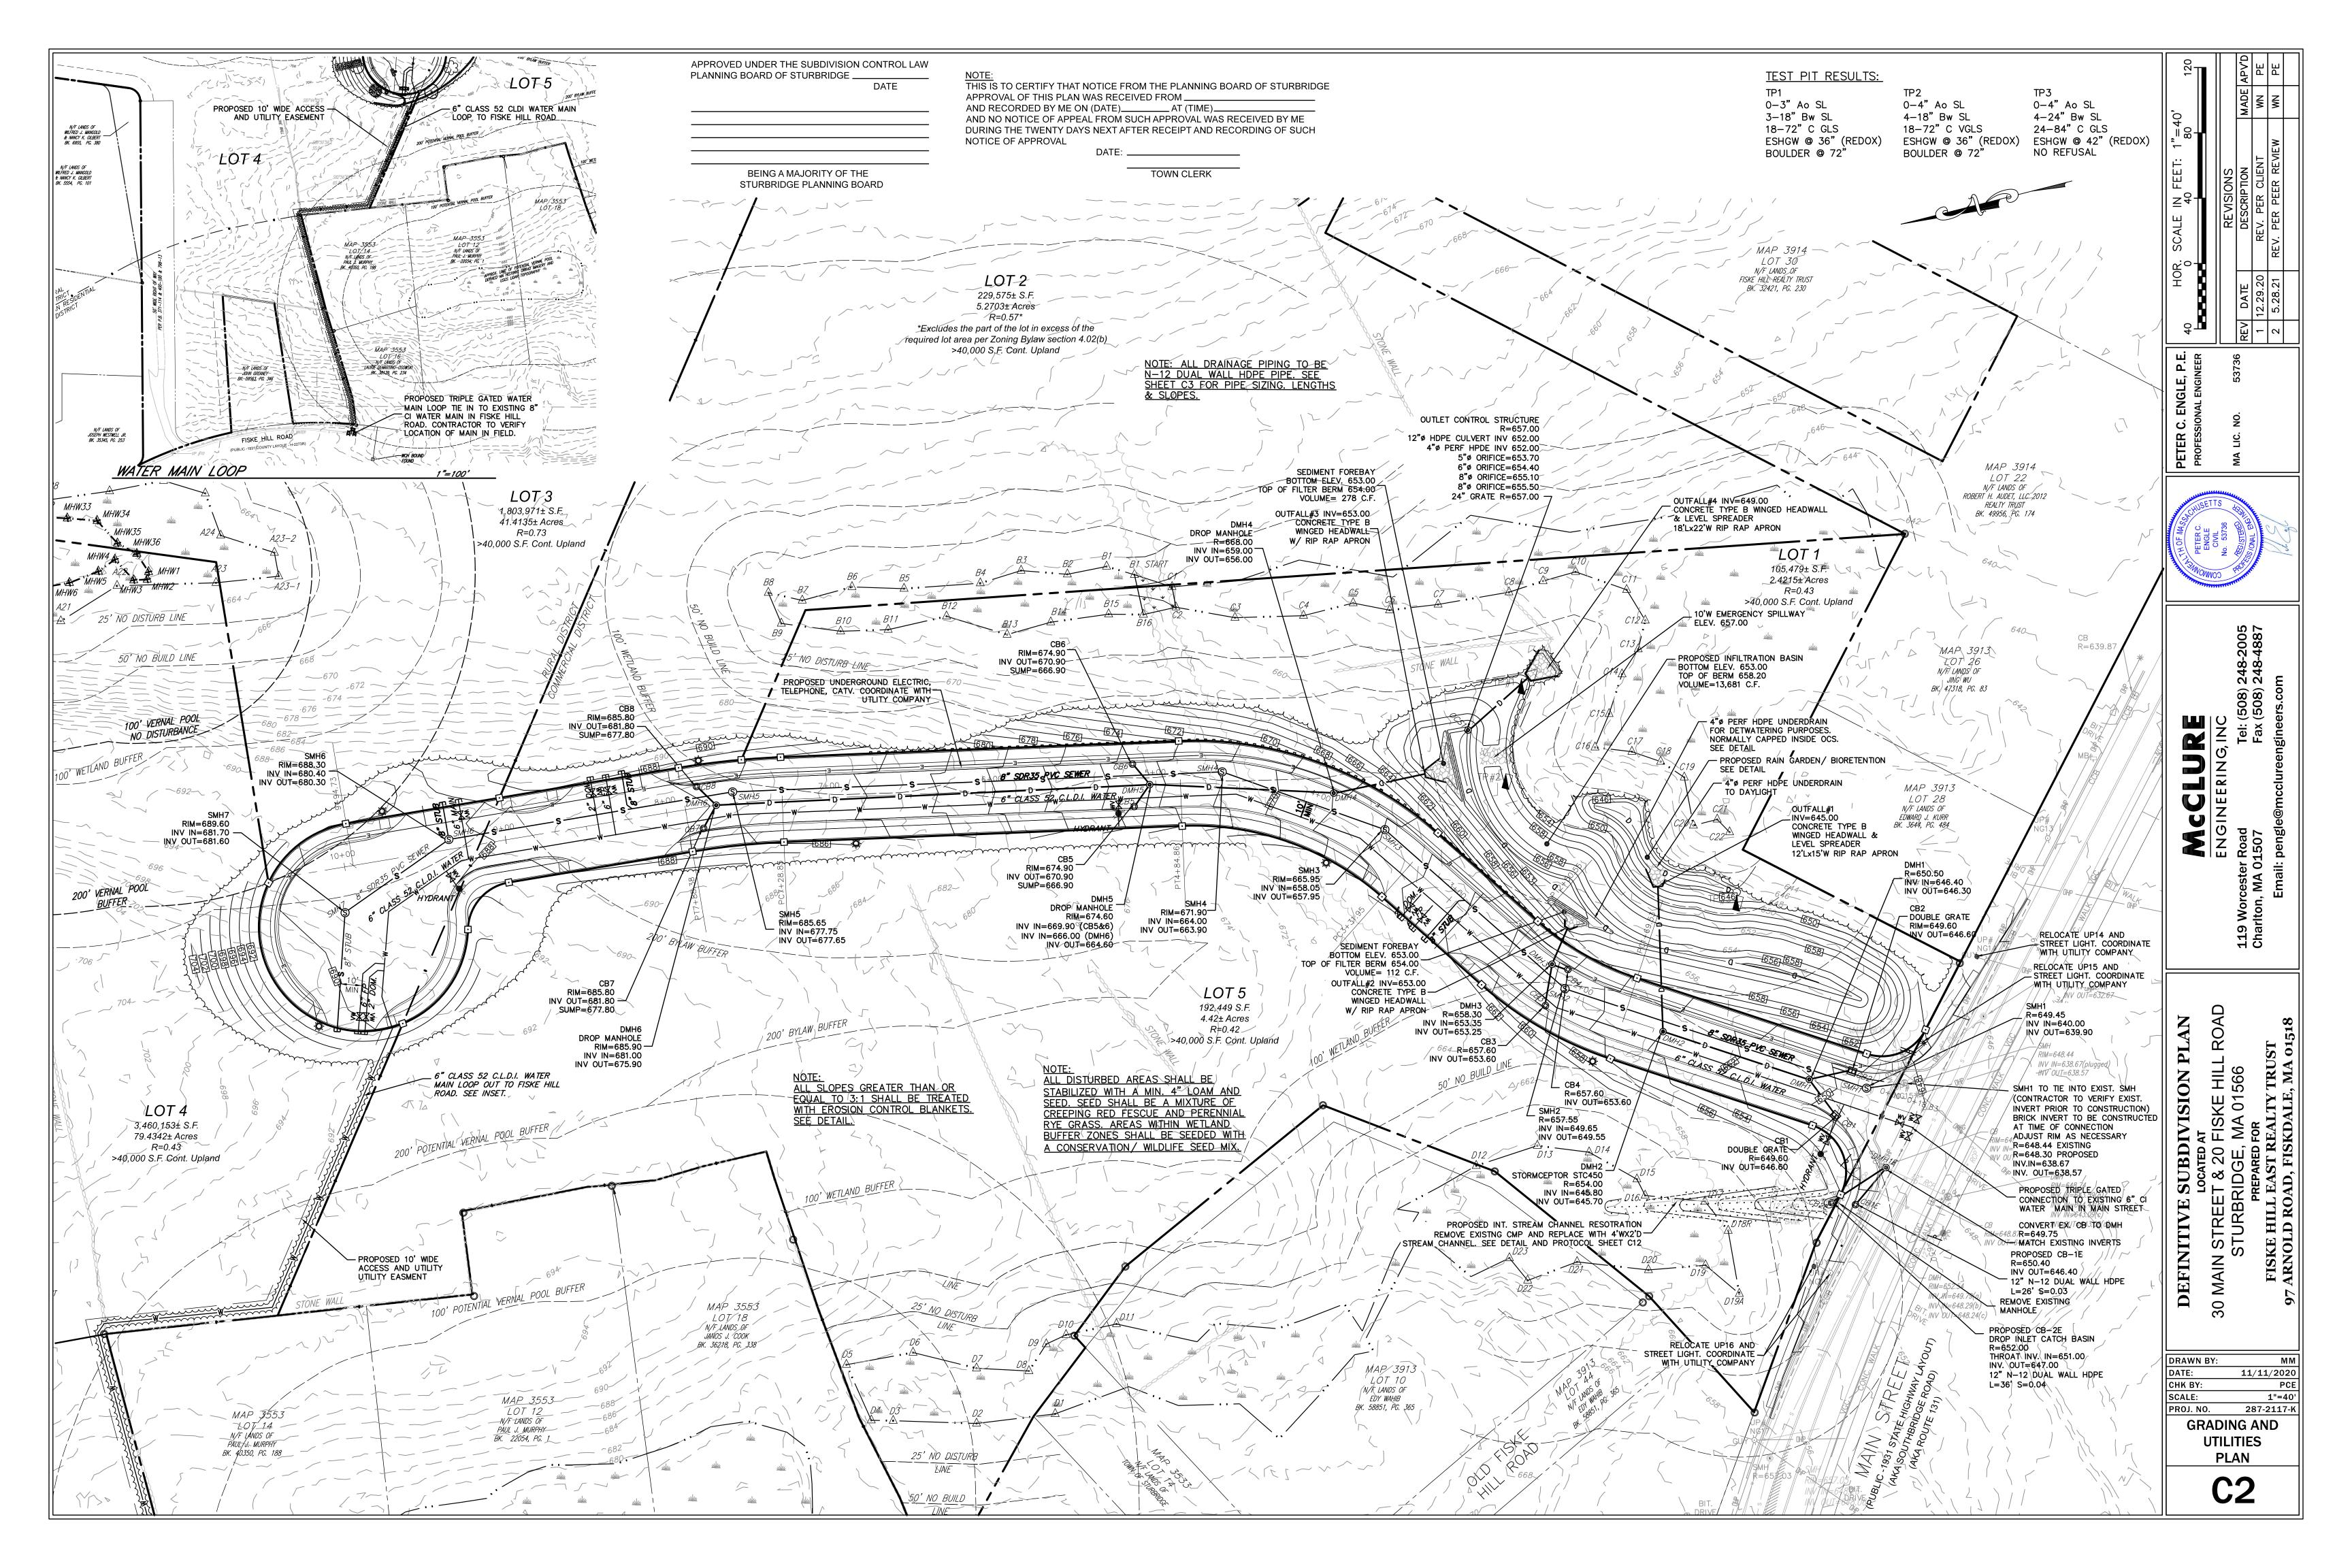

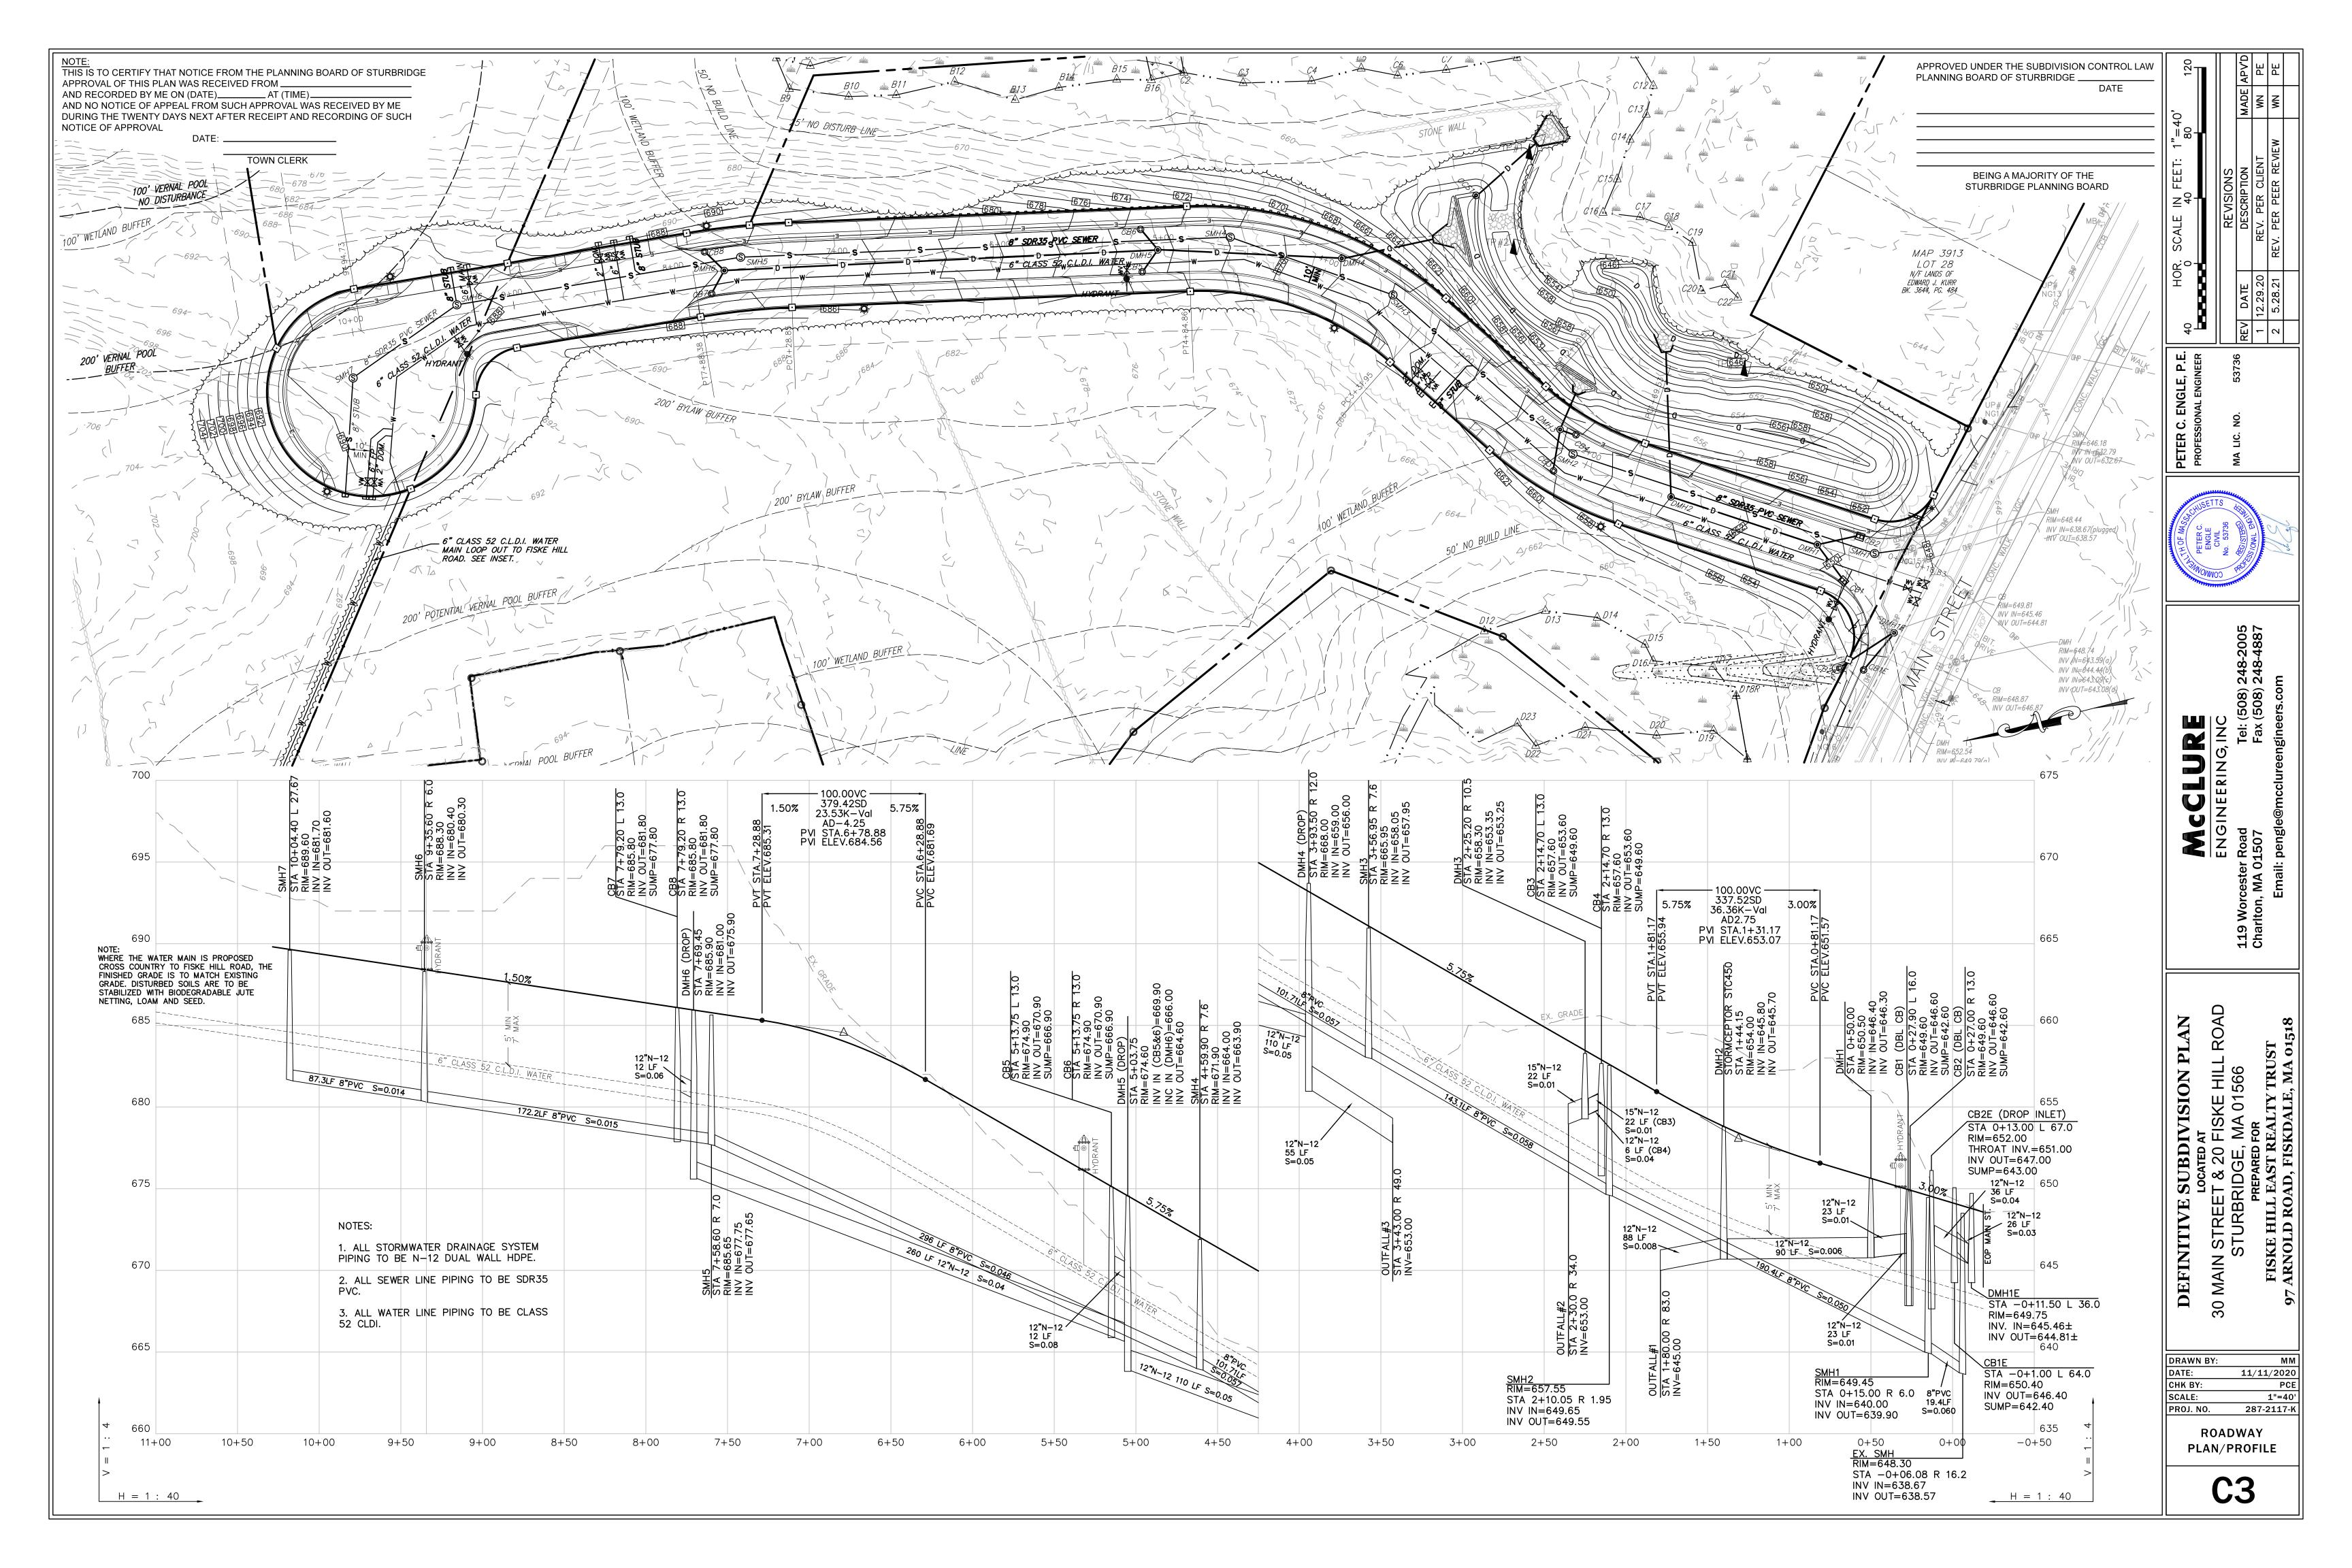

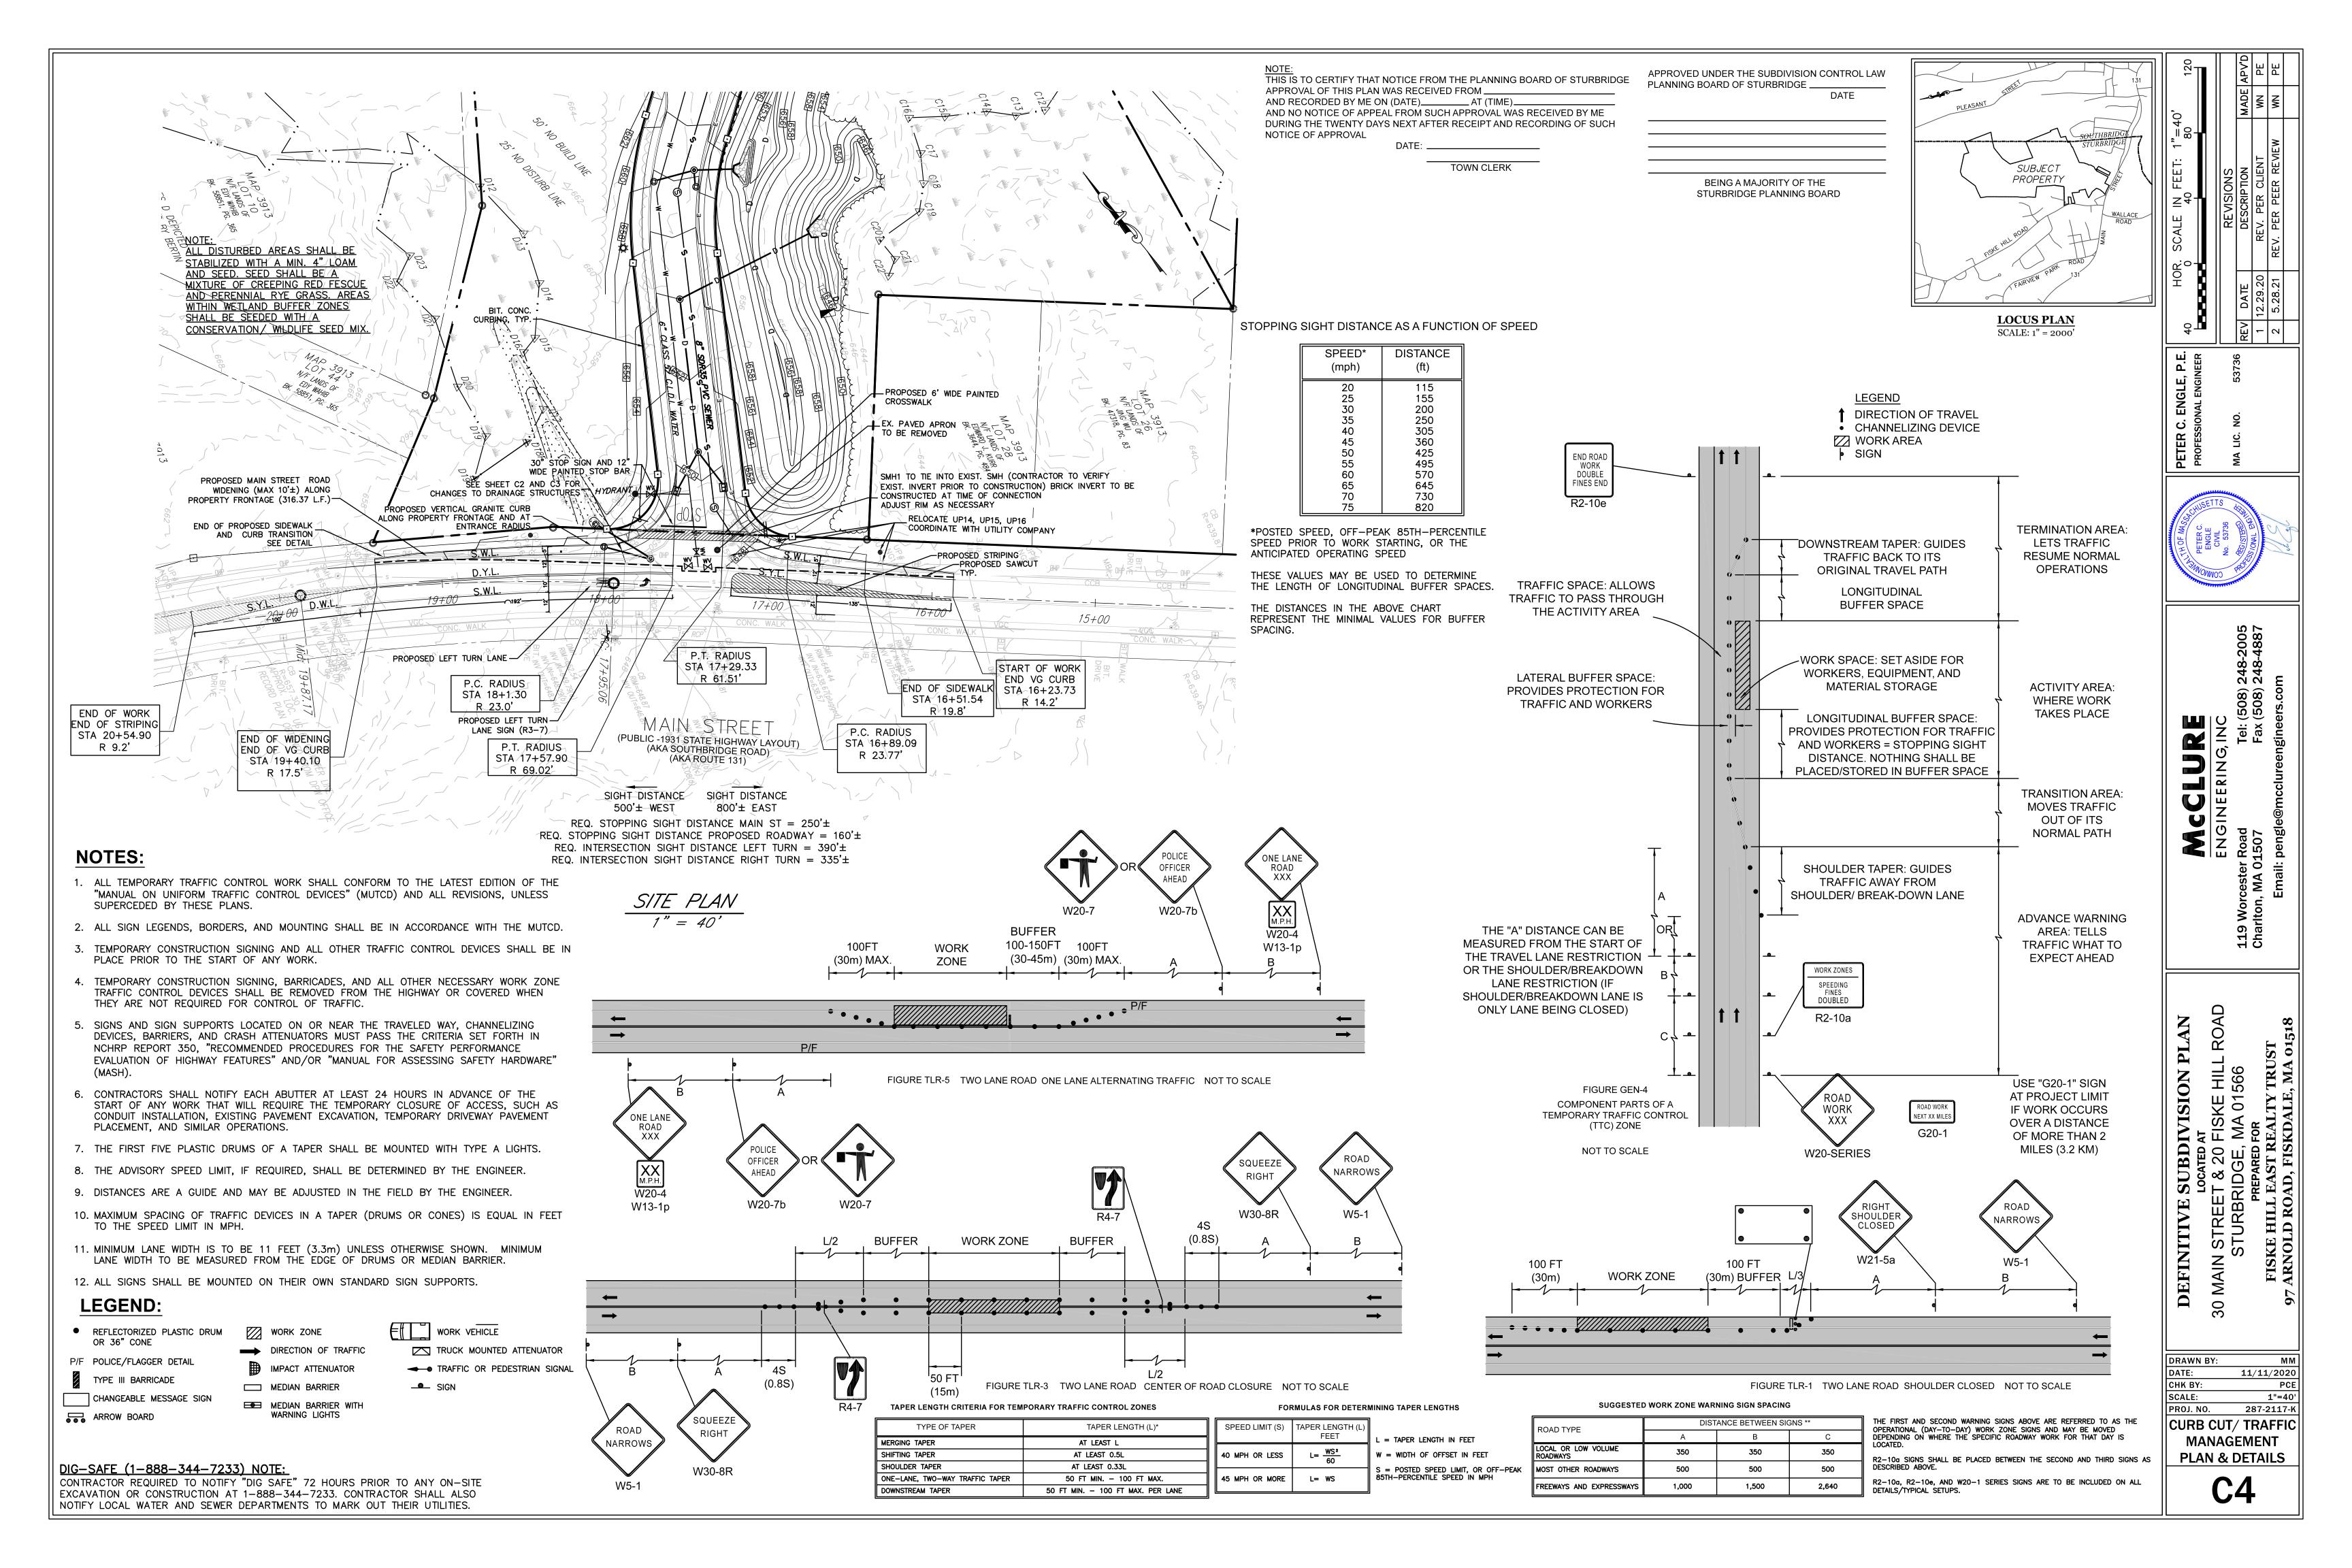

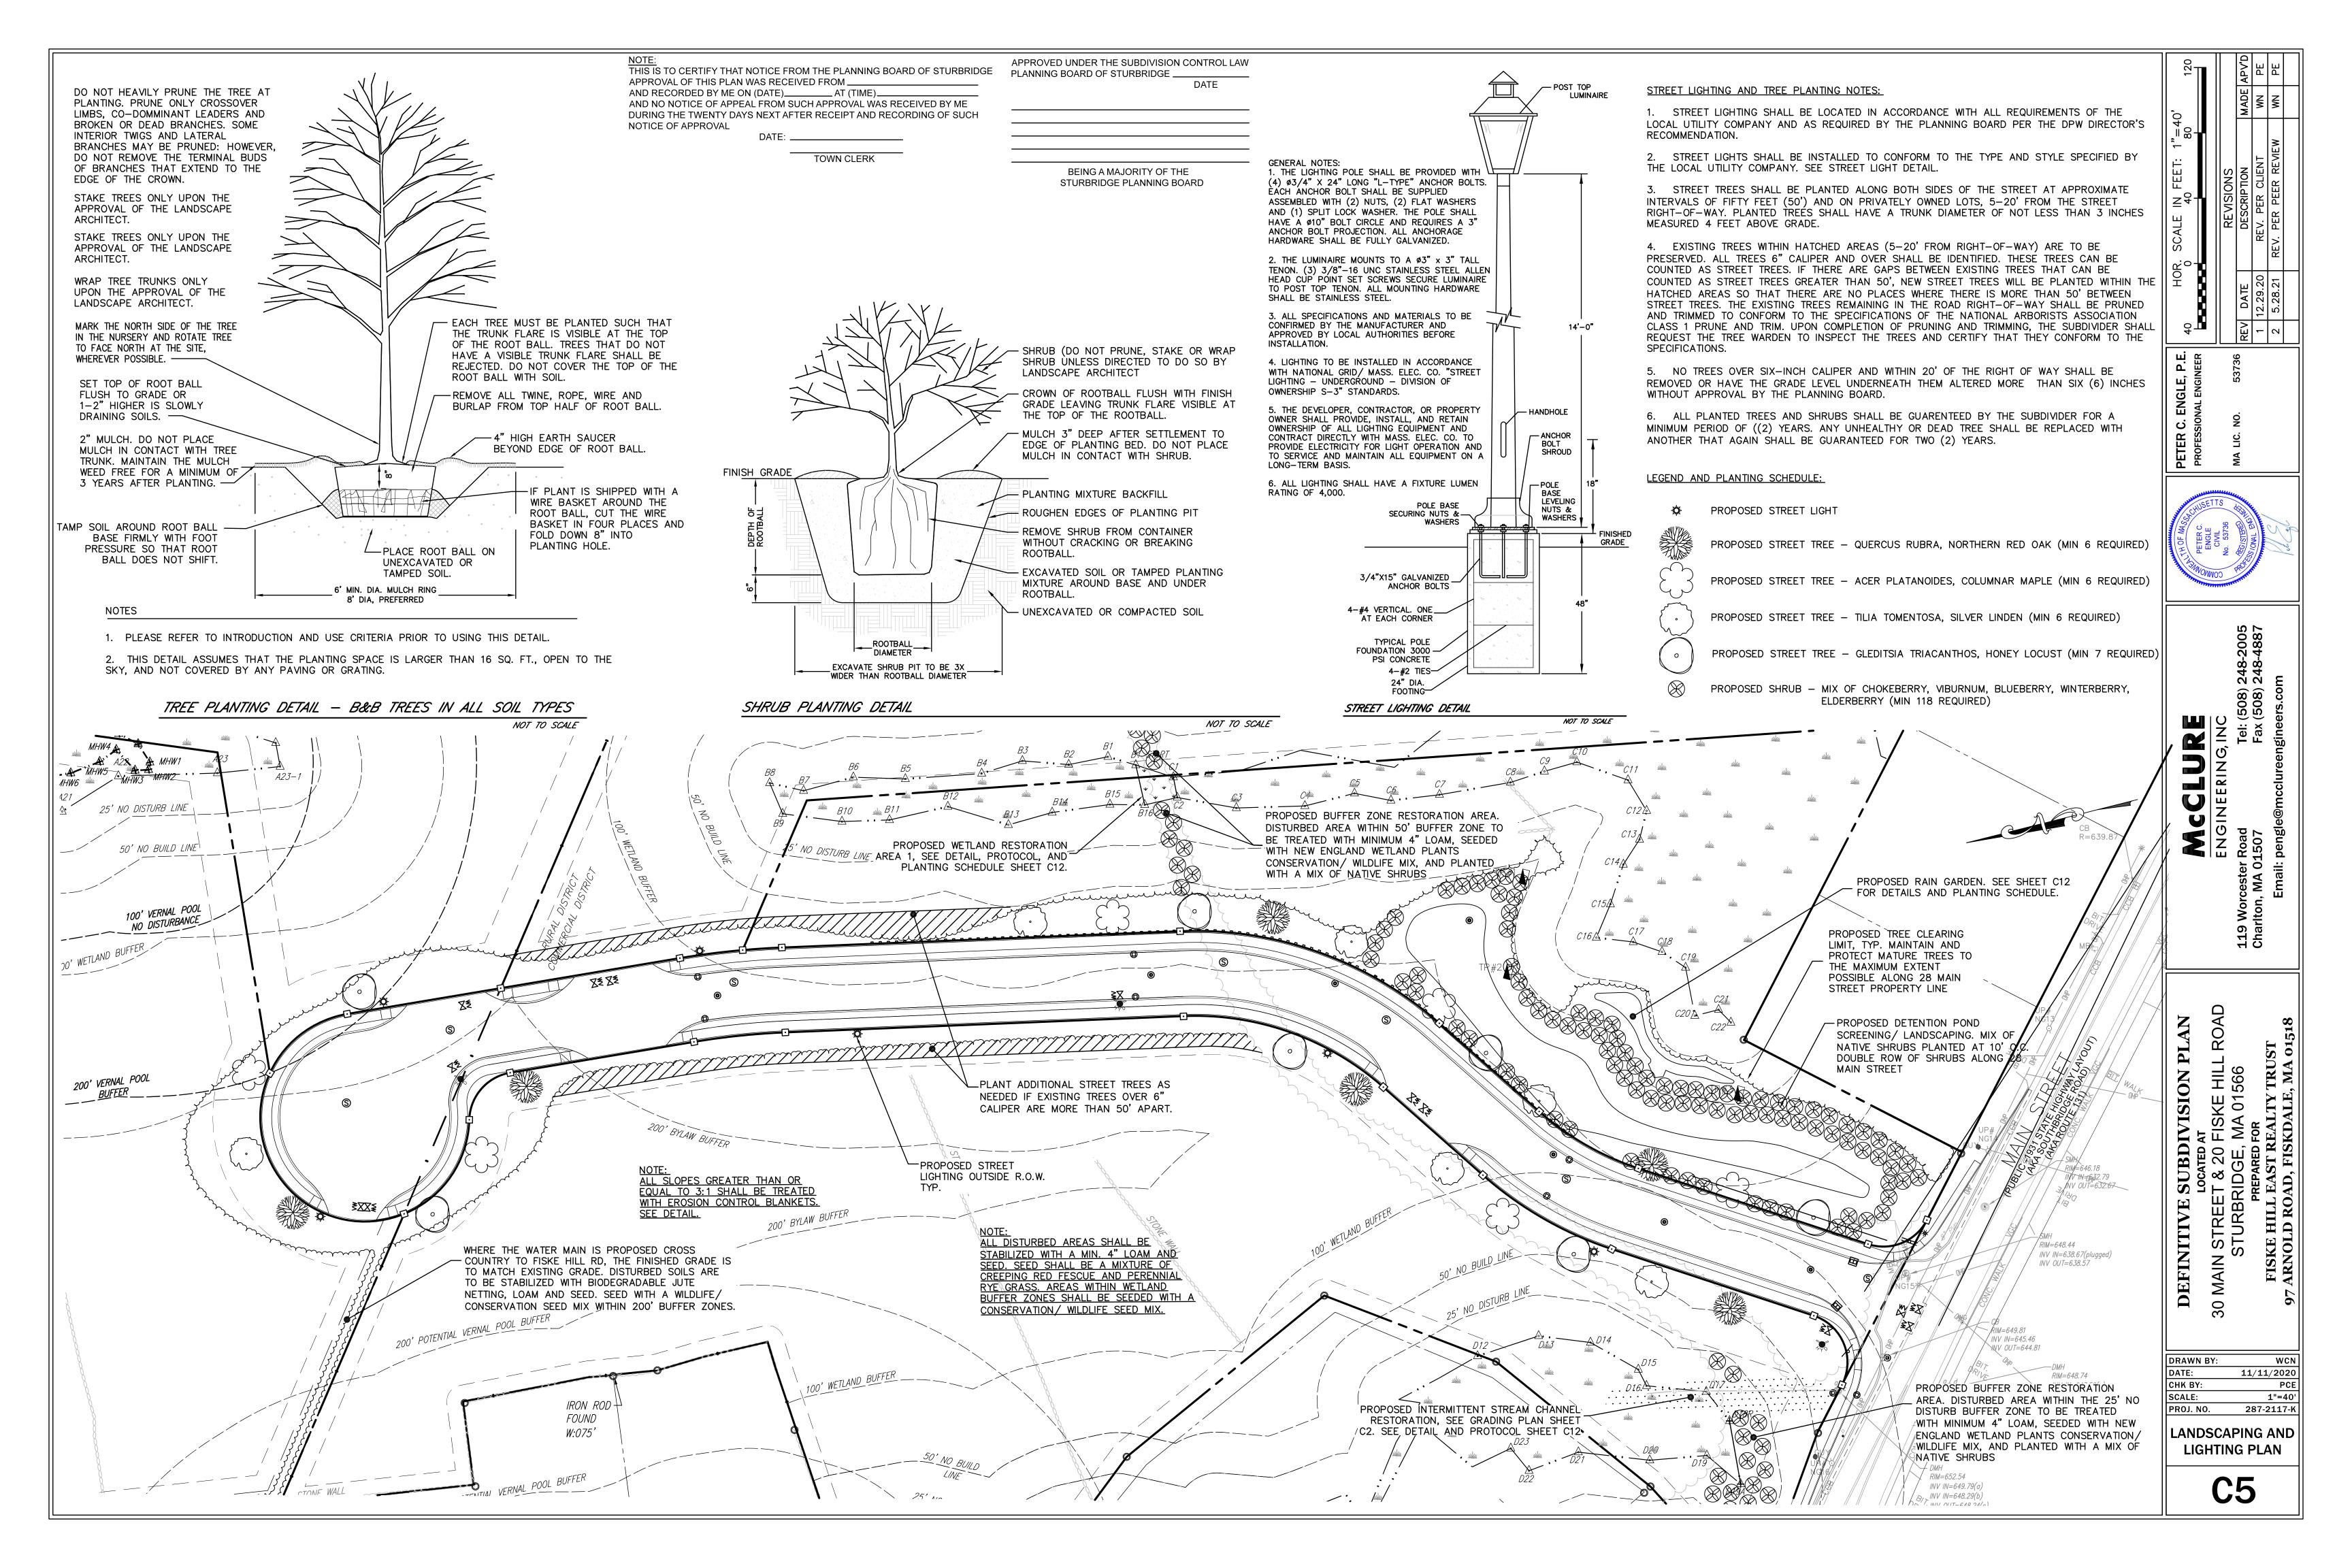

RESPONSIBILITIES OF OWNER/PERMITEE THE OWNER/ PERMITTEE SHALL: A. PROVIDE THE CONTRACTOR WITH COPIES OF LAND-USE PERMITS THAT THE OWNER HAS ACQUIRED. 3. INFORM ALL PARTIES INVOLVED WITH THE PROPOSED SITE WORK OF THIS PLAN'S OBJECTIVES AND REQUIREMENTS. RESPONSIBILITIES OF CONTRACTOR HE CONTRACTOR IS RESPONSIBLE FOR PREVENTING EROSION OF THE SITE AND FOR PROTECTING ADJACENT STORM SEWERS AND WATERWAYS FROM SEDIMENTATION. THE CONTRACTOR SHALL: A. INSTALL, MONITOR, AND MAINTAIN ALL OF THE SOIL EROSION AND SEDIMENT CONTROL MEASURES AS SHOWN ON THIS PLAN B. COMPLY WITH ALL PERMIT REQUIREMENTS. PRE-CONSTRUCTION CONFERENCE PRIOR TO CONSTRUCTION, FOLLOWING INSTALLATION OF EROSION CONTROL. THE PERMITEE, OWNER-OF-RECORD, CONTRACTOR, ENGINEER, AND TOWN REPRESENTATIVE (CONSERVATION COMMISSION) SHALL: HOLD A "PRE-CONSTRUCTION" CONFERENCE AT THE SITE TO REVIEW THE INSTALLATION OF THE PROPOSED SOIL EROSION AND SEDIMENT CONTROL MEASURES. **GENERAL CONTROLS** . CLEANING OF STORMWATER STRUCTURES: CLEAN ALL STORMWATER STRUCTURES INCLUDING, BUT NOT LIMITED TO, PIPES, SWALES, SUBSURFACE RETENTION BASINS, SEDIMENT TRAPS, AND RIPRAP APRONS OF SEDIMENT UPON COMPLETION OF THE PROJECT. . PAVEMENT MAINTENANCE: THE CONTRACTOR SHALL SWEEP PAVED ROADWAYS ADJACENT TO THE SITE ON A ROUTINE BASIS TO PREVENT TRACKING OF

SHALL BE PROMPTLY EMPTIED WHEN FULL.

WASTE DISPOSAL

MAINTENANCE:

UNDERMINING OR DETERIORATION.

MUD ONTO PUBLIC ROADWAYS AND WASHING OF MUD INTO WATERWAYS. IF THE CONTRACTOR'S SCHEDULE FOR CLEANING

THE CONTRACTOR SHALL PROVIDE AN ADEQUATE NUMBER OF COVERED WASTE CONTAINERS TO ENSURE THAT NO LITTER,

THE CONTRACTOR SHALL INSTRUCT SUBCONTRACTORS TO USE THE CONTAINERS FOR WASTE MATERIAL. THE CONTAINERS

DEBRIS. BUILDING MATERIALS. OR SIMILAR MATERIALS ARE DISCHARGED TO WETLANDS OR WATERCOURSES.

ALL MEASURES STATED ON THIS EROSION AND SEDIMENT CONTROL PLAN, AND IN THE STORM WATER

THE CONTRACT DOCUMENTS OR THE APPLICABLE PERMIT, WHICHEVER IS MORE STRINGENT, AND REPAIRED IN ACCORDANCE WITH THE FOLLOWING:

POLLUTION PREVENTION PLAN, SHALL BE MAINTAINED IN FULLY FUNCTIONAL CONDITION UNTIL NO LONGER

1. INLET PROTECTION DEVICES AND BARRIERS SHALL BE REPAIRED OR REPLACED IF THEY SHOW SIGNS OF

2. ALL SEEDED AREAS SHALL BE CHECKED REGULARLY TO SEE THAT A GOOD STAND IS MAINTAINED.

3. SILT FENCES SHALL BE REPAIRED TO THEIR ORIGINAL CONDITIONS IF DAMAGED. SEDIMENT SHALL BE

REMOVED FROM THE SILT FENCES WHEN IT REACHES ONE-HALF THE HEIGHT OF THE SILT FENCES.

REQUIRED FOR A COMPLETED PHASE OF WORK OR FINAL STABILIZATION OF THE SITE. ALL EROSION AND SEDIMENTATION CONTROL MEASURES SHALL BE CHECKED BY A QUALIFIED PERSON IN ACCORDANCE WITH

THE PAVEMENT IS FOUND TO BE INADEQUATE BY THE OWNER, OWNER'S REPRESENTATIVE, OR TOWN, THE CONTRACTOR

SHALL INCREASE THE FREQUENCY AT NO ADDITIONAL COST TO THE OWNER.

AREAS SHOULD BE FERTILIZED, WATERED, AND RE-SEEDED AS NEEDED.

GENERAL CONDITIONS

. IF EROSION CONTROL MEASURES ARE DAMAGED BY CONSTRUCTION VEHICLES. ACTS OF VANDALISM, OR SEVERE WEATHER CONDITIONS, THE CONTRACTOR SHALL IMMEDIATELY REMOVE SEDIMENT IN THE VICINITY OF THE EROSION CONTROL MEASURES AND REPAIR THESE MEASURES TO A FUNCTIONAL CONDITION.

2. IF, DURING OR AFTER CONSTRUCTION, IT BECOMES APPARENT THAT EXISTING EROSION CONTROL MEASURES ARE INCAPABLE OF CONTROLLING EROSION, THE ENGINEER OR THE TOWN MAY REQUIRE ADDITIONAL CONTROL MEASURES, INCLUDING BUT NOT LIMITED TO; ADDITIONAL STRAW WATTLES, HAYBALES, SILT FENCE, SEDIMENT BASINS, MECHANICALLY ANCHORED MULCH, OR ENHANCED DEWATERING FILTRATION.

3. NO CONSTRUCTION SHALL PROCEED UNTIL A WRITTEN PROPOSAL OF METHODS TO PREVENT CONSTRUCTION DEBRIS, PAINT, OR OTHER SUCH CONTAMINATED MATERIALS FROM ENTERING A STORM SEWER. THE WETLAND, OR WATERCOURSE HAS BEEN SUBMITTED BY THE CONTRACTOR TO THE OWNER, APPROVED BY THE OWNER AND SUCH METHODS HAVE BEEN IMPLEMENTED AS THE OWNER DIRECTS. THESE MATERIALS SHALL BE COLLECTED AND DISPOSED OF IN AN ENVIRONMENTALLY SAFE MANNER IN ACCORDANCE WITH ALL APPLICABLE FEDERAL AND STATE LAWS AND REGULATIONS. THE OWNER MAY ORDER THE CONTRACTOR TO CEASE SUCH ACTIVITY TEMPORARILY IF, IN THE JUDGMENT OF THE OWNER. WIND OR STORM CONDITIONS THREATEN TO CAUSE THE DEPOSIT OF SUCH MATERIAL IN A WATERWAY.

4. ALL TEMPORARY FILL SHALL BE STABILIZED DURING USE TO PREVENT EROSION AND SHALL BE SUITABLY CONTAINED TO PREVENT SEDIMENT OF OTHER PARTICULATE MATTER FROM REENTERING A WETLAND OR WATERCOURSE. ALL AREAS AFFECTED BY TEMPORARY FILLS MUST BE RESTORED TO THEIR ORIGINAL CONTOURS OR AS DIRECTED BY THE OWNER, AND REVEGETATED. THE AREA EXTENT OF TEMPORARY FILL OR EXCAVATION SHALL BE CONFINED TO THAT AREA NECESSARY TO PERFORM THE WORK, AS APPROVED BY THE OWNER.

5. DUMPING OF OIL. CHEMICALS OR OTHER DELETERIOUS MATERIALS ON THE GROUND IS FORBIDDEN. THE CONTRACTOR SHALL PROVIDE A MEANS OF CATCHING, RETAINING, AND PROPERLY DISPOSING OF DRAINED OIL, REMOVED OIL FILTERS, OR OTHER DELETERIOUS MATERIAL. ALL SPILLS OF SUCH MATERIALS SHALL BE REPORTED IMMEDIATELY BY THE CONTRACTOR TO APPROPRIATE TOWN AND STATE AGENCIES.

6. ALL REFUELING OF CONSTRUCTION EQUIPMENT IS TO TAKE PLACE OUTSIDE OF THE 200-FOOT RIVERFRONT ZONE. NO CONCRETE WASHOUT OR WASHING OF CONSTRUCTION EQUIPMENT IS ALLOWED WITHIN THE 200-FOOT RIVERFRONT ZONE.

7. INSPECTIONS: EROSION CONTROLS SHALL BE INSPECTED DAILY OR AFTER A LEGITIMATE STORM EVENT. INSPECTION SHALL BE RECORDED IN A LOG ALONG WITH THE TIME AND DATE. LOG SHALL BE AVAILABLE FOR INSPECTION BY THE CONSERVATION AGENT OR COMMISSIONER.

8. FILL MATERIAL TESTING: CONSERVATION COMMISSION MAY REQUIRE TESTING OF OUTSIDE FILL SOURCES. THE RESULTS OF SUCH TESTING MAY BE REVIEWED BY A STATE OF MASSACHUSETTS LICENSED SITE PROFESSIONAL (LSP) AND CONSERVATION AGENT PRIOR TO DELIVERY OF SAID MATERIAL TO THE SITE. CONTRACTOR TO REFER TO CONSERVATION ORDER OF CONDITIONS FOR SPECIFIC SOIL TESTING AND REVIEW REQUIREMENTS FOR ALL OUTSIDE FILL SOURCES.

9. DEP SIGN: A SIGN SHALL BE DISPLAYED AT THE SITE NOT LESS THAN TWO (2) SQUARE FEET (S.F.) OR MORE THAN THREE (3) S.F. IN SIZE, BEARING THE WORDS

DESCRIPTION AND MAINTENANCE OF EROSION CONTROL MEASURES

TEMPORARY STABILIZATION MEASURES

EROSION CONROL BARRIERS:

INSTALL EROSION CONTROL BARRIERS AT VARIOUS LOCATIONS AS SHOWN ON THE PLANS AND DETAILS. EMBED THE EROSION CONTROL BARRIER INTO THE GROUND AND FIRMLY ANCHOR IT AS SHOWN IN THE DETAILS. REMOVE SEDIMENT ONCE LEVELS HAVE REACHED 1/4 OF THE EFFECTIVE HEIGHT. REPAIR AND/OR REPLACE THE SILT FENCE/ HAYBALES IMMEDIATELY IF DAMAGED OR DETERIORATED.

STOCKPILING OR STORAGE OF EXCAVATED MATERIALS: COMPLETELY SURROUND TEMPORARY MATERIAL STOCKPILES WITH STRAW WATTLES TO PREVENT TRANSPORTATION OF SEDIMENT. NO STOCKPILES SHALL BE KEPT WITHIN 100'

TAKE PRECAUTIONS TO PREVENT DUST FROM BECOMING A NUISANCE TO ABUTTING PROPERTY OWNERS, BROOM OFF PAVEMENT AREAS ADJOINING THE EXCAVATION ON A DAILY BASIS. COVER AND/OR KEEP MOIST ALL EARTH STOCKPILES AT ALL TIMES. USE CALCIUM CHLORIDE TO CONTROL DUST OVER CERTAIN AREAS OF THE SITE AS NEEDED AND/OR AS DIRECTED BY THE ENGINEER. CALCIUM CHLORIDE SHALL CONFORM TO ASTM D-98. TYPE I. THE CONTRACTOR SHALL MAINTAIN AND INSPECT, ON A DAILY BASIS, THE ADEQUACY OF DUST CONTROL MEASURES AND CORRECT ANY DEFICIENCIES IMMEDIATELY.

IF DEWATERING IS REQUIRED. WATER SHOULD BE DISCHARGED TO DEWATERING BAGS OR OTHER SEDIMENT REMOVAL DEVICES PRIOR TO DISCHARGE TO RESOURCE AREAS. WATER MAY ALSO BE USED FOR DUST CONTROL AND/OR VEGETATION WATERING.

PERMANENT STABILIZATION MEASURES

DISTURBED PORTIONS OF THE SITE WHERE CONSTRUCTION ACTIVITIES PERMANENTLY CEASE SHALL BE STABILIZED WITH PERMANENT SEED NO LATER THAN 14 DAYS AFTER THE LAST CONSTRUCTION ACTIVITY. THE CONTRACTOR SHALL BE RESPONSIBLE FOR ALL LANDSCAPED AREAS. IF TOPSOIL, SEED, AND/OR MULCH IS WASHED AWAY BY RAINFALL. THE CONTRACTOR SHALL RESTORE THE AREA.

> ACREAGE SUMMARY IN ACRES SEEDED AREA 1.9 AC± TOTAL DISTURBED 3.0 AC±

CONSTRUCTION SCHEDULE AND EROSION & SEDIMENTATION CONTROL CHECKLIST

30 MAIN STREET

WORK DESCRIPTION

SEQUENCE OF CONSTRUCTION THE FOLLOWING NARRATIVE DESCRIBES THE PLANNED CONSTRUCTION SEQUENCE WITH AN EMPHASIS ON THE TIMING AND SEQUENCE OF EROSION/SEDIMENTATION CONTROL MEASURES:

THE FOLLOWING CONSTRUCTION SEQUENCE WILL BE REQUIRED TO INSURE THE EFFECTIVENESS OF THE EROSION/SEDIMENT CONTROL MEASURES IS OPTIMIZED.

INSTALL STABILIZED CONSTRUCTION EXIT(S), SWPPP ENTRANCE SIGN, AND DEP SIGN. INSTALL EROSION CONTROL BARRIERS ON THE ENTIRE SITE (CLEAR ONLY THOSE AREAS NECESSARY TO INSTALL SILT FENCE AND HAYBALES.) CONSERVATION INSPECTION WILL BE CONDUCTED AFTER INSTALLATION OF EROSION CONTROL BARRIERS ARE INSTALLED.

PREPARE TEMPORARY PARKING AND STORAGE AREA UPON IMPLEMENTATION AND INSTALLATION OF THE FOLLOWING AREAS: PARKING, LAY DOWN, PORTA POTTY MATERIAL STORAGE CONTAINERS, ETC., DENOTE THEM ON THE SITE MAPS IMMEDIATELY AND NOTE ANY CHANGES IN THE LOCATIONS AS THEY OCCUR THROUGHOUT THE CONSTRUCTION PROCESS. 5. CLEAR AND GRUB AREA FOR SEDIMENT BASINS. CONSTRUCT AND STABILIZE SEDIMENT BASINS. HALT ALL ACTIVITIES AND CONTACT THE CIVIL ENGINEERING

CONSULTANT TO PERFORM INSPECTION AND CERTIFICATION OF BMP'S. GENERAL CONTRACTOR SHALL SCHEDULE AND CONDUCT STORM WATER PRE-CONSTRUCTION MEETING WITH ENGINEER AND ALL GROUND-DISTURBING CONTRACTORS BEFORE PROCEEDING WITH CONSTRUCTION. BEGIN CLEARING AND GRUBBING THE SITE.

INSTALL TEMPORARY DIVERSION DITCHES AND CHECK DAMS. BEGIN GRADING THE SITE AS NEEDED.

START INSTALLATION OF DRAINAGE AND SITE WORK. 10. TEMPORARILY SEED, THROUGHOUT CONSTRUCTION, DENUDED AREAS THAT WILL BE INACTIVE FOR 15 DAYS OR MORE. PERMANENTLY STABILIZE AREAS TO BE VEGETATED AS THEY ARE COMPLETED.

FINAL PHASE

1. PERMANENTLY STABILIZE ANY REMAINING EXPOSED AREAS. TEMPORARY DRAINAGE DITCHES TO BE REMOVED AND STABILIZED. SEDIMENT FROM BASINS TO BE REMOVED AND SEDIMENT DISPOSED OF OFFSITE. BASINS ARE TO BE CONVERTED TO FINAL STORMWATER BASINS AS SHOWN ON

4. ONCE ENTIRE SITE IS STABILIZED, CALL FOR FINAL INSPECTION FROM SITE MONITOR.

NOTES:

1. ONCE CONSTRUCTION IS COMPLETED, ALL DISTURBED AREAS ARE TO BE STABILIZED WITH LOAM AND SEED UNLESS OTHERWISE SPECIFIED. 2. INSPECTIONS WILL BE CONDUCTED WEEKLY AND AFTER 0.25 INCH RAIN EVENTS. COPIES OF WEEKLY REPORTS AND RAIN EVENT REPORTS SHALL BE SUBMITTED TO THE CONSERVATION COMMISSION WITHIN SEVEN DAYS OF THE INSPECTION.

3. EXTRA EROSION CONTROL MATERIALS (HAYBALES, SILT FENCE) EQUAL TO 100 LF SHALL BE KEPT ON SITE FOR EMERGENCY REPAIRS. THESE MATERIALS SHALL BE KEPT COVERED.

NOTE: APPLICANT AND/OR LANDOWNER SHALL NOTIFY THE TOWN OF STURBRIDGE IN WRITING AT LEAST FIVE (5) BUSINESS DAYS PRIOR TO COMMENCING ANY WORK.


APPROVED UNDER THE SUBDIVISION CONTROL LAW PLANNING BOARD OF STURBRIDGE . DATE


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OA SKE A 01

30 DRAWN BY: 11/11/2020 CHK BY: 1"=40'

SCALE: PROJ. NO. 287-2117-K SEDIMENTATION & EROSION CONTROL PLAN



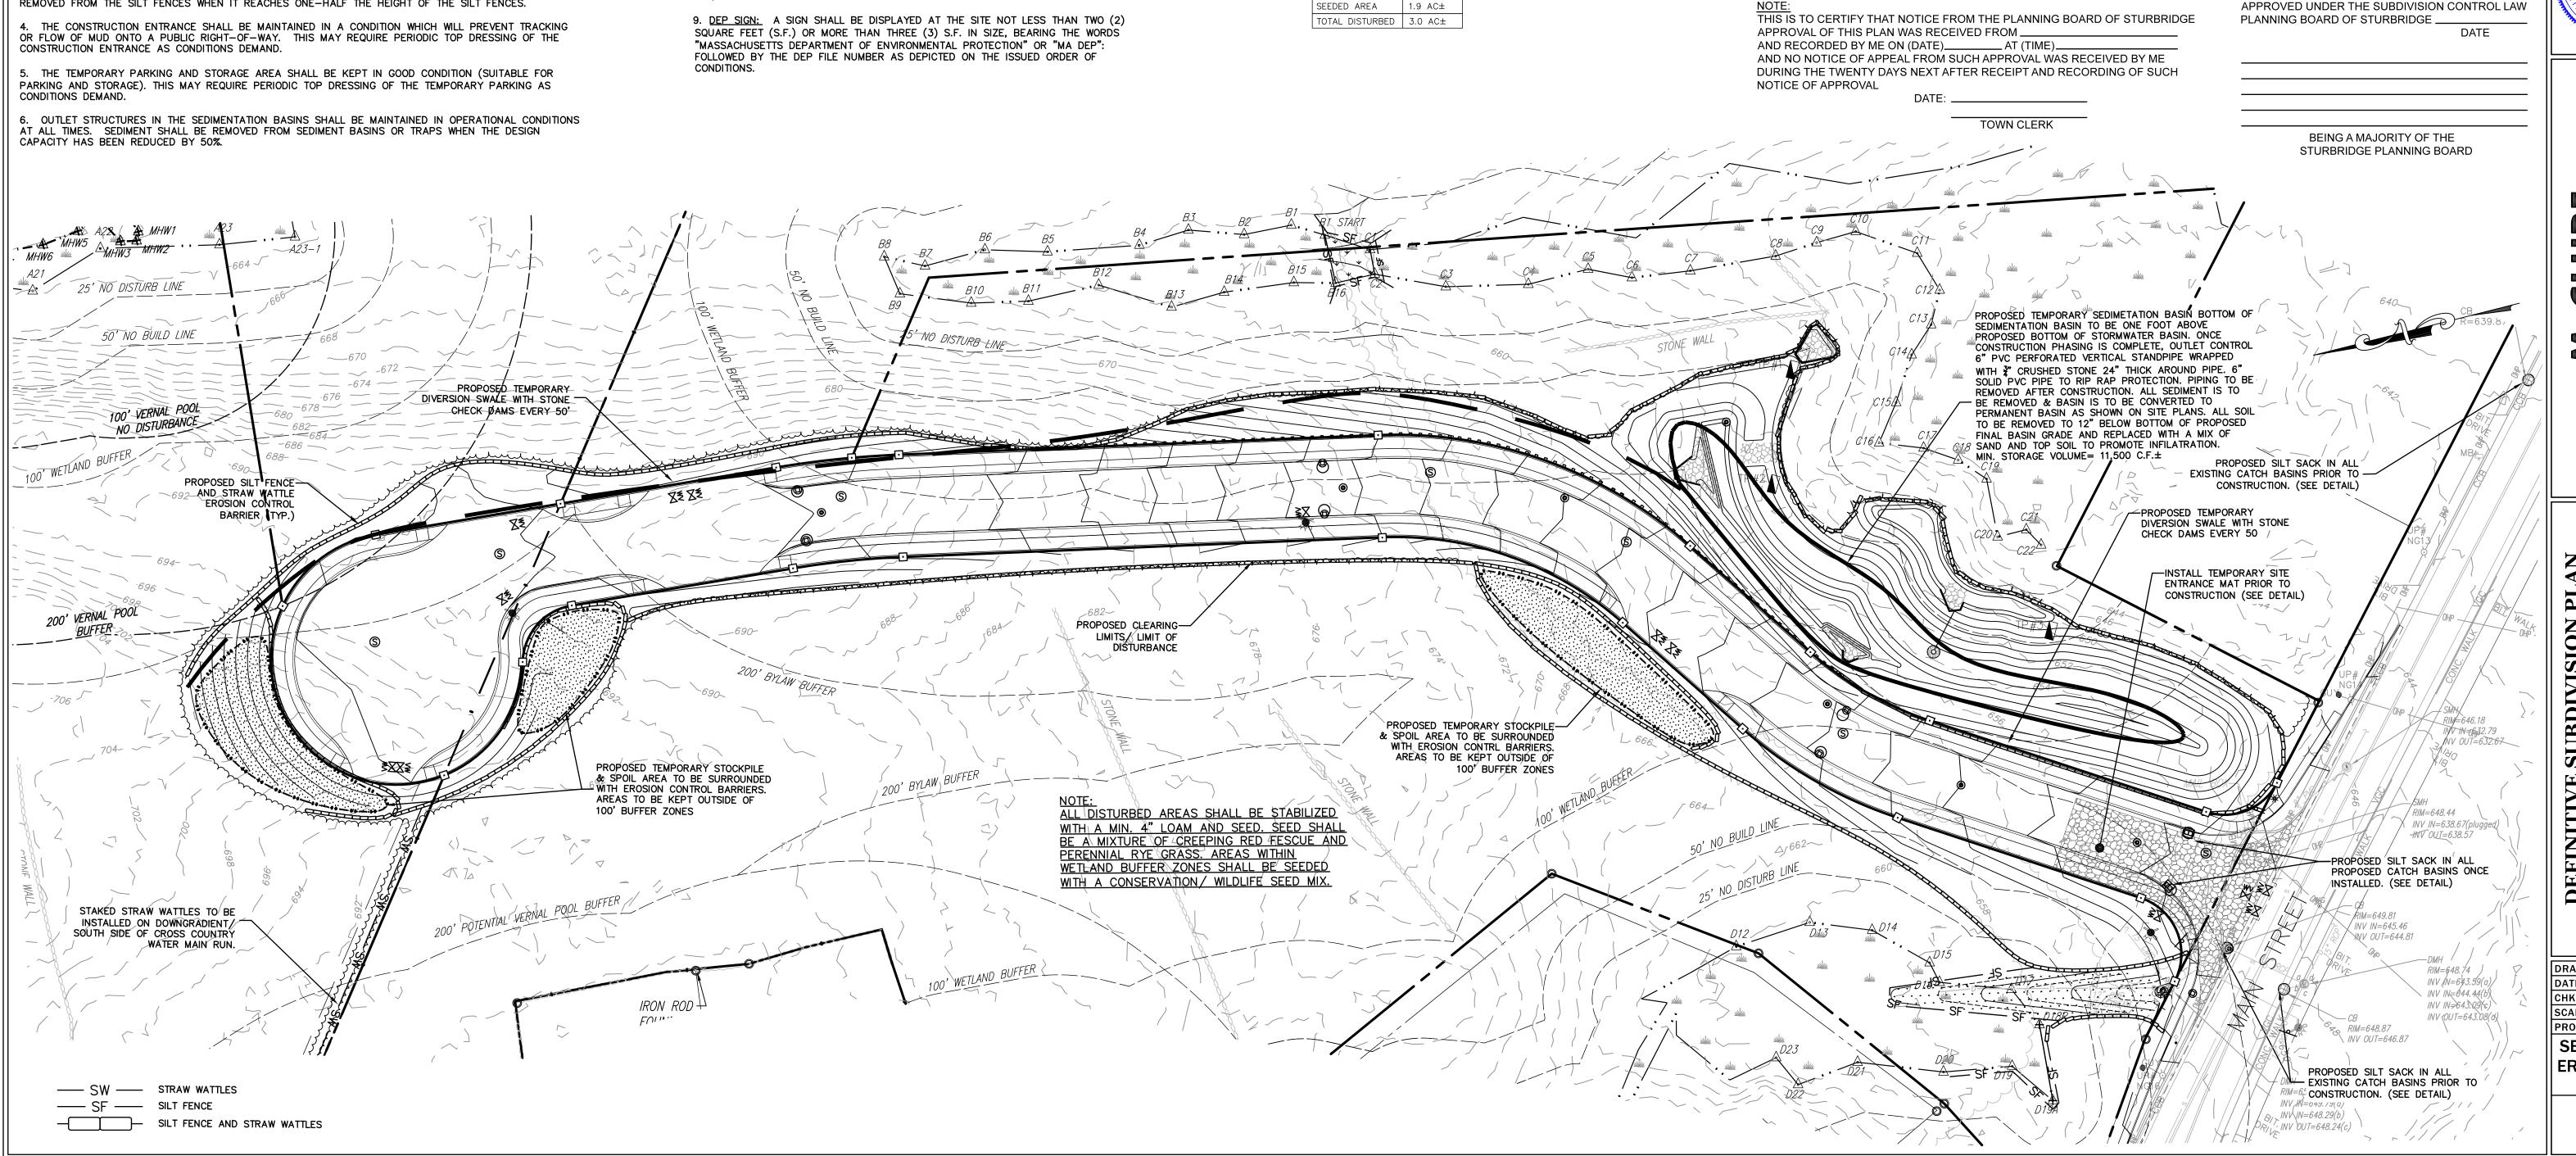


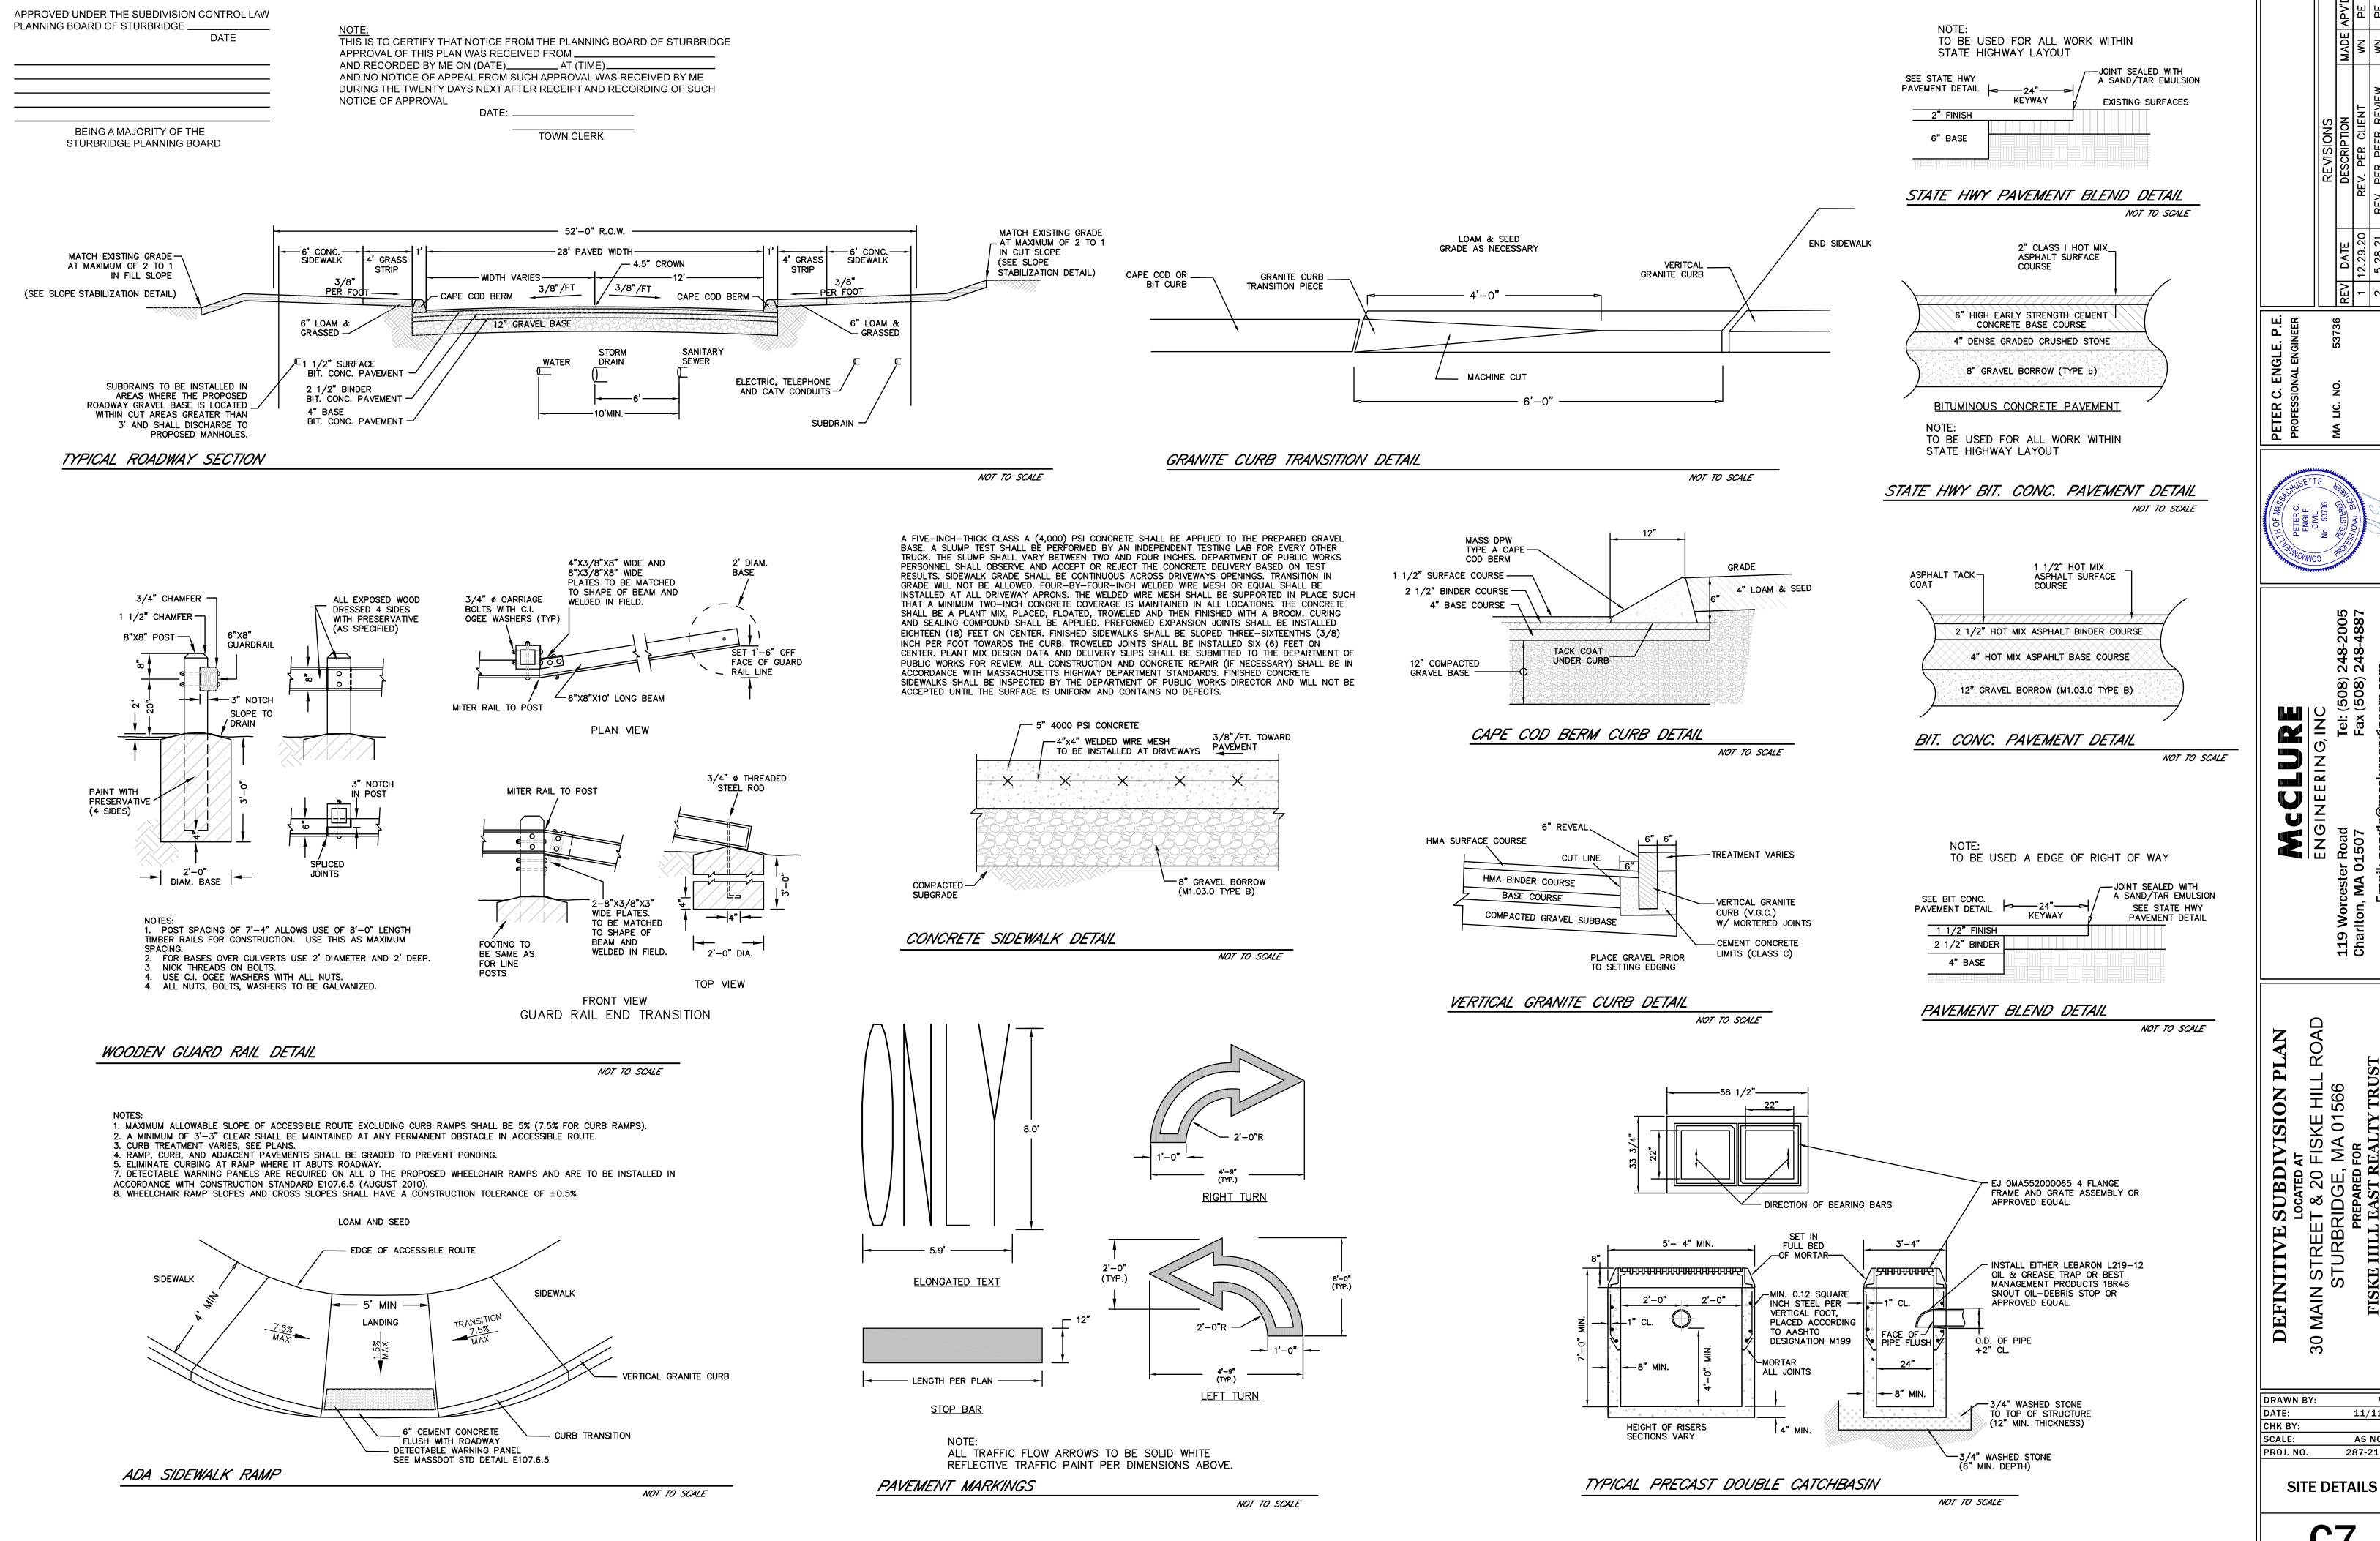
248-2005 248-4887

SKE A 01

30 MAIN 11/11/20

AS NOTED 287-2117-l

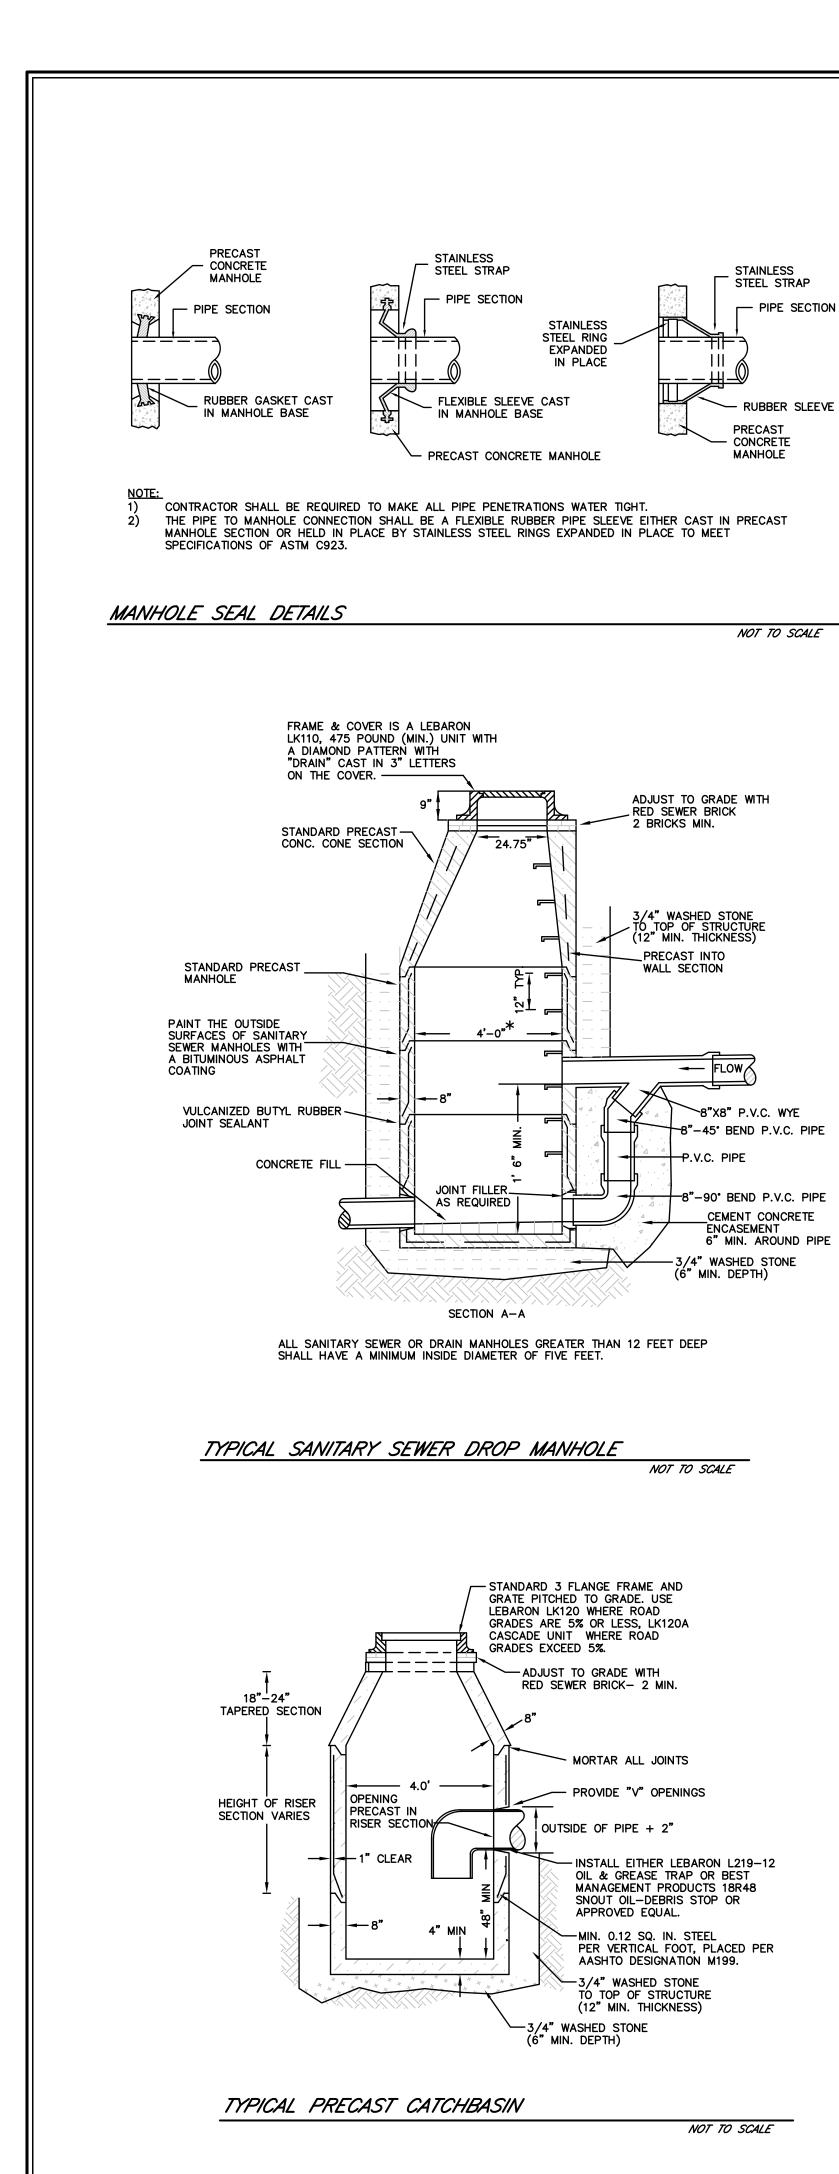

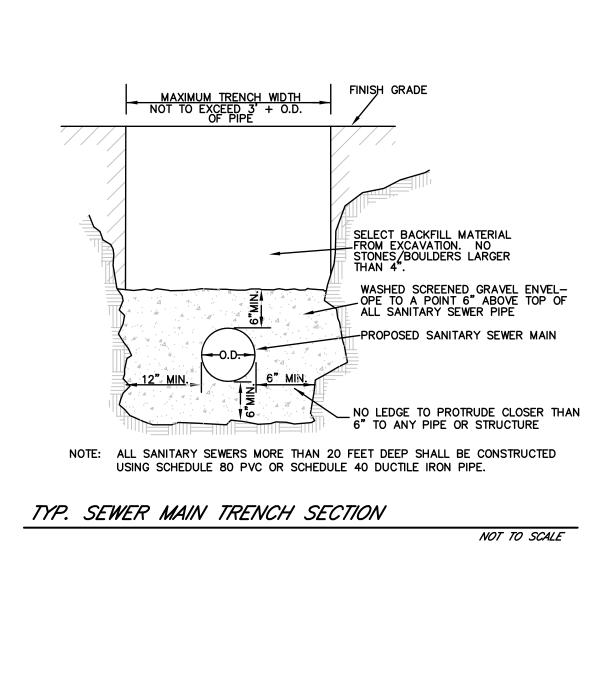

WYE SERVICE

TEE SERVICE

8" P.V.C. SEWER MAIN

NOT TO SCALE

DO NOT REST CONCRETE

PVC SEWER

NOT TO SCALE

ON DRAIN LINE

MATERIAL & SIZE

PER PLAN

PLAN VIEW

RIGHT OF WAY LINE

PROFILE VIEW

TYPICAL SERVICE CONNECTION (SEWER)

-12" MIN. -----

DRAIN PIPE

TYPICAL SEWER/DRAIN CROSSING

CONCRETE ENCASEMENT OF BOTH WATER AND SEWER SHALL EXTEND FOR 10 FEET FROM THE INTERSECTION OF THE MAINS AND ALONG EACH MAIN. CENTER

ONE FULL PIPE LENGTH OF BOTH WATER AND SEWER OVER THE INTERSECTION.

CONCRETE ENCASEMENT

COMPACTED SOIL

TYPICAL DRAIN/SEWER CROSSING


UTILITY CROSSING DETAILS


MIN. SLOPE


1/4" PER FOOT


CONCRETE ENCASEMENT


PVC SEWER

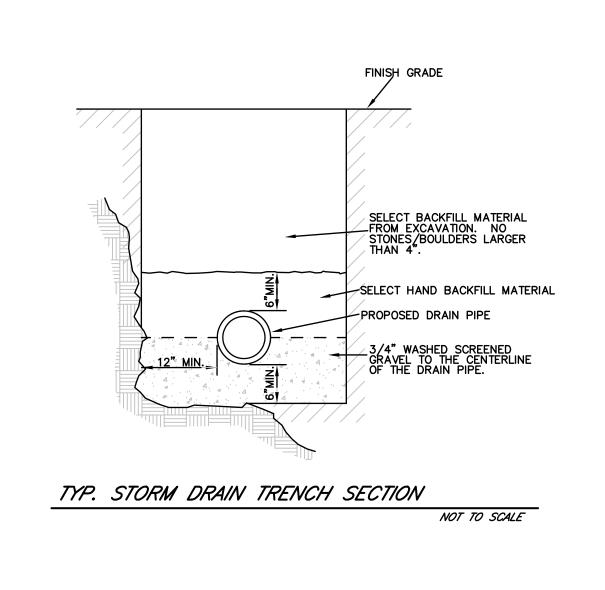


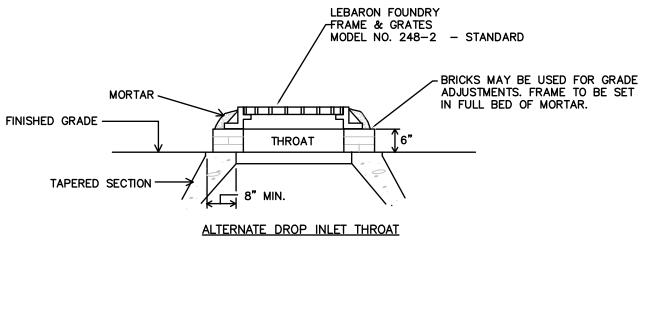


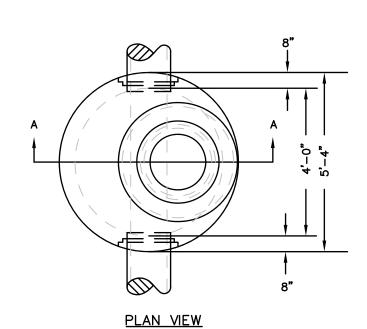


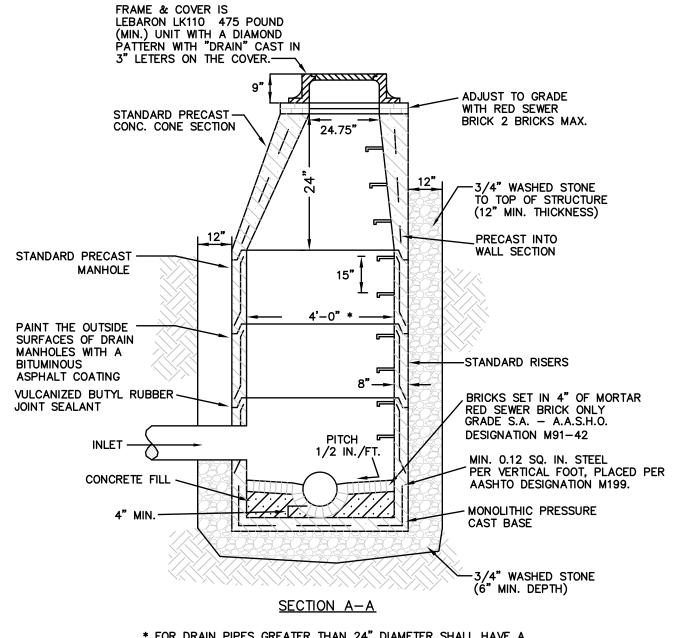

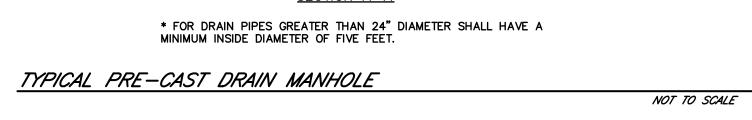

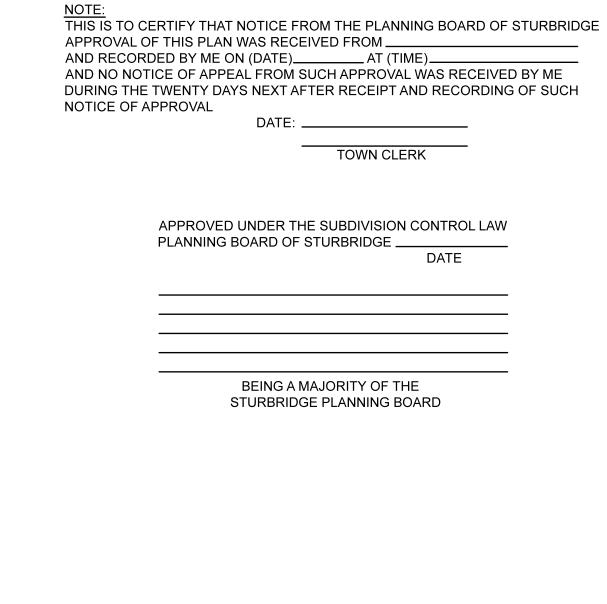

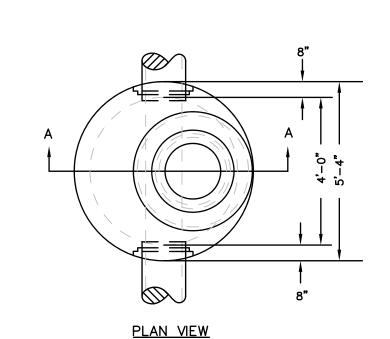

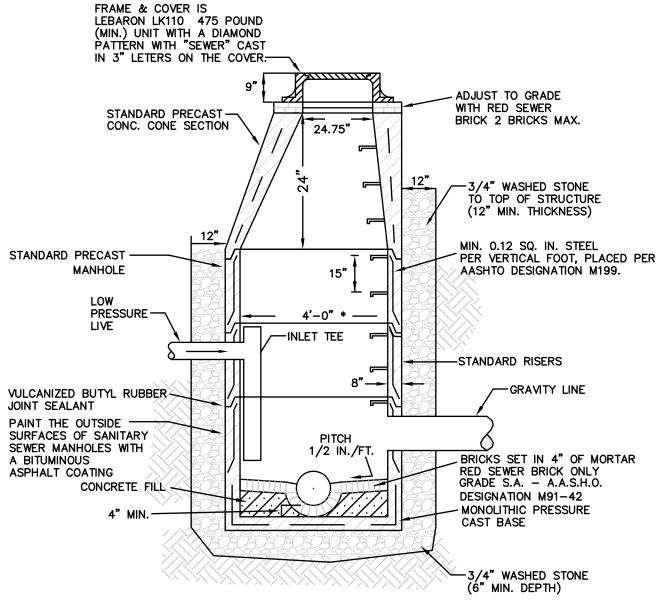

SECTION A-A * IF INLET TEE IS DISCONNECTED OR MISSING, IT MUST BE REPLACED BEFORE MAKING NEW SANITARY SEWER CONNECTION FROM PRESSURE WAY.

NOTES:
ALL SEWER PIPING AND/OR STRUCTURES CROSSING UNDER OR WITHIN 100 FEET OF ANY SURFACE WATER BODY, STORM WATER IMPOUNDMENT OR WETLAND SHALL BE BUILT USING WATERTIGHT CONSTRUCTION METHODS AND MATERIALS.
SANITARY SEWER SHALL BE INSTALLED WITH A MINIMUM HORIZONTAL SEPARATION OF 10 FEET TO ALL WATER SUPPLY LINES. WHEN A 10' HORIZONTAL SEARATION BETWEEN THE SEWER AND WATER CANNOT BE MAINTAINED, THE WATER MAIN SHALL BE INSTALLED IN A SEPARATE TRENCH ABOVE THE SEWER WITH AN 18 INCH VERTICAL

THE WATER MAIN SHALL BE INSTALLED IN A SEPARATE TRENCH ABOVE THE SEWER WITH AN 18 INCH VERTICAL SEPARATION BETWEEN THE CROWN OF THE SEWER AND THE INVERT OF THE WATER MAIN. ALL ROADWAY FILLS SHALL BE BROUGHT UP IN UNIFORM ONE FOOT LAYERS AND SHALL BE COMPACTED TO A RELATIVE COMPACTION OF NOT LESS THAN 95% AS DETERMINED BY AASHTO TEST DESIGNATION T-99, METHOD C. MATERIAL SHALL BE TESTED FOR COMPLIANCE TO ABOVE REGULATION BY A MATERIALS AND TESTING FIRM IN AREAS WHERE FILL IS FIVE FEET OR MORE. COPIES OF THE TEST RESULTS SHALL BE SUBMITTED TO THE

NOT TO SCALE

ALL SANITARY SEWER OR DRAIN MANHOLES GREATER THAN 12 FEET DEEP SHALL HAVE A MINIMUM INSIDE DIAMETER OF FIVE FEET.

TYPICAL SANITARY SEWER MANHOLE

DRAWN BY: WCN 11/11/20 CHK BY: SCALE: AS NOTED PROJ. NO. 287-2117-l

DEFINITIVE


SITE DETAILS

248-248-

PL4

ROAD UBDIVISION CATED AT ISKE 1A 01

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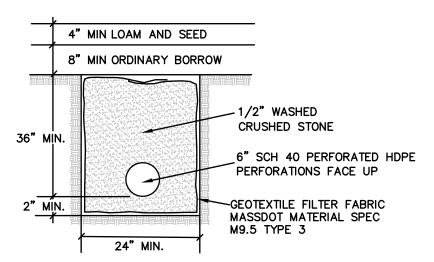


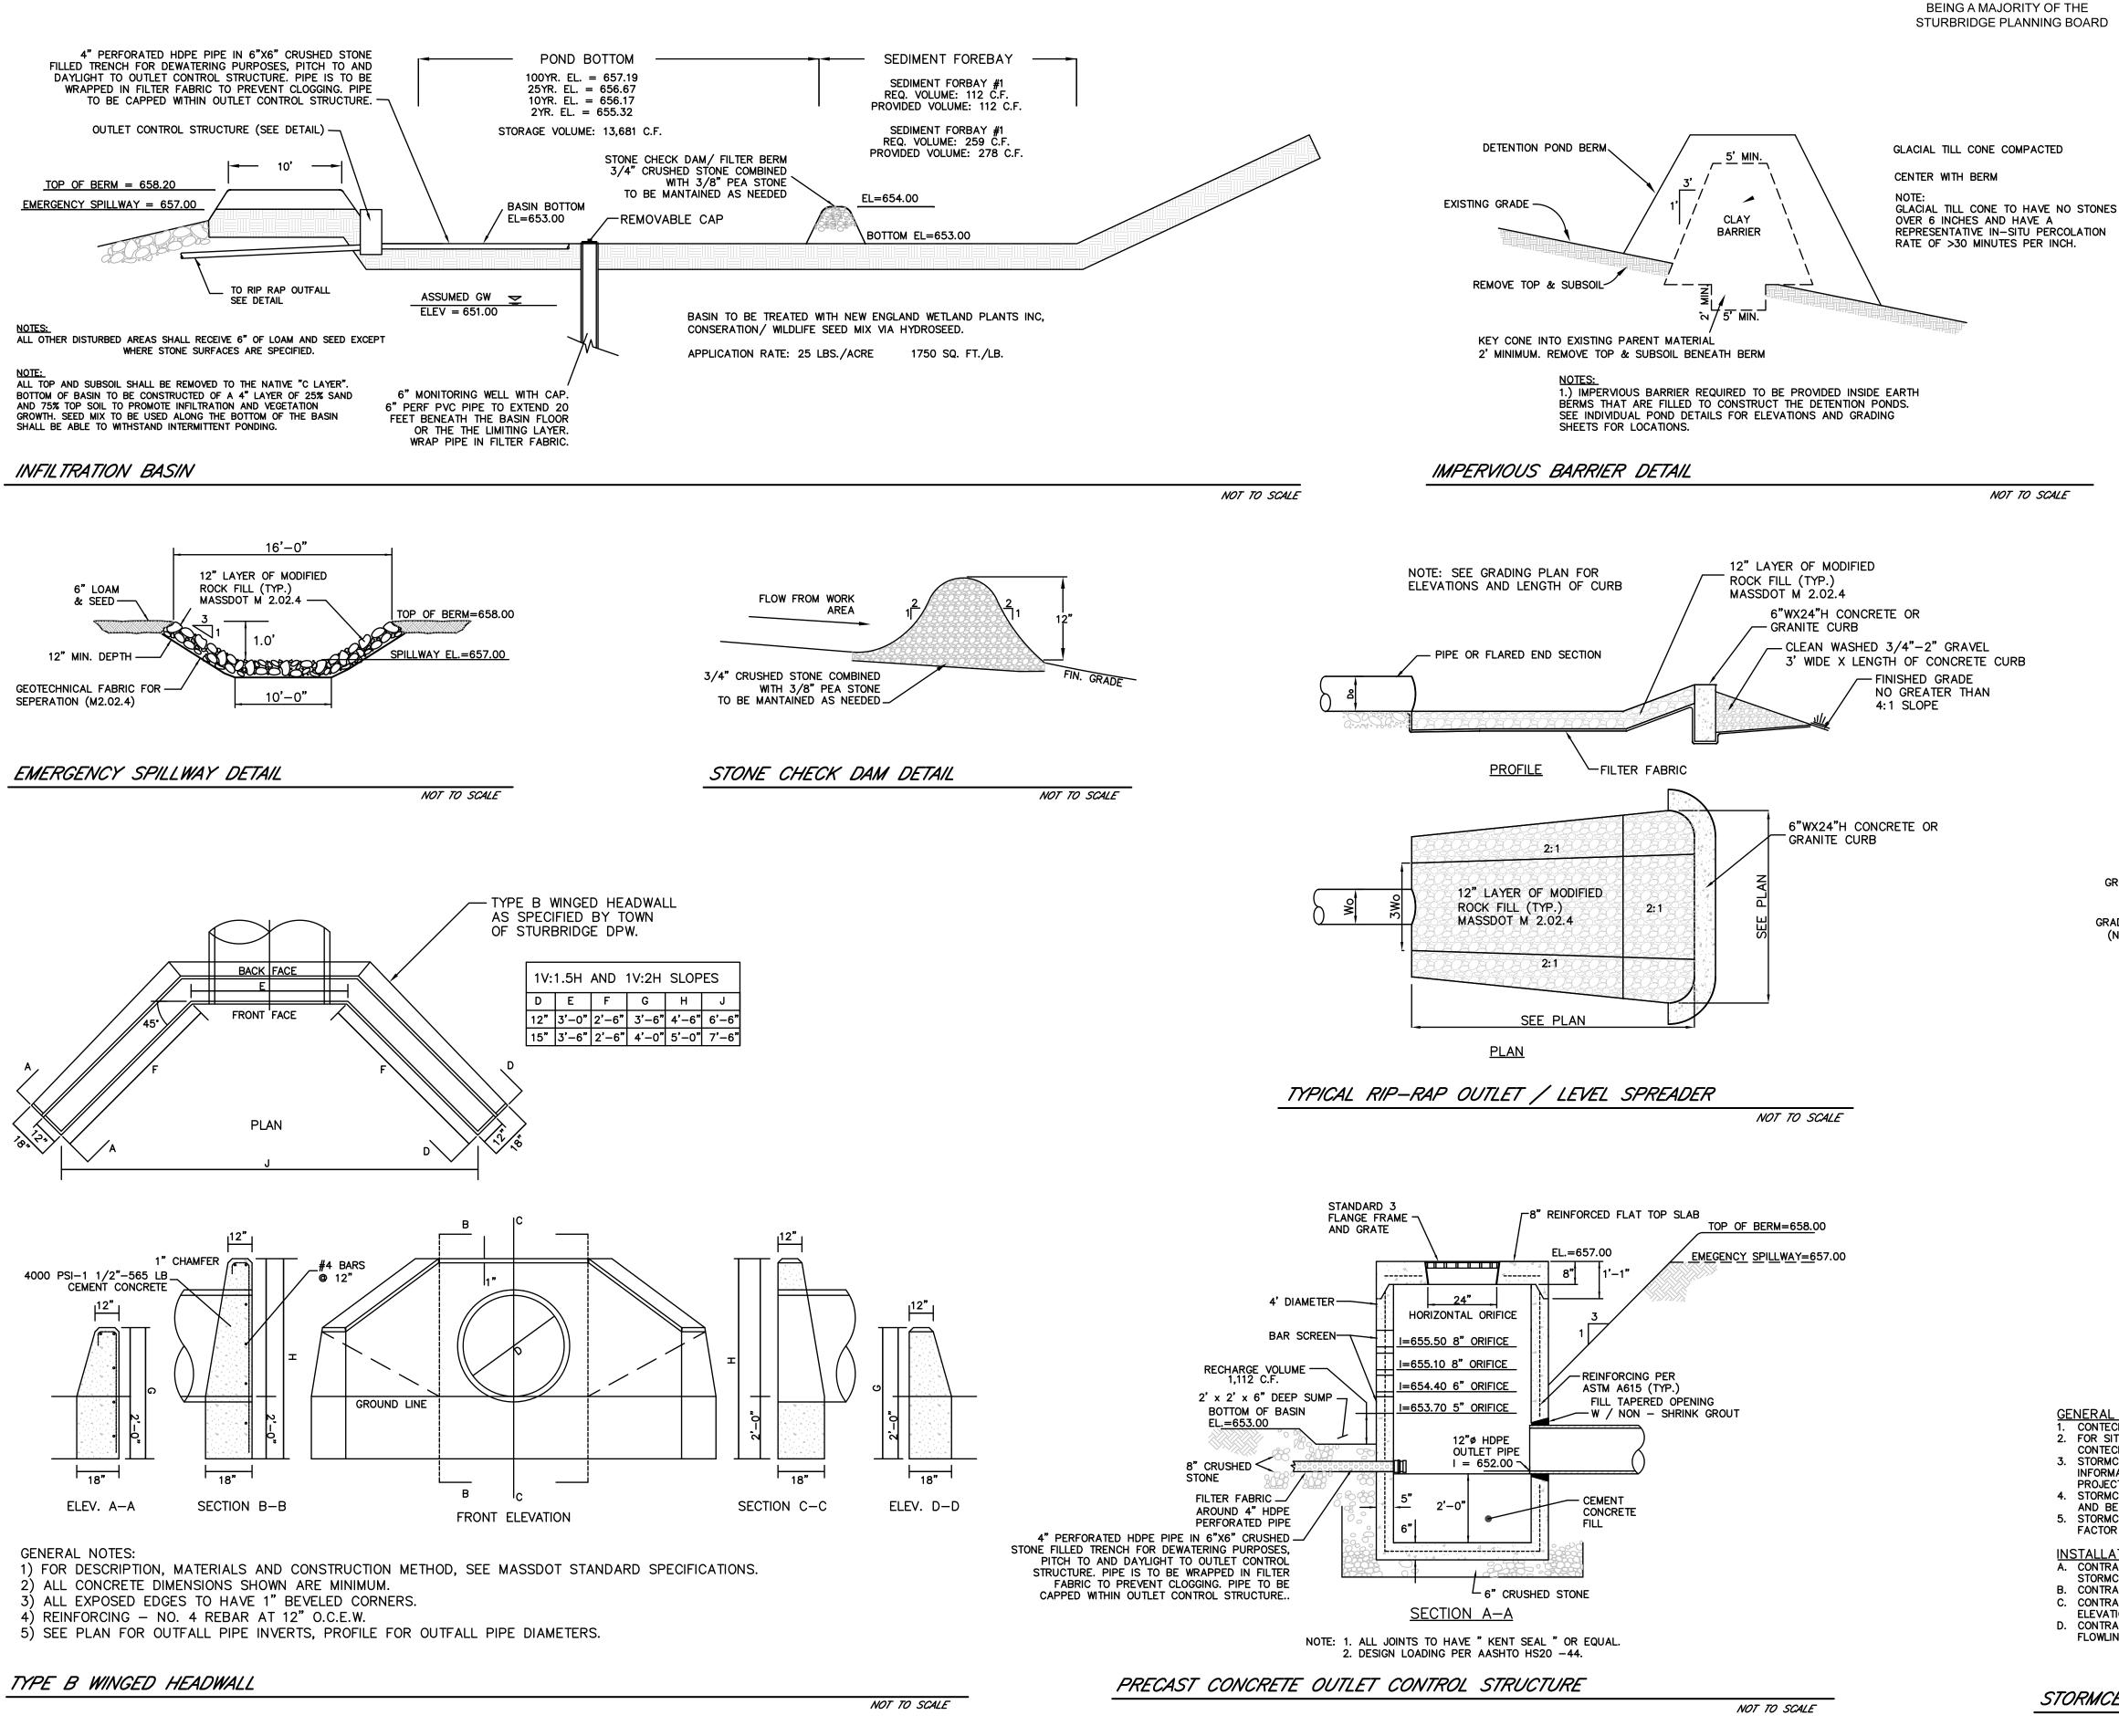NOTE:
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AND RECORDED BY ME ON (DATE)_____ AT (TIME)_ AND NO NOTICE OF APPEAL FROM SUCH APPROVAL WAS RECEIVED BY ME DURING THE TWENTY DAYS NEXT AFTER RECEIPT AND RECORDING OF SUCH NOTICE OF APPROVAL

TOWN CLERK

LOW END OF EACH RUN OF SUBDRAIN MUST BE TERMINATED AT A DRAINAGE STRUCTURE TO ENSURE THE COMPLETE REMOVAL OF ALL WATER COLLECTED IN THE SYSTEM.




SUBDRAIN DETAIL

NOT TO SCALE

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248 248

48" I.D. MANHOLE

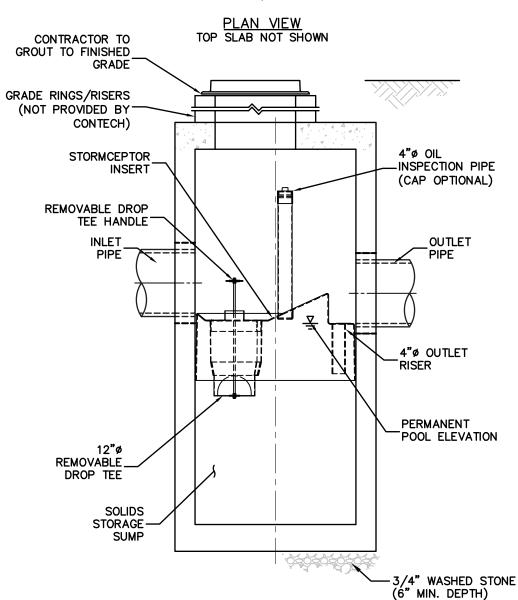

GENERAL NOTES

1. CONTECH TO PROVIDE ALL MATERIALS UNLESS NOTED OTHERWISE.

2. FOR SITE SPECIFIC DRAWINGS WITH DETAILED STRUCTURE DIMENSIONS AND WEIGHT, PLEASE CONTACT YOUR

SECTION A-A

- CONTECH ENGINEERED SOLUTIONS LLC REPRESENTATIVE.

 3. STORMCEPTOR WATER QUALITY STRUCTURE SHALL BE IN ACCORDANCE WITH ALL DESIGN DATA AND INFORMATION CONTAINED IN THIS DRAWING. CONTRACTOR TO CONFIRM STRUCTURE MEETS REQUIREMENTS OF
- 4. STORMCEPTOR STRUCTURE SHALL MEET AASHTO HS20 LOAD RATING. CASTINGS SHALL MEET AASHTO M306
- AND BE CAST WITH THE CONTECH LOGO.

 5. STORMCEPTOR STRUCTURE SHALL BE PRECAST CONCRETE CONFORMING TO ASTM C478 AND AASHTO LOAD FACTOR DESIGN METHOD.

- INSTALLATION NOTES

 A. CONTRACTOR TO PROVIDE EQUIPMENT WITH SUFFICIENT LIFTING AND REACH CAPACITY TO LIFT AND SET THE STORMCEPTOR MANHOLE STRUCTURE.
- B. CONTRACTOR TO INSTALL JOINT SEALANT BETWEEN ALL STRUCTURE SECTIONS AND ASSEMBLE STRUCTURE. C. CONTRACTOR TO PROVIDE, INSTALL, AND GROUT INLET AND OUTLET PIPE(S). MATCH PIPE INVERTS WITH
- ELEVATIONS SHOWN. ALL PIPE CENTERLINES TO MATCH PIPE OPENING CENTERLINES. D. CONTRACTOR TO TAKE APPROPRIATE MEASURES TO ASSURE UNIT IS WATER TIGHT, HOLDING WATER TO

FLOWLINE INVERT MINIMUM. IT IS SUGGESTED THAT ALL JOINTS BELOW PIPE INVERTS ARE GROUTED.

STORMCEPTOR 450 DETAILS

NOT TO SCALE

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11/11/20

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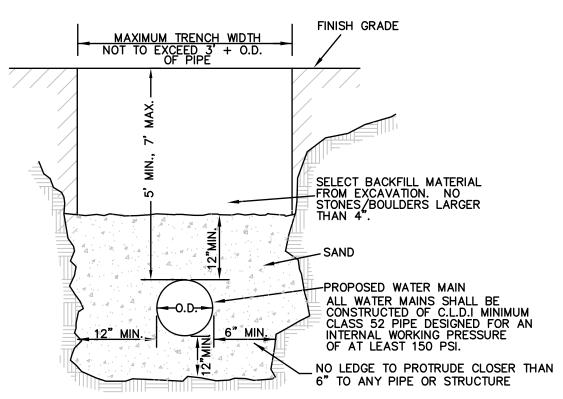
SITE DETAILS

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TOWN CLERK

WHERE THE WATER MAIN IS PROPOSED CROSS COUNTRY TO FISKE HILL RD, THE FINISHED GRADE IS TO MATCH EXISTING GRADE. DISTURBED SOILS ARE TO BE STABILIZED WITH BIODEGRADABLE JUTE



M+H 929 HYDRANT OR APPROVED EQUAL.

-6" HYDRANT

VALVES AND HYDRANTS TO OPEN COUNTER CLOCKWISE.

ELEVATION VIEW

NOTE: IF SIGNIFICANT LEDGE IS ENCOUNTERED IN THE COURSE OF ROADWAY OR UTILITY CONSTRUCTION, THE TOWN WILL BE INFORMED AND A PLAN FOR SOIL TESTS OR BORINGS AS WELL AS EXPECTED METHODS AND SCHEDULE OF REMOVAL SHALL BE SUBMITTED TO THE TOWN.

TYP. WATER MAIN TRENCH SECTION

8" C.L.D.I. WATER MAIN. ALL WATER MAINS SHALL BE CONSTRUCTED OF

BE PUSH-ON GASKETT JOINTS. —

C.L.D.I. MIN. CLASS 52 PIPE DESIGNED

FOR AN INTERNAL WORKING PRESSURE OF AT LEAST 200 PSI. ALL JOINTS TO

THRUST

BLOCK

- POLYETHYLENE

NETTING, LOAM AND SEED.

NOT TO SCALE

-BREAKAWAY **FLANGE**

CONCRETE THRUST BLOCK

1/2 C.Y. OF 1 1/2" STONE DRAINAGE SUMP

BUFFALO SERVICE BOX SHALL BE SET AT BACK OF CURB. IF NO CURB, SERVICE BOX SHALL BE SET ON STREET SIDE OF PROPERTY LINE OUT OF TRAVELED WAY. GRAVEL OR LOAM AND SEED (MATCH PREVIOUS MATERIAL) FINISH GRADE ADJUSTABLE VALVE BOX CORPORATION STOP W/ AWWA THREAD INLET MINIMUM 1" TYPE K PROVIDED BY 3/4" STONE 6" COPPER TUBING CONTRACTOR — / AROUND DRAIN COPPER SERVICE LINE PROPOSED WATER MAIN

FINISH GRADE

SELECT BACKFILL MATERIAL FROM EXCAVATION. NO STONES/BOULDERS LARGER

- "ELECTRICAL" MARKING TAPE

NOT TO SCALE

-ELECTRICAL CONDUITS

NOTES:

1) NO WATER PIPE DEPTH SHALL EXCEED 5 FEET FROM FINISHED GRADE

2) CONTRACTOR RESPONSIBLE FOR CONTACTING DIG SAFE PRIOR TO EXCAVATION TRENCH SHALL NOT BE BACKFILLED UNTIL SERVICE HAS BEEN INSPECTED AND APPROVED BY THE STURBRIDGE D.P.W. WATER SHALL BE TURNED ON BY THE SWD ONLY AFTER APPROVAL ONLY CONTRACTORS APPROVED BY THE SWD SHALL MAKE TAP WATER SERVICE LINES AND METER SHALL BE SIZED BY THE SWD ALL COMPACTION SHALL BE BY MECHANICAL MEANS AT NO GREATER THAN 12 INCH LIFTS NEW AND RENEWED SERVICES SHALL HAVE REMOTE READERS SERVICE SHALL BE FLUSHED BEFORE ACTIVATING TO AVOID METER CLOGGING

THERE SHALL BE A HORIZONTAL SEPARATION OF 10 FEET FROM ANY OTHER UTILITY LINE EXISTING CORPORATION SHALL BE CLEANED WHEN A SERVICE IS RENEWED SERVICE SHALL BE LAID PERPENDICULAR TO THE WATER MAIN UNTIL PROPERTY LINE THE STURBRIDGE D.P.W. RESERVES THE RIGHT TO MODIFY STANDARDS AT THEIR DISCRETION

CORPORATION STOPS, CURB STOPS AND SERVICE BOXES SHALL BE OF A TYPE APPROVED BY THE STURBRIDGE D.P.W.

TYPICAL DOMESTIC SERVICE CONNECTION

TYP. ELEC. TRENCH SECTION

NOT TO SCALE

— CONCRETE VALVE SEAT CLASS "B" — GATE VALVE WATER MIN. ONE LENGTH OF PIPE 3' LONG PIPE 4.0 SQ. FT. BEARING AREA LENGTH (MIN.) 4.5 SQ. FT BEARING - CONCRETE THRUST BLOCK UNDISTURBED

TYPICAL STUB FOR FUTURE CONNECTION

PLAN VIEW

NOT TO SCALE

WATER FLOWABLE FILL~ P.V.C. TEE CEMENT LINED DUCTILE IRON PIPE PVC SEWER PVC SEWER

THIS DETAIL IS TO BE USED ONLY WHEN THE BOTTOM OF THE WATER MAIN IS CLOSER THAN 18" TO THE TOP OF SEWER MAIN. IF THE WATER MAIN IS DAMAGED DURING CONSTRUCTION, THEN THE WATER MAIN MUST BE REPLACED FOR A DISTANCE OF 10' ON BOTH SIDES OF THE SEWER MAIN USING CEMENT LINED DUCTILE IRON PIPE & MECHANICAL JOINT SOLID SLEEVE FITTINGS.

CONCRETE ENCASEMENT CONCRETE -ENCASEMENT


---12" ΜΙΝ.-----

TYPICAL SEWER/WATER CROSSING


UTILITY CROSSING DETAILS

TYPICAL WATER/SEWER CROSSING

NOT TO SCALE

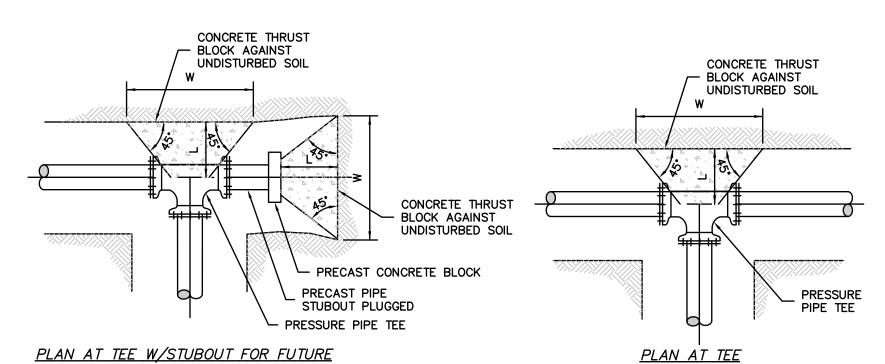

		CONCRETE THRUST BLOCK															
		22 1/2° BEND					45° BEND 90° BEND						TEE / CAP				
	D	BEARING AREA (S.F.)	"L"	"H"	"W"	BEARING AREA (S.F.)	"L"	"H"	"W"	BEARING AREA (S.F.)	"L"	"H"	"W"	BEARING AREA (S.F.)	"L"	"H"	"W"
	<8 "	1.5	0.5'	1.0'	1.5'	3.0	1.0'	1.5'	2.5'	5.5	1.0'	2.0'	3.0'	3.9	1.0'	2.0'	2.5'
	12"	3.5	1.0'	1.5'	2.5 '	6.5	1.0'	2.0'	<i>3.5</i> ′	12.0	1.5'	3.0'	<i>4.5</i> ′	8.5	1.5'	2.5'	4.0'
Ī	16"	6.0	1.0'	2.0'	3.0'	11.0	1.5'	3.0'	4.0'	20.5	2.0'	4.0'	5.5'	14.5	2.0'	3.5'	5.0'

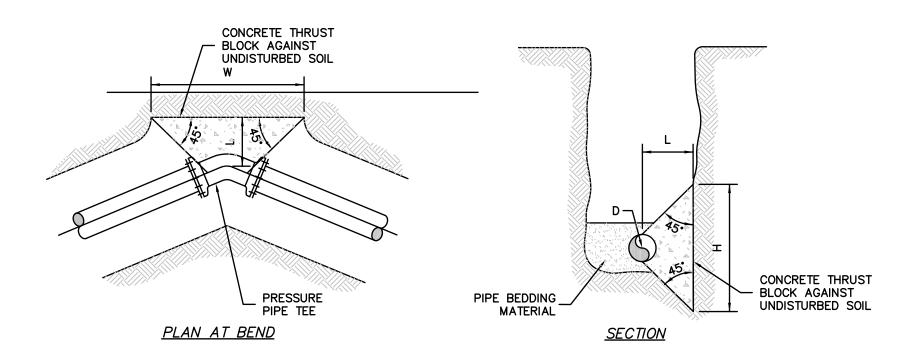

GENERAL NOTES:

1) DIMENSIONS SHOWN CALCULATED PER 120 PSI INTERNAL PIPE PRESSURE FOR SOIL BEARING LOADS OF 3,000 PSF.

- 2) CONSTRUCT CONCRETE THRUST BLOCKS OF CONCRETE POURED AGAINST UNDISTURBED SOIL.
 3) DIMENSIONS L, W, & H MAY BE ADJUSTED TO MEET FIELD CONDITIONS PROVIDED THE BEARING AREA REMAINS UNCHANGED.
- 4) THE HEIGHT OF THE BLOCK (H) SHALL BE LESS THAN OR EQUAL TO HALF THE TRENCH DEPTH.
 5) PLACE POLYETHYLENE SHEETING OVER MJ FITTINGS TO PREVENTS DIRECT CONTACT BETWEEN
- 6) THE STURBRIDGE WATER AND SEWER COMMISSION RESERVES THE RIGHT TO MODIFY STANDARDS AT THEIR DISCRETION.

CONCRETE THRUST BLOCK FOR HORIZONTAL BENDS AND TEES

NOT TO SCALE

(508) 248-2005 (508) 248-4887

ISKE HILL ROAD 1A 01566

DEFINITIVE SUBDIVISION PLAN LOCATED AT

30 MAIN

DRAWN BY: 11/11/20 СНК ВҮ: AS NOTED PROJ. NO. 287-2117-K


SITE DETAILS


CAST IRON 6"
MECHANICAL JOINT W/ M+H 929 HYDRANT OR APPROVED EQUAL — MEGA-LUG RESTRAINŤ — 6" M.J.R.W. GATE VALVE GLANDS HYDRANT TEE -(TO BE EPOXY COATED) LENGTH VARIES CONCRETE THRUST BLOCK THRUST BLOCK SCREENED GRAVEL SUMP UNDISTURBED

PLAN VIEW

TYPICAL HYDRANT W/GATE


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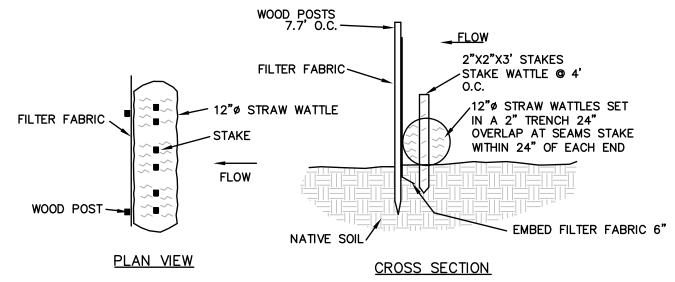


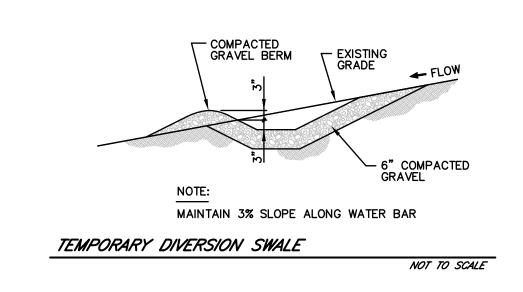

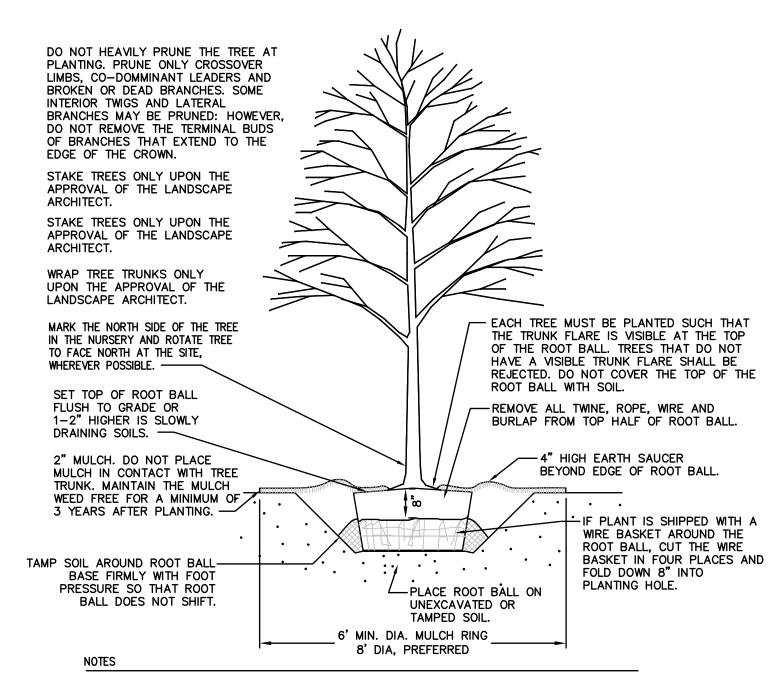1. PLEASE REFER TO INTRODUCTION AND USE CRITERIA PRIOR TO USING THIS DETAIL. 2. THIS DETAIL ASSUMES THAT THE PLANTING SPACE IS LARGER THAN 16 SQ. FT., OPEN TO THE SKY, AND NOT COVERED BY ANY PAVING OR GRATING.

TREE PLANTING DETAIL - B&B TREES IN ALL SOIL TYPES



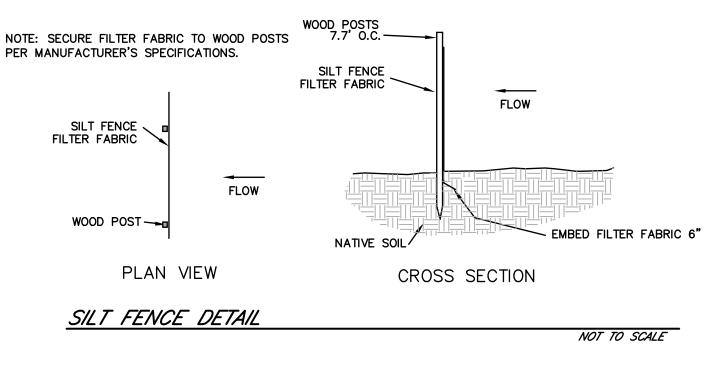

LUMINAIRE

STRAW WATTLE AND SILT FENCE DETAIL

NOT TO SCALE

MINIMUM 4" TOPSOIL

MINIMUM 12" WELL GRADED _

SLOPE STABILIZATION TREATMENT

SEED MIXTURE

LOAM & SEED DETAIL

CREEPING RED FESCUE 50%

PERENNIAL RYEGRASS 50%


EROSION CONTROL BLANKET CHART


ORDINARY BORROW

BIODEGRADABLE SINGLE JUTE NET STRAW BLANKET

BIODEGRADABLE DOUBLE NET COCONUT BLANKET

BIODEGRADABLE DOUBLE NET STRAW/COCONUT BLANKET

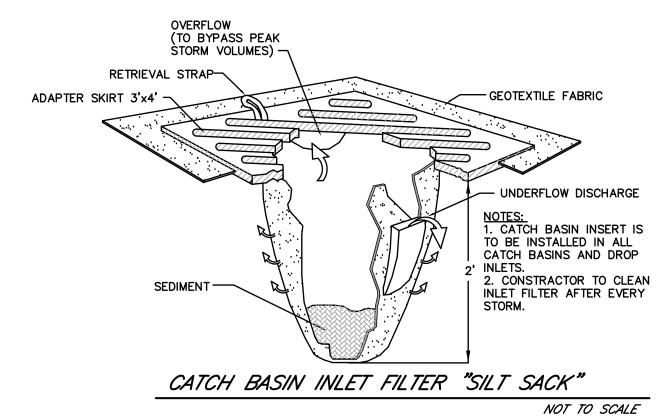

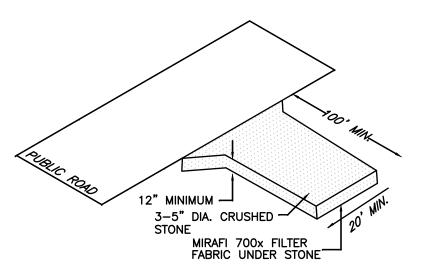

SLOPE. SEE CHART. INSTALLED PER

SCREENED TOPSOIL TO REMOVE

PLANT GROWTH

UNDISTURBED EARTH

NOT TO SCALE

DEBRIS AND OBJECTIONABLE WEEDS

FRIABLE AND LOAMY AND CONTAIN

NO TOXIC SUBSTANCE HARMFUL TO

AND STONES. TOPSOIL SHALL BE


- STAPLES/ ANCHORS

INSTALLED PER

MANUFACTURERS SPECS

STREET SIGN PRIVATE WAY SITE ENTRANCE MAT NOT TO SCALE BY THE TOWN - 2" DIA. STEEL SIGN POST (TYPICAL POLE USED FOR ALL STREET SIGNS) HYDROSEED WITH SPECIFIED SEED MIX PER PLAN. SEED PER MANUFACTURER'S SIGN AND POST TO BE APPROVED BY LOCAL DPW. EROSION CONTROL BLANKET DEPENDENT ON

STANDARD STREET SIGN DETAIL

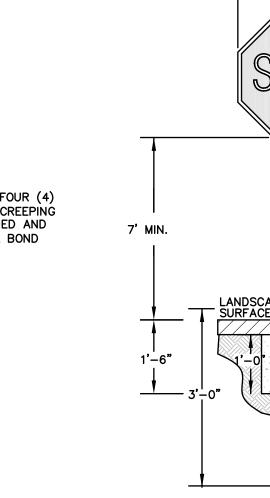

MANUFACTURERS SPECS NOT TO SCALE GRASS SEED SHALL BE SPREAD DURING THE GROWING SEASON AT THE RATE OF FOUR (4) POUNDS PER ONE THOUSAND (1,000) SQUARE FEET. IT SHALL BE A MIXTURE OF CREEPING RED FESCUE AND PERENNIAL RYE GRASS. IT SHALL BE PROPERLY FERTILIZED, LIMED AND WATERED. A GUARANTY PERIOD OF ONE (1) YEAR FROM FULL GROWTH AND FINAL BOND RELEASE SHALL BE HONORED BY THE SUBDIVIDER.

STOP SIGN DETAIL

NOT TO SCALE


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BEING A MAJORITY OF THE

5" LETTERS ON 9" BLUE BLANK BACKGROUND DOUBLE FACED EXTRUDED-ALUMINUM 248-248-

- SIGN INDICATING PRIVATE WAY TO BE INSTALLED UNTIL THE STREET IS ACCEPTED

NOT TO SCALE

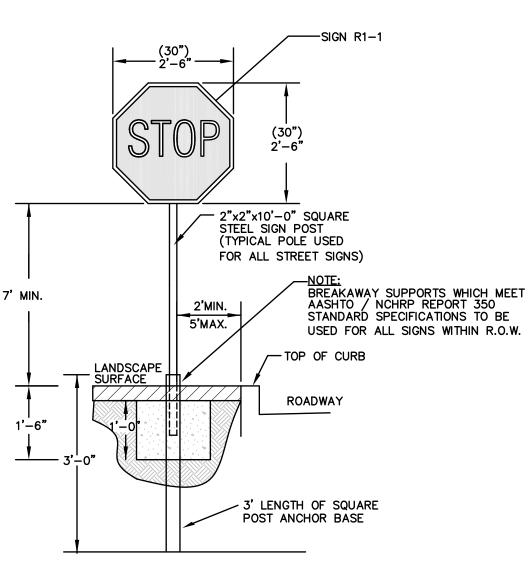


STURBRIDGE PLANNING BOARD ROAD

SUBDIVISION I ISKE MA 01 ITTIVE 30


DRAWN BY: 11/11/20 СНК ВҮ: AS NOTED PROJ. NO. 287-2117-

SITE DETAILS

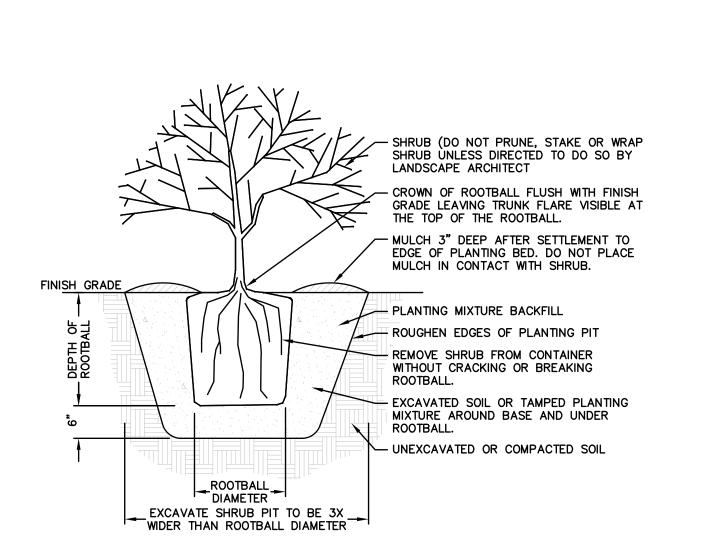

SHRUB PLANTING DETAIL

NOT TO SCALE

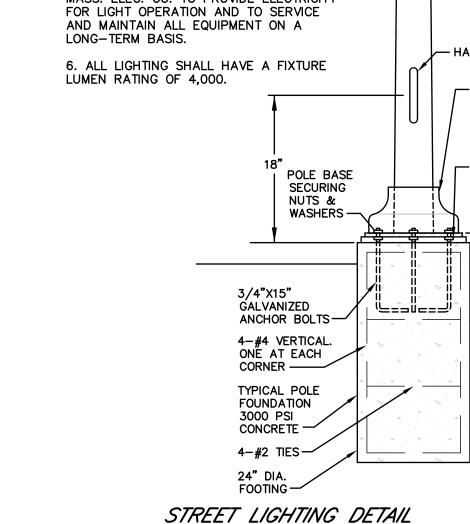

1. THE LIGHTING POLE SHALL BE PROVIDED

SHALL BE SUPPLIED ASSEMBLED WITH (2)


WITH (4) Ø3/4" X 24" LONG "L-TYPE"

ANCHÒR BOLTS. EACH ANCHOR BOLT

LOCK WASHER. THE POLE SHALL HAVE A ø10" BOLT CIRCLE AND REQUIRES A 3" ANCHOR BOLT PROJECTION. ALL ANCHORAGE HARDWARE SHALL BE FULLY 2. THE LUMINAIRE MOUNTS TO A $\emptyset 3" \times 3"$ TALL TENON. (3) 3/8"-16 UNC STAINLESS STEEL ALLEN HÉAD CUP POINT SET SCREWS SECURE LUMINAIRE TO POST TOP TENON. ALL MOUNTING HARDWARE SHALL BE STAINLESS STEEL. 3. ALL SPECIFICATIONS AND MATERIALS TO BE CONFIRMED BY THE MANUFACTURER AND APPROVED BY LOCAL AUTHORITIES BEFORE INSTALLATION. 4. LIGHTING TO BE INSTALLED IN ACCORDANCE WITH NATIONAL GRID/ MASS. ELEC. CO. "STREET LIGHTING -UNDERGROUND - DIVISION OF OWNERSHIP S-3" STANDARDS. 14'-0" 5. THE DEVELOPER, CONTRACTOR, OR PROPERTY OWNER SHALL PROVIDE, INSTALL, AND RETAIN OWNERSHIP OF ALL LIGHTING EQUIPMENT AND CONTRACT DIRECTLY WITH MASS. ELEC. CO. TO PROVIDE ELECTRICITY — HANDHOLE - ANCHOR SHROUD BASE LEVELING NUTS & WASHERS GRADE

NOT TO SCALE

UNTIL THE PLAN METRIAL HAS TAKEN ROOT, WATER THE RAIN GARDEN ON A DAILY BASIS. IN ADDITION, WATER THE RAIN GARDEN DURNG DROUGHT CONDITIONS. INSPECT THE SOIL AN DREPAIR ERODED AREAS OF THE RAIN GARDEN MONTHLY. RE-MULCH VOID AREAS AS NEEDED. REMOVE LITER AND DEBRIS MONTHLY. TREAT DISEASED VEGETATION AS NEEDED. REMOVE AND REPLACE DEAD VEGETATION TWICE PER YEAR (SPRING AND FALL). REMOVE INVASIVE SPECIES INCLUDING WEEDS AS NEEDED TO PREVENT THESE SPECIES FROM SPRÉADING INTO THE RAIN GARDEN. REPLACE MULCH EVERY TWO YEARS, IN THE EARLY SPRING. UPON FAILURE, EXCAVATE THE RAIN GARDEN AREA, SCARIFY THE BOTTOM AND SIDES, REPLACE SOIL, REPLANT, AND MULCH.

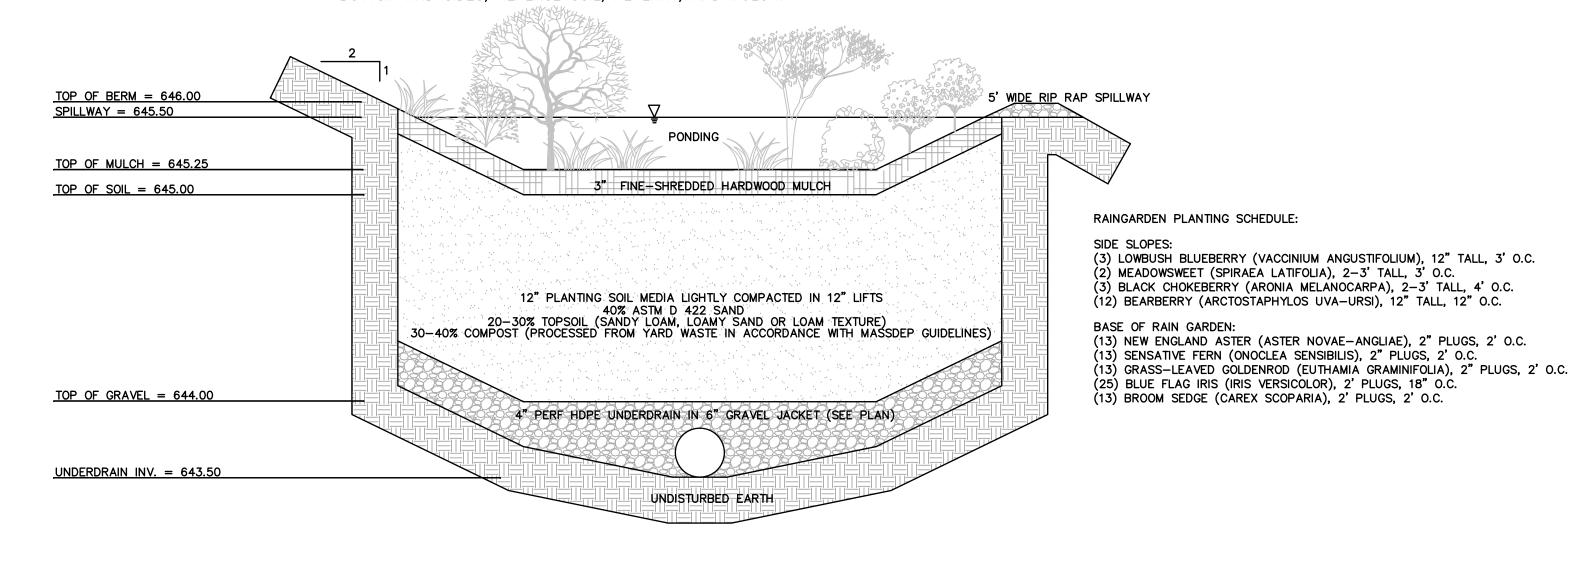

RAIN GARDEN (BIORETENTION AREA)

- MEET EXISTING GRADE MEET EXISTING GRADE -NOTE: ALL SLOPES SHALL BE STABILIZED WITH -4" LOAM & SEED 4" LOAM & SEED-BIODEGRADABLE EROSION CONTROL BLANKETS OR JUTE NETTING IMMEDEIATELY AFTER GRADING. - PROPOSED GRADE PROPOSED GRADE -(SEE DETAIL) SILT FENCE AT —EXISTING GRADE START OF RESTORATION--SILT FENCE AT START OF REPLICATION AREA

RESTORATION AREA (APPROX. 390 S.F.)

PLANTING SCHEDULE:

6 TOTAL SHRUBS FROM THE FOLLOWING SPECIES:

NATIVE HIGHBUSH BLUEBERRY (VACCINIUM CORYMBOSUM) NORTHERN ARROWWOOD (VIBURNUM RECOGNITUM) COMMON WINTERBERRY (ILEX VERTISILLATA)

TYPICAL 8' SPACING

BUSHES ARE TO BE 1.5'-3' TALL

REMOVED FROM THE AREA SHALL BE USED. (ALL DISTURBED SOILS WILL BE MULCHED WITH CLEAN STRAW OR PEAT MOSS TO PREVENT EROSION AND TO REDUCE EVAPORATON). PROPOSED GRADE - PLANT SURFACE AREA WITH WETLAND SPECIES INDIGENOUS TO THE EXISTING WETLANDS. NATIVE WETLAND SILT FENCE AT EXISTING GRADE SEED MIX FOR MOIST AREAS TO BE EXISTING WETLANDS -SPREAD AFTER PLANTINGS AND STABILIZED —SILT FENCE AT WITH WEED FREE STRAW. START OF REPLICATION AREA **EXISTING** WETLANDS -**EXISTING** WETLANDS

. THE EROSION CONTROL BARRIER BARRIER SHALL BE MAINTAINED IN PLACE UNTIL THE RESTORATION AREA IS STABLE WITH VEGETATION AND UPON APPROVAL FROM THE CONSERVATION COMMISSION. 2. THE GROUND WATER AND SURFACE ELEVATION OF THE RESTORATION AREA SHALL BE EQUAL TO THAT OF THE ORIGINAL WETLAND. THE WETLAND SCIENTIST SHALL DETERMINE WHEN IN SITU HYDRIC SOILS HAVE BEEN UNCOVERED AND ADEQUATE FILL REMOVAL HAS OCCURRED.

3. FILL REMOVAL AND GRADING SHALL COMMENCE WITH HEAVY EQUIPMENT AND HAND/SHOVEL AT THE PROPOSED LIMIT OF WORK AREA, AS DEPICTED ON THE SITE PLAN. EXCAVATES SHALL BE MOVED TO AN AREA OUTSIDE OF THE BUFFER ZONE.

4. THE OVERALL HORIZONTAL CONFIGURATION AND LOCATION OF THE RESTORATION AREA WITH RESPECT TO THE BANK SHALL BE SIMILAR TO THAT OF THE ORIGINAL WETLAND.

5. THE RESTORATION AREA SHALL HAVE AN UNRESTRICTED HYDRAULIC CONNECTION TO THE SAME WATER BODY OR WATERWAY ASSOCIATED WITH THE LOST AREA.

6. PLANTING SHALL BE DONE ONLY DURING THE BEGINNING (APRIL 15 THROUGH JULY 1) OR END (SEPTEMBER 15 TO NOVEMBER 1) OF THE GROWING SEASON. PLANTING IN THE SUMMER SEASON IS ONLY ACCEPTABLE IF IRRIGATION IS PROVIDED. THE PLANT SPECIES IDENTIFIED SHALL BE PLANTED IN THE RESTORATION AREA FROM NURSERY STOCK FROM A REPUTABLE SUPPLIER, SUCH AS NEW ENGLAND WETLAND PLANTS, BIGELOW NURSERY, WESTIN NURSERY, ETC. SHRUBS SHALL BE PLANTED AT APPROXIMATELY 8 FEET ON-CENTER SPACING. PLANTING HOLES SHALL BE A MINIMUM OF 1.5 TIMES THE

DIAMETER OF THE PLANT ROOT BALL 7. THE PLANTED RESTORATION AREA WILL BE MULCHED WITH A THICK LAYER OF SALT MARSH HAY, WEED-FREE STRAW, OR HYDRAULICALLY APPLIED HYDROMULCH TO PROVIDE FOR TEMPORARY EROSION

CONTROL AND MOISTURE RETENTION; 8. AT LEAST 80% OF THE SURFACE OF THE REPLACEMENT AREA SHALL BE REESTABLISHED WITH INDIGENOUS WETLAND PLANT SPECIES WITHIN FIVE YEARS OF MONITORING, AND PRIOR TO SAID VEGETATIVE REESTABLISHMENT ANY EXPOSED SOIL IN THE RESTORATION AREA SHALL BE TEMPORARILY STABILIZED TO PREVENT EROSION IN ACCORDANCE WITH STANDARD U.S. SOIL CONSERVATION SERVICE METHODS. 9. THE RESTORATION WORK SHALL BE PROVIDED IN A MANNER WHICH IS CONSISTENT WITH ALL OTHER GENERAL PERFORMANCE STANDARDS FOR EACH RESOURCE AREA IN PART III OF 310 CMR 10.00. 10. THE PROPOSED WORK SHALL BE CONDUCTED UNDER THE SUPERVISION OF THE QUALIFIED SOIL OR WETLAND SCIENTIST

WETLAND RESTORATION DETAIL

NOT TO SCALE


NOT TO SCALE

- EXCAVATE TO ORIGINAL WETLAND GRADE AND SOILS. IF EXISTING SOILS ARE NOT SUITABLE,

QUALITY TOPSOIL, MANURE AND PEAT MOSS. ANY ORGANIC SOILS AND/OR VEGETATION

REPLACE WITH 12" LAYER OF ORGANIC SOIL BASE OR A MIXTURE OF EQUAL PARTS OF GOOD

APPROVED UNDER THE SUBDIVISION CONTROL LAW PLANNING BOARD OF STURBRIDGE _ THIS IS TO CERTIFY THAT NOTICE FROM THE PLANNING BOARD OF STURBRIDGE APPROVAL OF THIS PLAN WAS RECEIVED FROM _ AND RECORDED BY ME ON (DATE)_____ AT (TIME)_ AND NO NOTICE OF APPEAL FROM SUCH APPROVAL WAS RECEIVED BY ME DURING THE TWENTY DAYS NEXT AFTER RECEIPT AND RECORDING OF SUCH NOTICE OF APPROVAL TOWN CLERK BEING A MAJORITY OF THE STURBRIDGE PLANNING BOARD

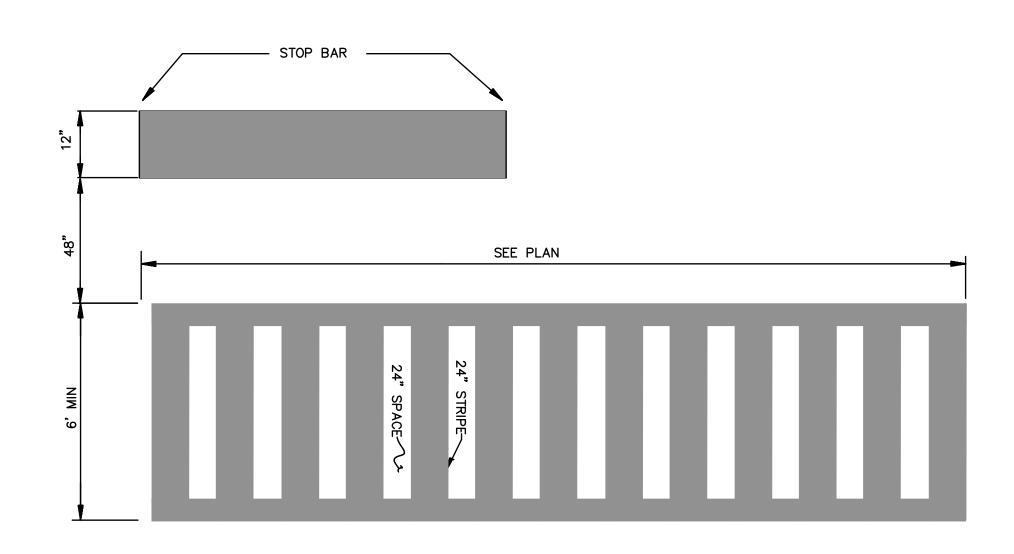

1. MARKINGS FOR STREET SHALL BE ACCORDING TO REQUIREMENTS AS OUTLINED IN SECTION 3B OF THE MANUAL ON UNIFORM TRAFFIC CONTROL DEVICES FOR STREETS AND HIGHWAYS.

2. THESE MARKINGS ARE TO BE PAINTED REFLECTIVE WHITE.

3. ALL LINES SHALL BE APPLIED IN ONE APPLICATION, NO COMBINATION OF LINES (FOUR 6" LINES INSTEAD OF ONE 24" LINE) WILL BE


4. ALL CROSSWALKS SHALL CONFORM TO THE RELEVANT PROVISIONS OF THE MASSACHUSETTS HIGHWAY DEPARTMENT "STANDARD SPECIFICATIONS FOR HIGHWAYS AND BRIDGES" DATED 1988 (AS AMENDED).


CROSSWALK PAVEMENT MARKINGS DETAIL

NOT TO SCALE

PROTOCOL/ NOTES:

1. AN EROSION CONTROL BARRIER BARRIER SHALL BE MAINTAINED IN PLACE BETWEEN THE WETLAND AND THE RESTORATION AREA UNTIL THE RESTORATION AREA IS STABLE WITH VEGETATION AND UPON APPROVAL FROM THE CONSERVATION COMMISSION. 2. FILL REMOVAL AND GRADING SHALL COMMENCE WITH HEAVY EQUIPMENT AND HAND/SHOVEL AT THE PROPOSED LIMIT OF WORK AREA, AS DEPICTED ON THE SITE PLAN. EXCAVATES SHALL BE MOVED TO AN AREA OUTSIDE OF THE BUFFER 2. THE RESTORATION WORK SHALL BE PROVIDED IN A MANNER WHICH IS CONSISTENT WITH ALL OTHER GENERAL PERFORMANCE STANDARDS FOR EACH RESOURCE AREA IN PART III OF 310 CMR 10.00.
4. THE PROPOSED WORK SHALL BE CONDUCTED UNDER THE SUPERVISION OF THE QUALIFIED SOIL OR WETLAND 5. COIR LOGS SHALL BE INSTALLED AT THE BANKS OF THE STREAM CHANNEL RESTORATION PER MANUFACTURER'S SPECIFICATIONS.

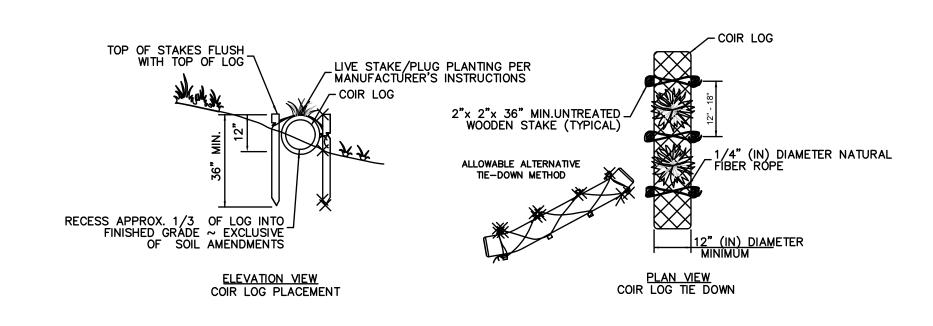

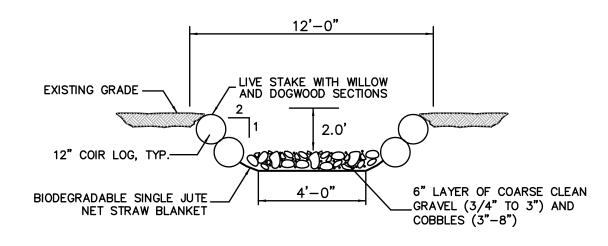

STREAM CHANNEL RESTORATION DETAIL

NOT TO SCALE

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DEFINITIVE

SKE A 01

MAIN 30

DRAWN BY: WCN 11/11/20 CHK BY: AS NOTE PROJ. NO. 287-2117-k

SITE DETAILS