
- 1.) PROPERTY LINES/SITE FEATURES ARE THE RESULT OF AN ON THE GROUND SURVEY PERFORMED BY SUMMIT ENGINEERING & SURVEY, INC.
- 2.) ALL MATERIALS AND CONSTRUCTION PRACTICES SHALL BE IN CONFORMANCE WITH THE LATEST EDITION OF THE TOWN OF STURBRIDGE'S DEPARTMENT OF PUBLIC WORKS & PARKS STANDARD SPECIFICATIONS & DETAILS, UNLESS OTHERWISE SPECIFIED BY LOCAL AUTHORITY OR THE ENGINEER.
- 3.) THE CONTRACTOR SHALL UTILIZE ALL MEASURES AND MATERIALS NECESSARY TO ENSURE THE SAFETY OF ALL PERSONS AND PROPERTIES AT THE SITE DURING CONSTRUCTION. ALL EXCAVATIONS SHALL CONFORM TO CURRENT OSHA STANDARDS.
- 4.) UNLESS OTHERWISE NOTED, ALL DISTURBED AREAS SHALL BE DRESSED WITH A MINIMUM OF FOUR INCHES (4") OF LOAM AND SHALL BE SEEDED WITH AN APPROVED GRASS MIX.
- 5.) THE CONTRACTOR SHALL PROVIDE APPROPRIATE EROSION AND SEDIMENTATION CONTROL MEASURES AT ALL TIMES. DEWATERING OPERATIONS SHALL BE PROVIDED, IF REQUIRED; ALL DISCHARGE SHALL PASS THROUGH SEDIMENTATION CONTROL DEVICES TO PREVENT IMPACTS UPON WATER BODIES, BORDERING VEGETATED WETLANDS, DRAINAGE SYSTEMS AND ABUTTING PROPERTIES.
- 6.) DISTURBED AREAS SHALL BE STABILIZED BY LOAMING AND SEEDING SOON AFTER THE FINISHED GRADE HAS BEEN MET. IF FINAL GRADING DOES NOT OCCUR DURING THE GROWING SEASON, THESE AREAS SHALL BE MULCHED WITH HAY SECURED BY WEIGHTED SNOW FENCE, CHICKEN WIRE MESH OR JUTE NETTING WITH STAPLES. SEED FOR PERMANENT GRASS COVER SHOULD BE ACCORDING TO SOIL CONSERVATION SERVICE GUIDELINES FOR SOIL AND MOISTURE CONDITIONS FOUND ON THE SITE.
- 7.) SEDIMENTATION CONTROL FENCE AND/OR HAY BALES SHALL BE MAINTAINED UNTIL ALL SLOPES HAVE BEEN STABILIZED AND THERE IS NO DANGER OF EROSION DIRECTLY ONTO ABUTTING PROPERTIES.
- 8.) PRIOR TO INITIATING CONSTRUCTION, SEDIMENTATION CONTROL DEVICES SHALL BE INSTALLED . THE CONTRACTOR SHALL MAINTAIN THE DEVICES UNTIL ALL WORK IS COMPLETE AND ALL AREAS HAVE BEEN STABILIZED.
- 9.) IF THE PROPOSED ROADWAY AREAS ARE NOT PAVED IMMEDIATELY AFTER THE INSTALLATION OF THE DRAINAGE STRUCTURES, HAY BALES SHALL BE PLACED TO PROTECT THE INTEGRITY OF THE STRUCTURES.
- 10.) THE LOCATION OF UNDERGROUND UTILITIES AND STRUCTURES ARE BASED ON FIELD AND RECORD INFORMATION. THE ENGINEER DOES NOT GUARANTEE THEIR ACCURACY OR THAT ALL UTILITIES AND SUBSURFACE STRUCTURES ARE SHOWN. THE CONTRACTOR SHALL VERIFY SIZE, LOCATION AND INVERT ELEVATIONS OF STRUCTURES AND UTILITIES, AS REQUIRED PRIOR TO THE START OF CONSTRUCTION. ANY DISCREPANCIES WITH RECORD DATA SHALL BE REPORTED TO THE ENGINEER IMMEDIATELY. PRIOR TO, AND DURING CONSTRUCTION, THE CONTRACTOR SHALL NOTIFY AND COORDINATE WITH THE LOCAL UTILITY COMPANIES, WITH THE TOWN OF STURBRIDGE'S HIGHWAY DEPARTMENT, OTHER TOWN UTILITY DEPARTMENTS, APPLICABLE PRIVATELY OWNED UTILITY COMPANIES AND DIG-SAFE (1-888-344-7233) TO VERIFY UTILITY LOCATION AND TO PROTECT UTILITIES DURING AND AFTER CONSTRUCTION.
- 11.) IT SHALL BE THE RESPONSIBILITY OF THE CONTRACTOR TO COORDINATE HIS WORK WITH THE APPROPRIATE HIGHWAY AND UTILITY DEPARTMENTS. CONTRACTOR SHALL MAINTAIN ALL EXISTING AND NEWLY INSTALLED UTILITIES IN GOOD WORKING ORDER AND SHALL PROTECT THEM FROM DAMAGE AT ALL TIMES UNTIL THE WORK IS COMPLETED AND ACCEPTED.
- 12.) THE CONTRACTOR SHALL PROVIDE FOR ALL TRAFFIC CONTROL IN ACCORDANCE WITH THE TOWN OF STURBRIDGE REQUIREMENTS.
- 13.) NO TRENCHES SHALL BE ALLOWED TO REMAIN OPEN OVERNIGHT.
- 14.) ALL POTABLE WATER AND SANITARY BUILDING SERVICE CONNECTIONS SHALL BE SEPARATED HORIZONTALLY BY A MINIMUM OF TEN FEET.
- 15.) TREE WORK MUST BE COMPLETED BY COMPANIES HOLDING CURRENT COMPLIANCE AGREEMENTS WITH THE MASSACHUSETTS LONGHORNED BEETLE ERADICATION PROJECT. ANY COMPANY CAN BECOME COMPLIANT BY ATTENDING A TRAINING SESSION AT THE PROGRAM OFFICE IN WORCESTER, MA.



UTILITIES ARE PLOTTED FROM FIELD LOCATION AND ANY RECORD INFORMATION AVAILABLE, AND SHOULD BE CONSIDERED APPROXIMATE. OTHER UTILITIES MAY EXIST WHICH ARE NOT EVIDENT OR FOR WHICH RECORD INFORMATION WAS NOT AVAILABLE. CONTRACTORS (IN ACCORDANCE WITH MASS.G.L. CHAPTER 82 SECTION 40 AS AMENDED) MUST CONTACT ALL UTILITY COMPANIES BEFORE EXCAVATING AND DRILLING. ALSO, CALL "DIG-SAFE" AT 1(888)344-7233 {1(888)DIG-SAFE}.

EXISTING LINES OTHER THAN THOSE INDICATED ON THESE DRAWINGS MAY BE ON THE SITE. THE CONTRACTOR IS WARNED TO PROCEED WITH CAUTION WITH ALL WORK, ESPECIALLY EXCAVATION WORK, AND TO MAKE ALL POSSIBLE INVESTIGATIONS AS TO POSSIBLE UNMARKED UTILITY LINES.

DEFINITIVE SITE PLAN at 6 PICKER ROAD STURBRIDGE, MA

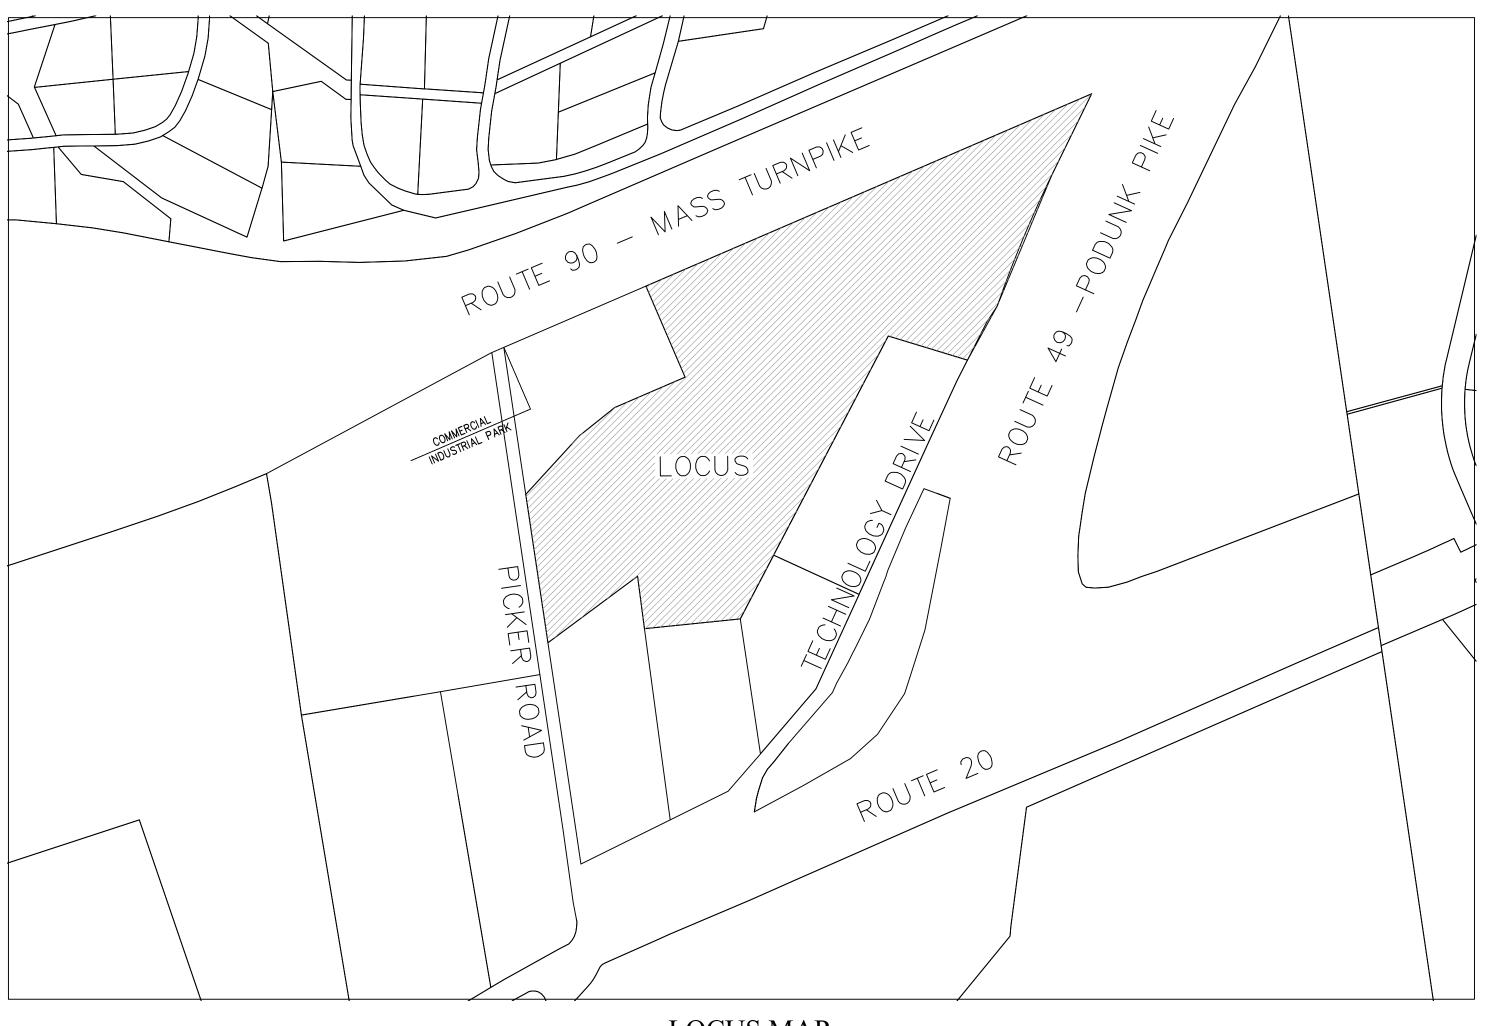

 $\frac{LOCUS\ MAP}{SCALE:\ 1"\ =\ 250' \pm}$

LIST OF DRAWINGS:

SHEET - 1	COVER SHEET	SHEET - 14	LAYOUT/UTILITY
SHEET - 2	EXISTING CONDITIONS	SHEET - 15	LAYOUT/UTILITY
SHEET - 3	EXISTING CONDITIONS	SHEET - 16	LANDSCAPE
SHEET - 4	EROSION & SEDIMENTATION CONTROL	SHEET - 17	LANDSCAPE
SHEET - 5	EROSION & SEDIMENTATION CONTROL	SHEET - 18	PROFILE
SHEET - 6	DEMO PLAN	SHEET - 19	PROFILE
SHEET - 7	DEMO PLAN	SHEET - 20	CONSTRUCTION DETAILS
SHEET - 8	GRADING	SHEET - 21	CONSTRUCTION DETAILS
SHEET - 9	GRADING	SHEET - 22	CONSTRUCTION DETAILS
SHEET - 10	DRAINAGE	SHEET - 23	CONSTRUCTION DETAILS
SHEET - 11	DRAINAGE	SHEET - 24	CONSTRUCTION DETAILS
SHEET - 12	PAVING PLAN		

SHEET - 13

PAVING PLAN

DIMENSIONAL REQUIREMENTS ZONE: INDUSTRIAL PARK

ZONE: INDUSTRIAL PAR	RK	
	MAX./REQUIRED	PROVIDED
LOT AREA: FRONTAGE: BUILDING HEIGHT (MEAN):	87,120 SQ. FT. 300' 35'	788,940 SQ. FT. 390.57' 56'-6 1/2" (SPECIAL PERMI' REQUIRED SEE TOWN WARRENT JUNE 2020)
LOT COVERAGE: IMPERVIOUS SURFACE: SETBACK REQUIREMENTS	33% 70%	15% 30%
FRONT: SIDE: REAR:	60' 30' 30'	420' 50' 150'

____S

FOR PERMITTING ONLY:
NOT FOR CONSTRUCTION

<u>LEGEN</u>D

DRILL HOLE FOUND

SEWER MANHOLE

ELECTRIC MANHOLE TELEPHONE MANHOLE

WATER MANHOLE

MONITORING WELL

WATER SHUT OFF HYDRANT

LIGHT POLE / LAMP POST

OBSERVATION TEST PIT HYDRIC SOIL TEST PIT

SHRUBS, BUSHES, ETC.

VERTICAL GRANITE CURBING CONCRETE CURBING

CAPE COD BERM (BITUMINOUS)

BITUMINOUS CURBING (GENERIC)

DECIDUOUS TREE

CONIFEROUS TREE
WETLAND FLAG

BOULDER

ELECTRIC LINE

SEWER LINE

DRAIN LINE

WATER LINE GAS LINE

TREE LINE

— — — EDGE OF PAVEMENT

EDGE OF LANDSCAPING

BORDERING VEGETATED WETLANDS

RECORD OWNER:

Bk. 34336 Pg. 243

TELEPHONE LINE

CABLE TELEVISION

FENCING (AS NOTED)

GUARD RAILING (AS NOTED)

ONE PICKER REALTY TRUST

ASSESSORS ID: 510-02215-0006

DANIEL PROUTY, TRUSTEE

BENCHMARK

GAS VALVE

SPOT LIGHT

MAILBOX (MBX)

CATCH BASIN

CLEANOUT

ANCHOR UTILITY POLE WATER GATE VALVE

UNDETERMINED MANHOLE

DRAIN MANHOLE

STONE OR CONCRETE MONUMENTS





380 Interstate North Pkwy. SE, Atlanta, GA 30339 Suite 210 770,541,1700





710 Main Street North Oxford, MA 01537



NEW ENGLAND COLD STORAGE, LLC.

6 PICKER ROAD STURBRIDGE, MA

COVER

7/17/20 - SITE LAYOUT RE-DESIGN

 SCALE:
 AS SHOWN

 DATE:
 MAY 12, 2020

 JOB NO:
 20-122

 PLAN NO:
 20-122 DEFINITIVE SITE PLAN

 SHEET NO:
 1 OF 24

6/1/20 - PER CONSERVATION COMMISSION COMMENTS
REVISIONS

PLAN NOTES: 1. EXISTING AND BOUNDARY CONDITIONS ARE THE RESULT OF AN ON THE GROUND SURVEY PERFORMED BY SUMMIT ENGINEERING & SURVEY, INC. 2. WETLAND FLAGS DELINEATED BY EBT ENVIRONENTAL, INC. AND LOCATED BY SUMMIT ENGINEERING & SURVEY, INC. 3. BORING TESTS PERFORMED BY WHITESTONE ASSOCIATES, INC. ON 3/18/2020. REFER TO "REPORT OF GEOTECHNICAL FINDINGS, PROPOSED COLD STORAGE FACILITY, SIX PICKER ROAD, MAP 510 BLOCK 2215 LOT 6, STURBRIDGE WORCESTER COUNTY MASSACHUSETTS" DATED APRIL 10, 2020 BY WHITESTONE ASSOCIATES, INC. PROJECT NO.: GM2017067.000. 4. DEED REFERENCE: BOOK 34336 PAGE 243 PLAN REFERENCE: PLAN BOOK 947 PLAN 61 EXISTING BUILDING EXISTING LEACH FIELD TANK 8 PICKER ROAD, LLC Bk. 61868 Pg.24 INV. 15" CMP ELEV.=712.38' ASSESSORS ID: 510-02215-008 #8 PICKER ROAD ——S——S——S SEWER LINE ____D___D___D DRAIN LINE @12" w/R&E ——G—G—G—G—GAS LINE 10ŸR 4/3 &4/2 ____T___T___T___T___TELEPHONE LINE F F F F F FIRE PROTECTION LINE
OHW—OHW—OHW—OVERHEAD WIRES ____C__C__C__C CABLE TELEVISION RD RD RD ROOF DRAIN ---- --- EDGE OF PAVEMENT ——X——X——X———X———— FENCING (AS NOTED) GUARD RAILING (AS NOTED) H20@ 3.0' TREE LINE REF.@ 3.0' EDGE OF LANDSCAPING · · · BORDERING VEGETATED WETLANDS B-21 LEDGE @ 6.0' B-17 LEDGE @ 8.0' – EX. LEVEL SPREADEI — EX. 18" RCP LEDGE @ 8.8' INV.=722.3' TP-3H20@ 2.0' B-12 - LEDGE @ 5.5' REF.@ 2.8' LEDGE @ 4.0 n/f
51 TECHNOLOGY, LLC
Bk. 60180 Pg.104
ASSESSORS ID: 637-02215-051
#51 TECHNOLOGY PARK ROAD B-15 LEDGE @ 7.5' B-14 LEDGE @ 7.0' TP-2 NO H20 REF.@ 3.8' LEDGE @ 2.3' /B-20 /LEDGE @ 9.0' B-9 LEDGE @ 10.0' TP-1 NO H20 REF.@ 4,0' B-8 LEDGE @ 10.3' EX. CHAIN LINK FENCE Bk. 34830 Pg.261 ASSESSORS ID: 637-02225-053 #53 TECHNOLOGY PARK ROAD IRON PIPE FOUND n/f CUBE HHF SAIL ENERGY, LLC Bk. 54391 Pg.253 ASSESSORS ID: 637-02226-059 NORTHEAST MA, LLC
Bk. 56521 Pg.15
ASSESSORS ID: 637-02215-063
#63 TECHNOLOGY PARK ROAD #59 TECHNOLOGY PARK ROAD FOR PERMITTING ONLY:



<u>LEGEN</u>D

IRON PIPE FOUND

SEWER MANHOLE

DRAIN MANHOLE

CATCH BASIN

UTILITY POLE

BENCHMARK GAS VALVE

SPOT LIGHT MAILBOX (MBX) BOLLARD

MONITORING WELL

WATER GATE VALVE WATER SHUT OFF HYDRANT

LIGHT POLE / LAMP POST

OBSERVATION TEST PIT HYDRIC SOIL TEST PIT BORING TEST PIT

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VERTICAL GRANITE CURBING

CAPE COD BERM (BITUMINOUS)

BITUMINOUS CURBING (GENERIC)

CONCRETE CURBING

DECIDUOUS TREE

CONIFEROUS TREE

WETLAND FLAG

BOULDER

STONEWALL

PROPERTY LINE

GRAPHIC SCALE

NOT FOR CONSTRUCTION

CLEANOUT

ELECTRIC MANHOLE

TELEPHONE MANHOLE WATER MANHOLE

UNDETERMINED MANHOLE

DRILL HOLE FOUND

STONE OR CONCRETE MONUMENTS




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NEW ENGLAND COLD STORAGE, LLC.

6 PICKER ROAD STURBRIDGE, MA

EXISTING CONDITIONS


7/17/20 - SITE LAYOUT RE-DESIGN

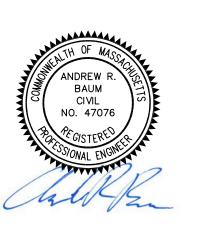6/15/20 - ADD BORINGS IN REPLICATION AREA 6/1/20 - PER CONSERVATION COMMISSION COMMENTS

REVISIONS

SCALE: 1" = 40' MAY 12, 2020 DATE: 20-122 JOB NO:

20-122 DEFINITIVE SITE PLAN PLAN NO: 2 OF 24

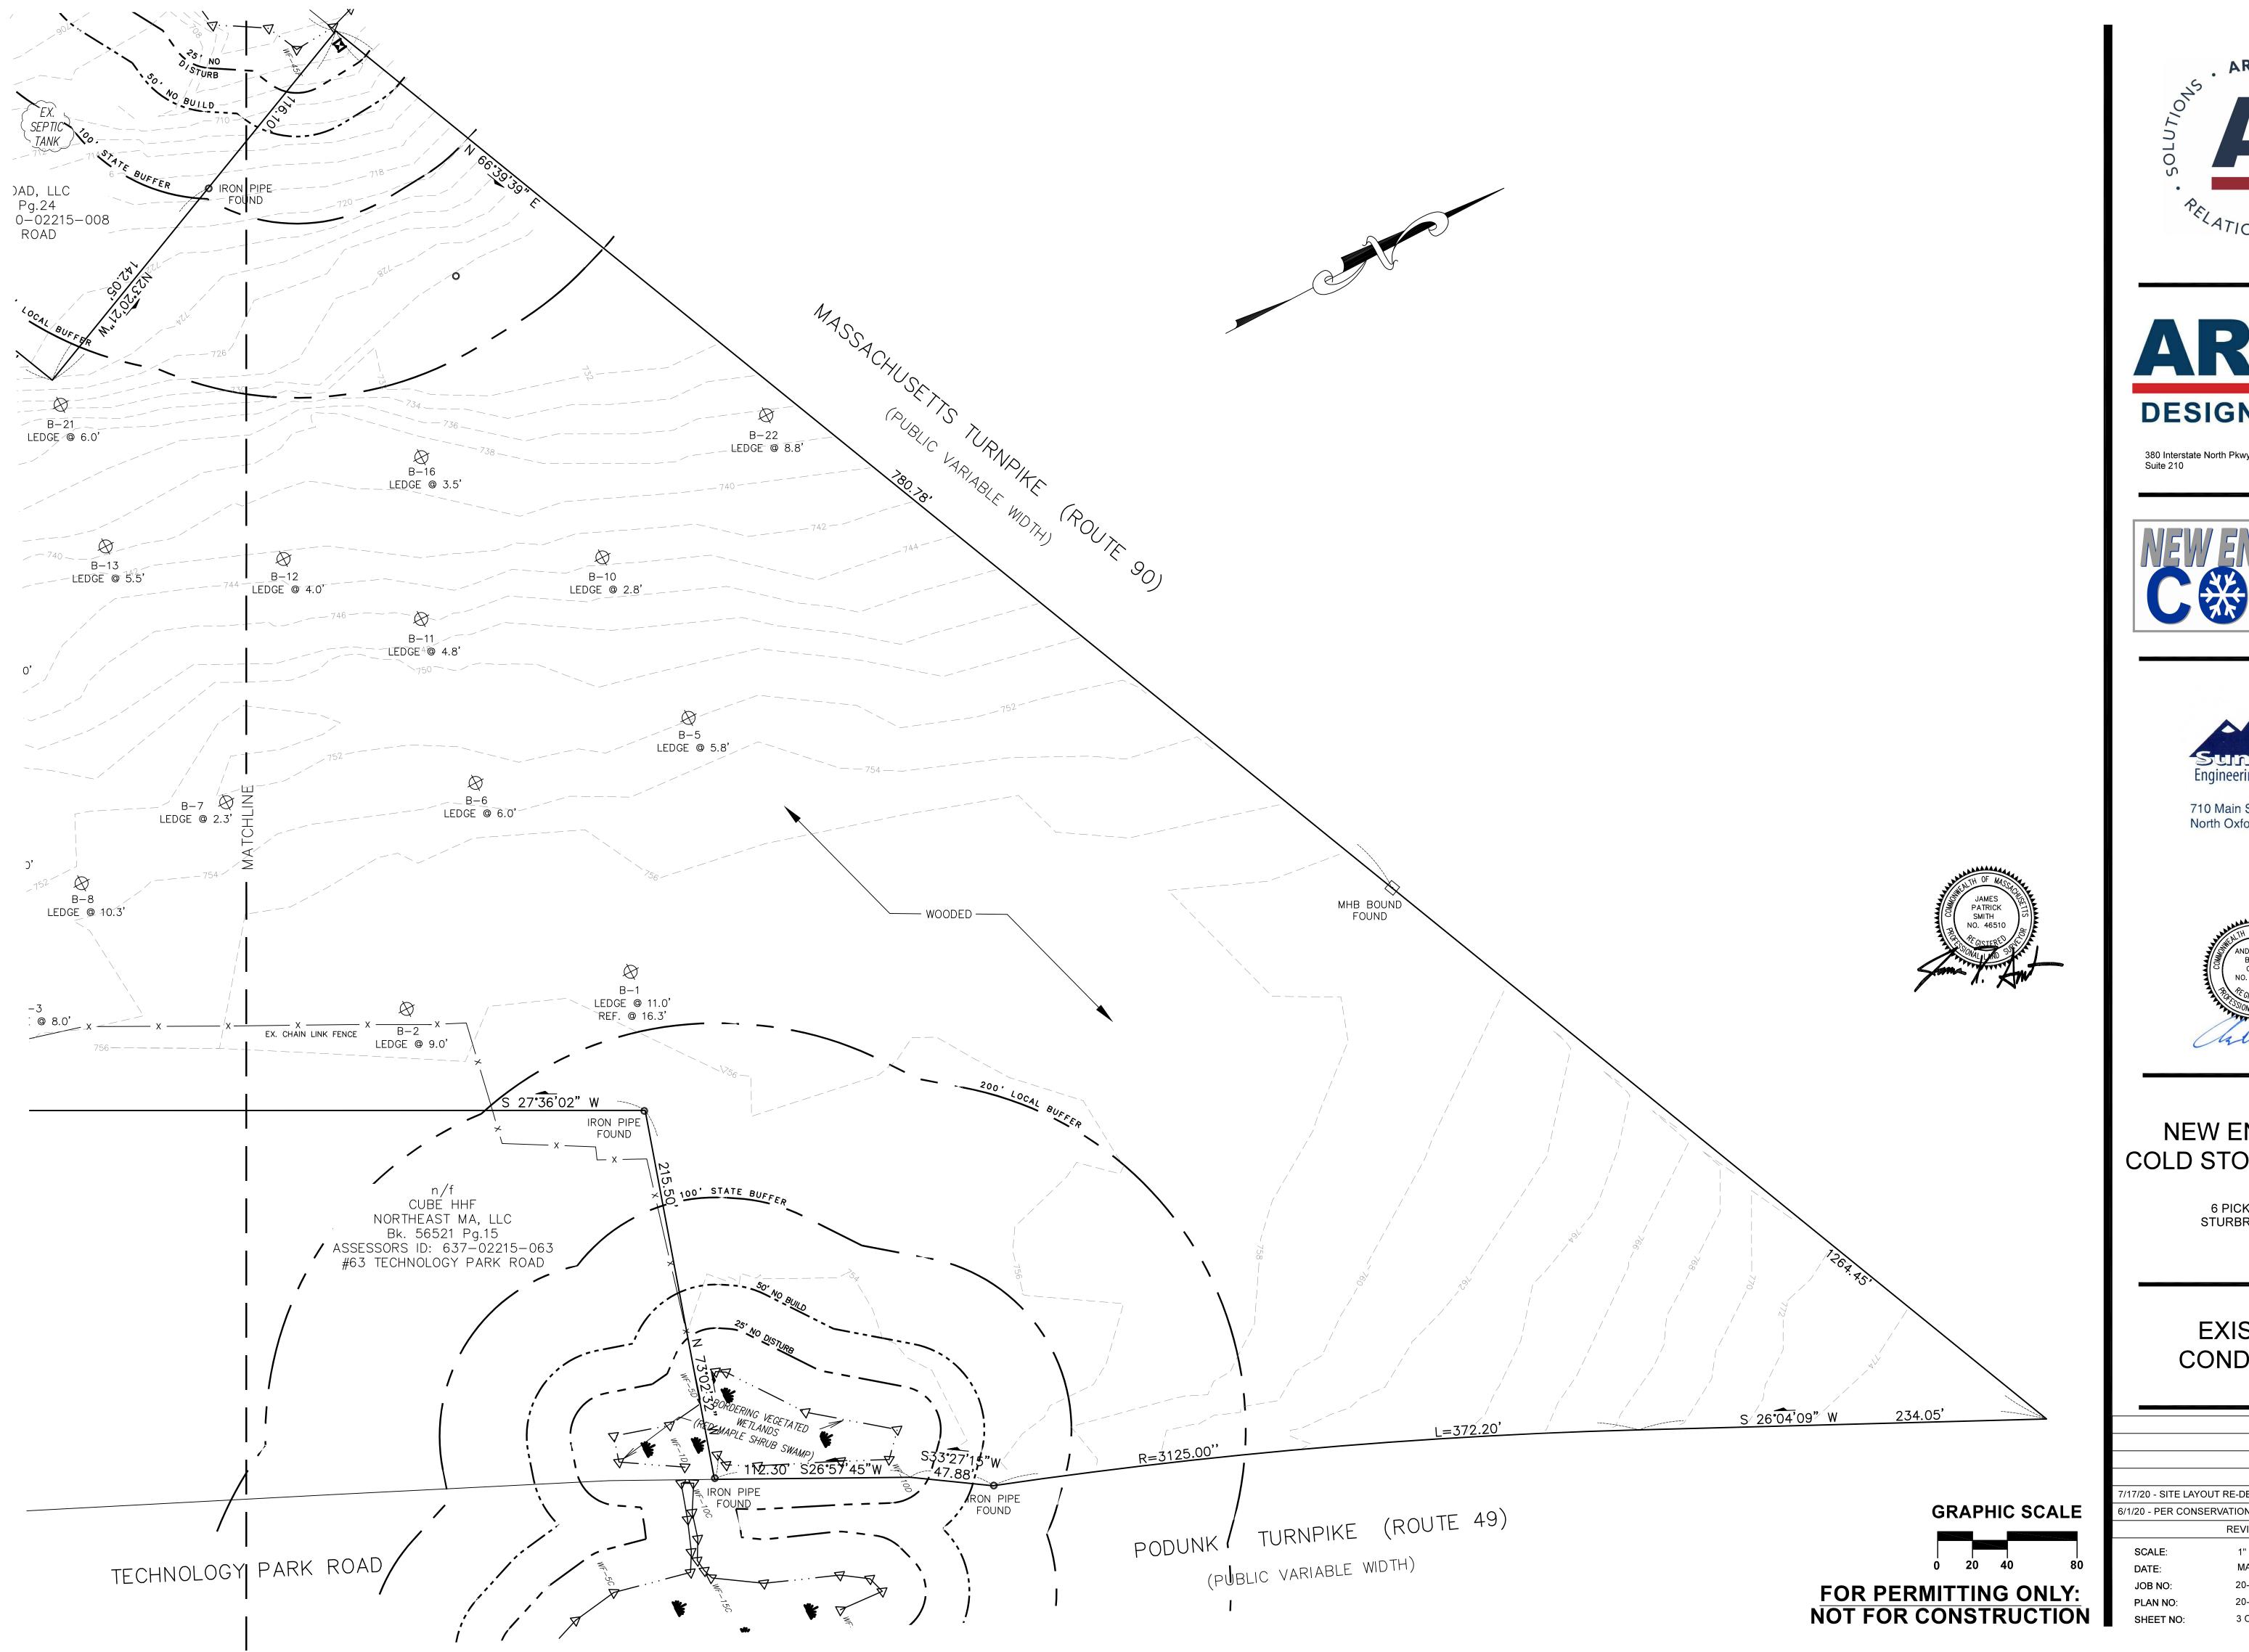









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NEW ENGLAND COLD STORAGE, LLC.

6 PICKER ROAD STURBRIDGE, MA

EXISTING CONDITIONS


7/17/20 - SITE LAYOUT RE-DESIGN
6/1/20 - PER CONSERVATION COMMISSION COMMENTS

REVISIONS 1" = 40' MAY 12, 2020

20-122 20-122 DEFINITIVE SITE PLAN

Construction Sequence Plan FOR 6 Picker Sturbridge Ma


- 1. Erosion and Sedimentation Controls for Permanent and temporary access points and temporary sedimentation basins to be installed prior to any site activities.
- 2. Establish Construction entrance(s) to the site at both locations.
- 3. Establish Lay Down Area beyond 100 foot wetland buffer for storage of materials and equipment.
- 4. Proposed crossing to be cleared and grubbed out. Wetland soil to be removed and stockpiled on site for use in replication area.
- 5. Clear, Grub and install diversion berms and sediment basins to provide surface water controls for subsequent site work.
- 6. Complete Erosion and Sedimentation Controls for remainder of site prior to any clearing activities.
- 7. Install remainder of Temporary Access Road.
- 8. Clear and grub site. Install interim controls as necessary to control surface water.
- 9. Strip & stock pile top soil and store on site.
- 10. Initiate Site earthwork. Adjustments to interim erosion controls to be performed as necessary for progress of site work.
- 11. Complete permanent crossing.
- 12. Remove temporary crossing and restore area with loam & seed. Provide additional plantings per the plan.
- 13. All completed surfaces or interim surfaces not be worked for 30 or more days shall be stabilized in accordance with the E&S plan.
- 14. Replication area to be constructed per permit requirements. Area to be protected from other site related activities.
- 15. Install drainage system for site.
- 16. Complete shaping and stabilization of drainage basins upon stabilization of the site (loaming, seeding, binder course paving, etc)
- 17. Removed perimeter erosion controls upon final stabilization of site and inspection by jurisdictional authorities.

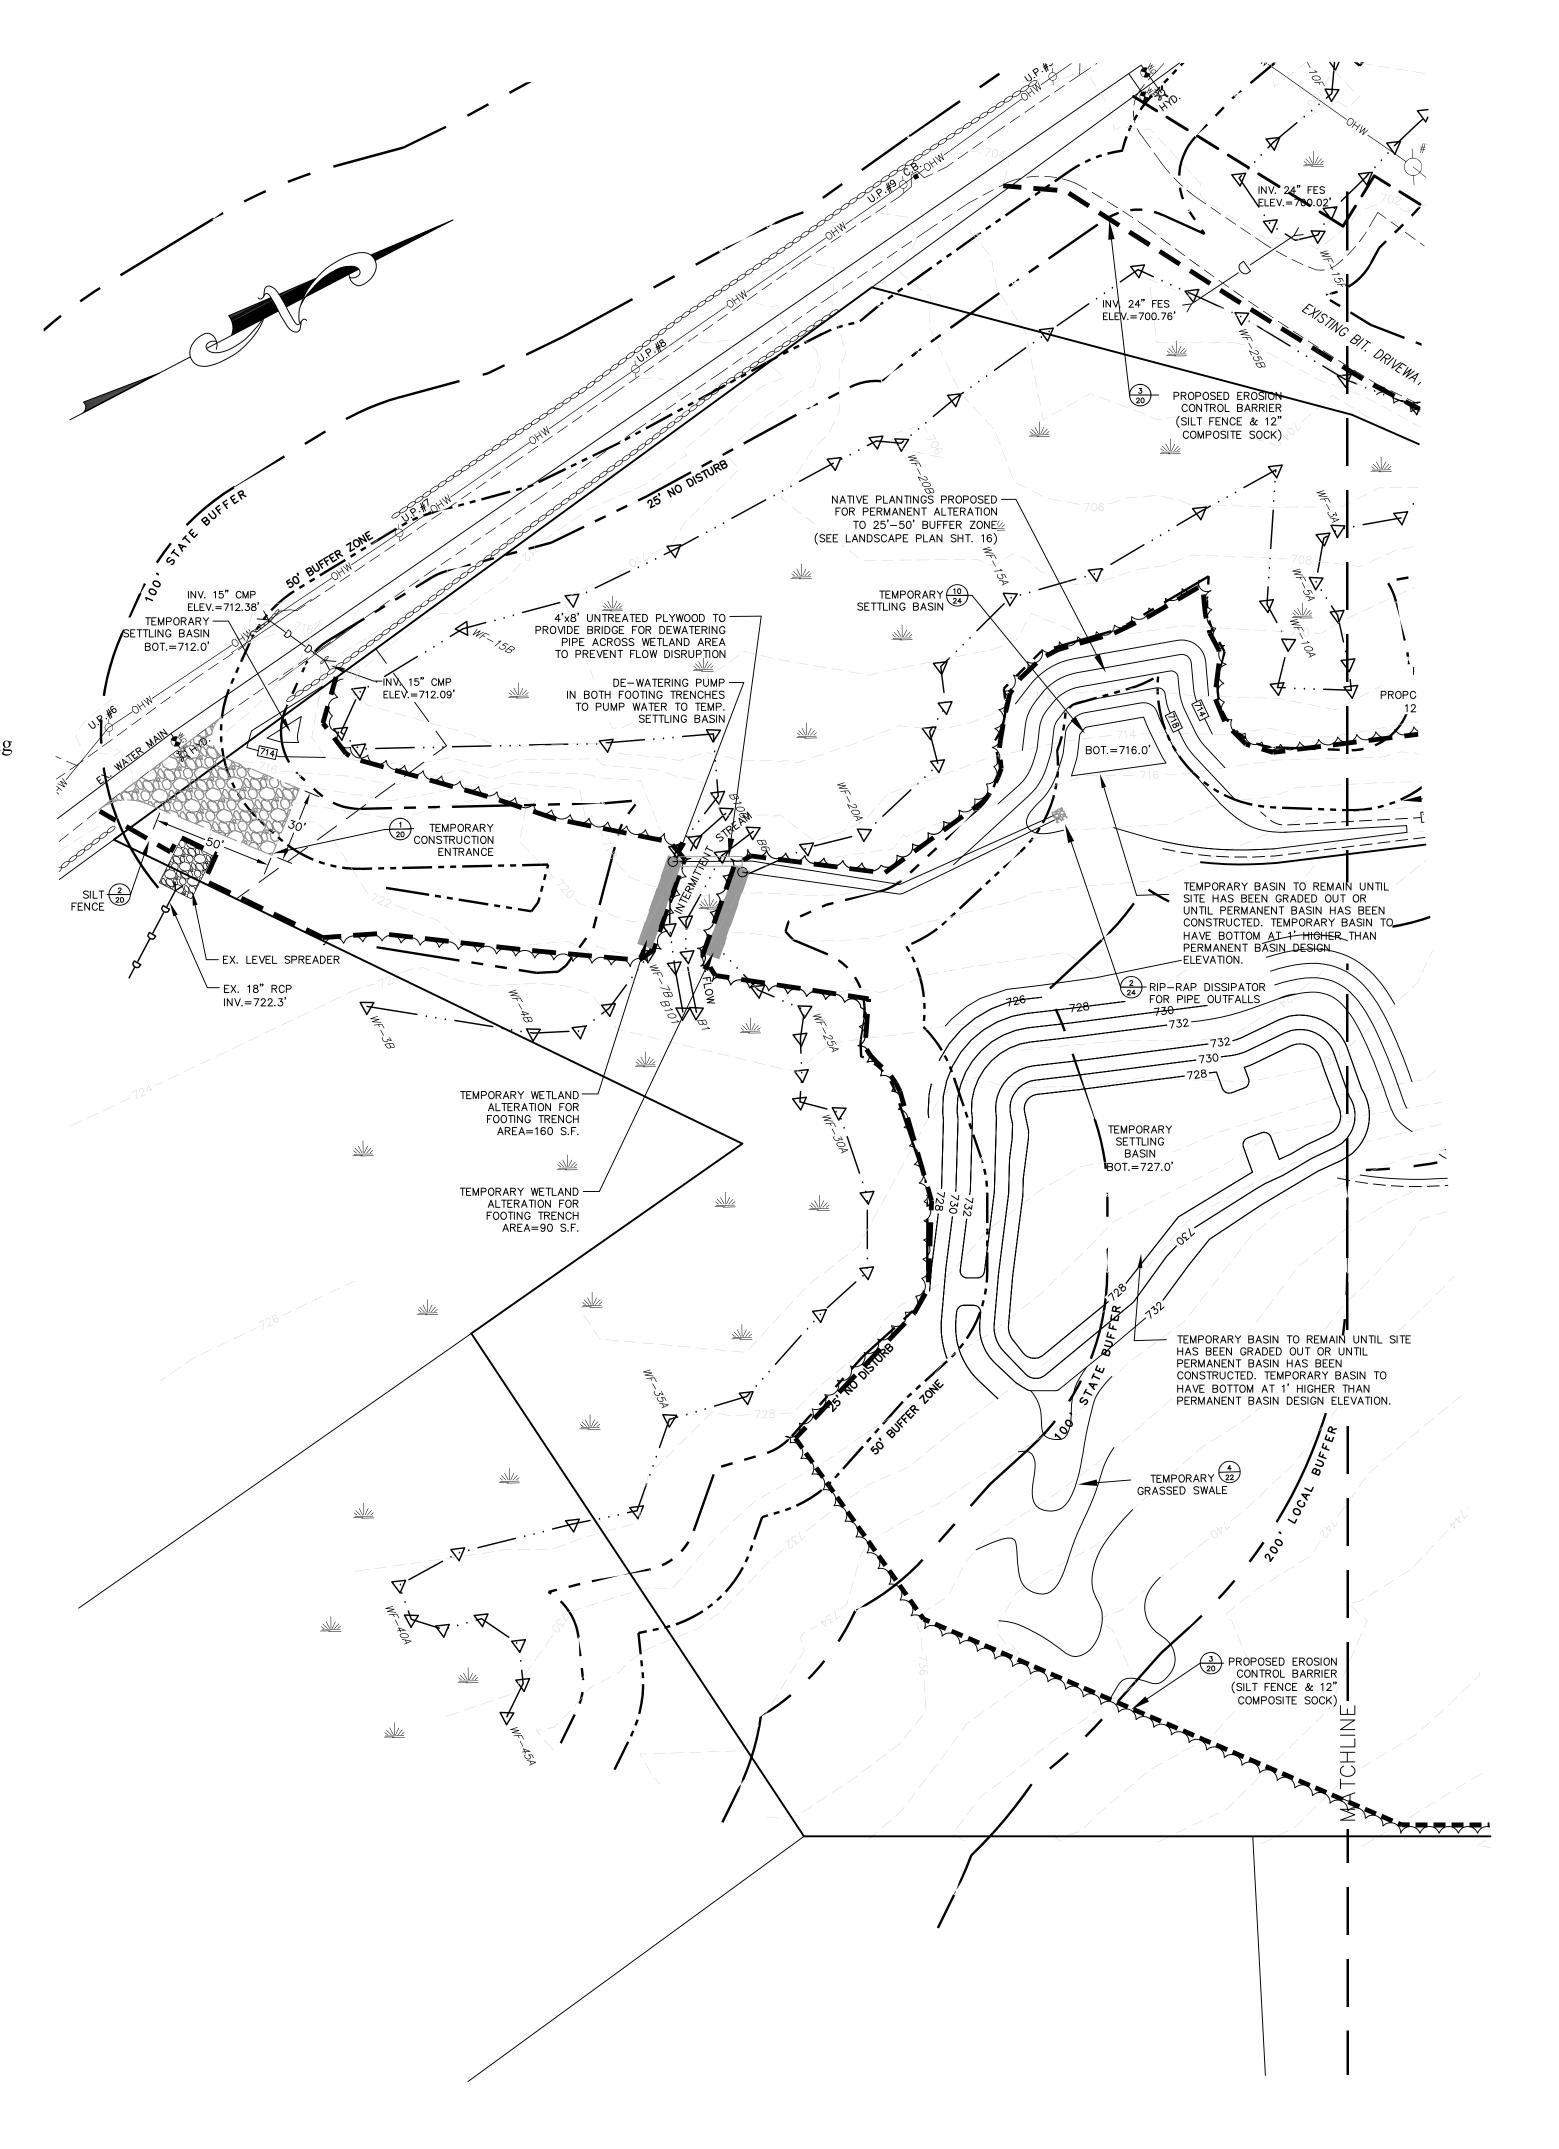



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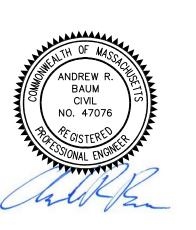


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NEW ENGLAND COLD STORAGE, LLC.
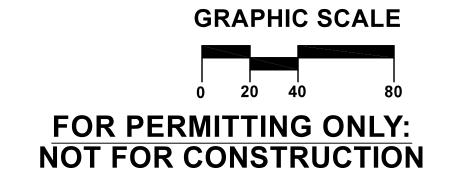
> 6 PICKER ROAD STURBRIDGE, MA

EROSION & SEDIMENTATION CONTROL

7/17/20 - SITE LAYOUT RE-DESIGN

PLAN NO:

6/1/20 - PER CONSERVATION COMMISSION COMMENTS


REVISIONS

SCALE: 1" = 40'

DATE: MAY 12, 2020

JOB NO: 20-122

20-122 DEFINITIVE SITE PLAN
4 OF 24

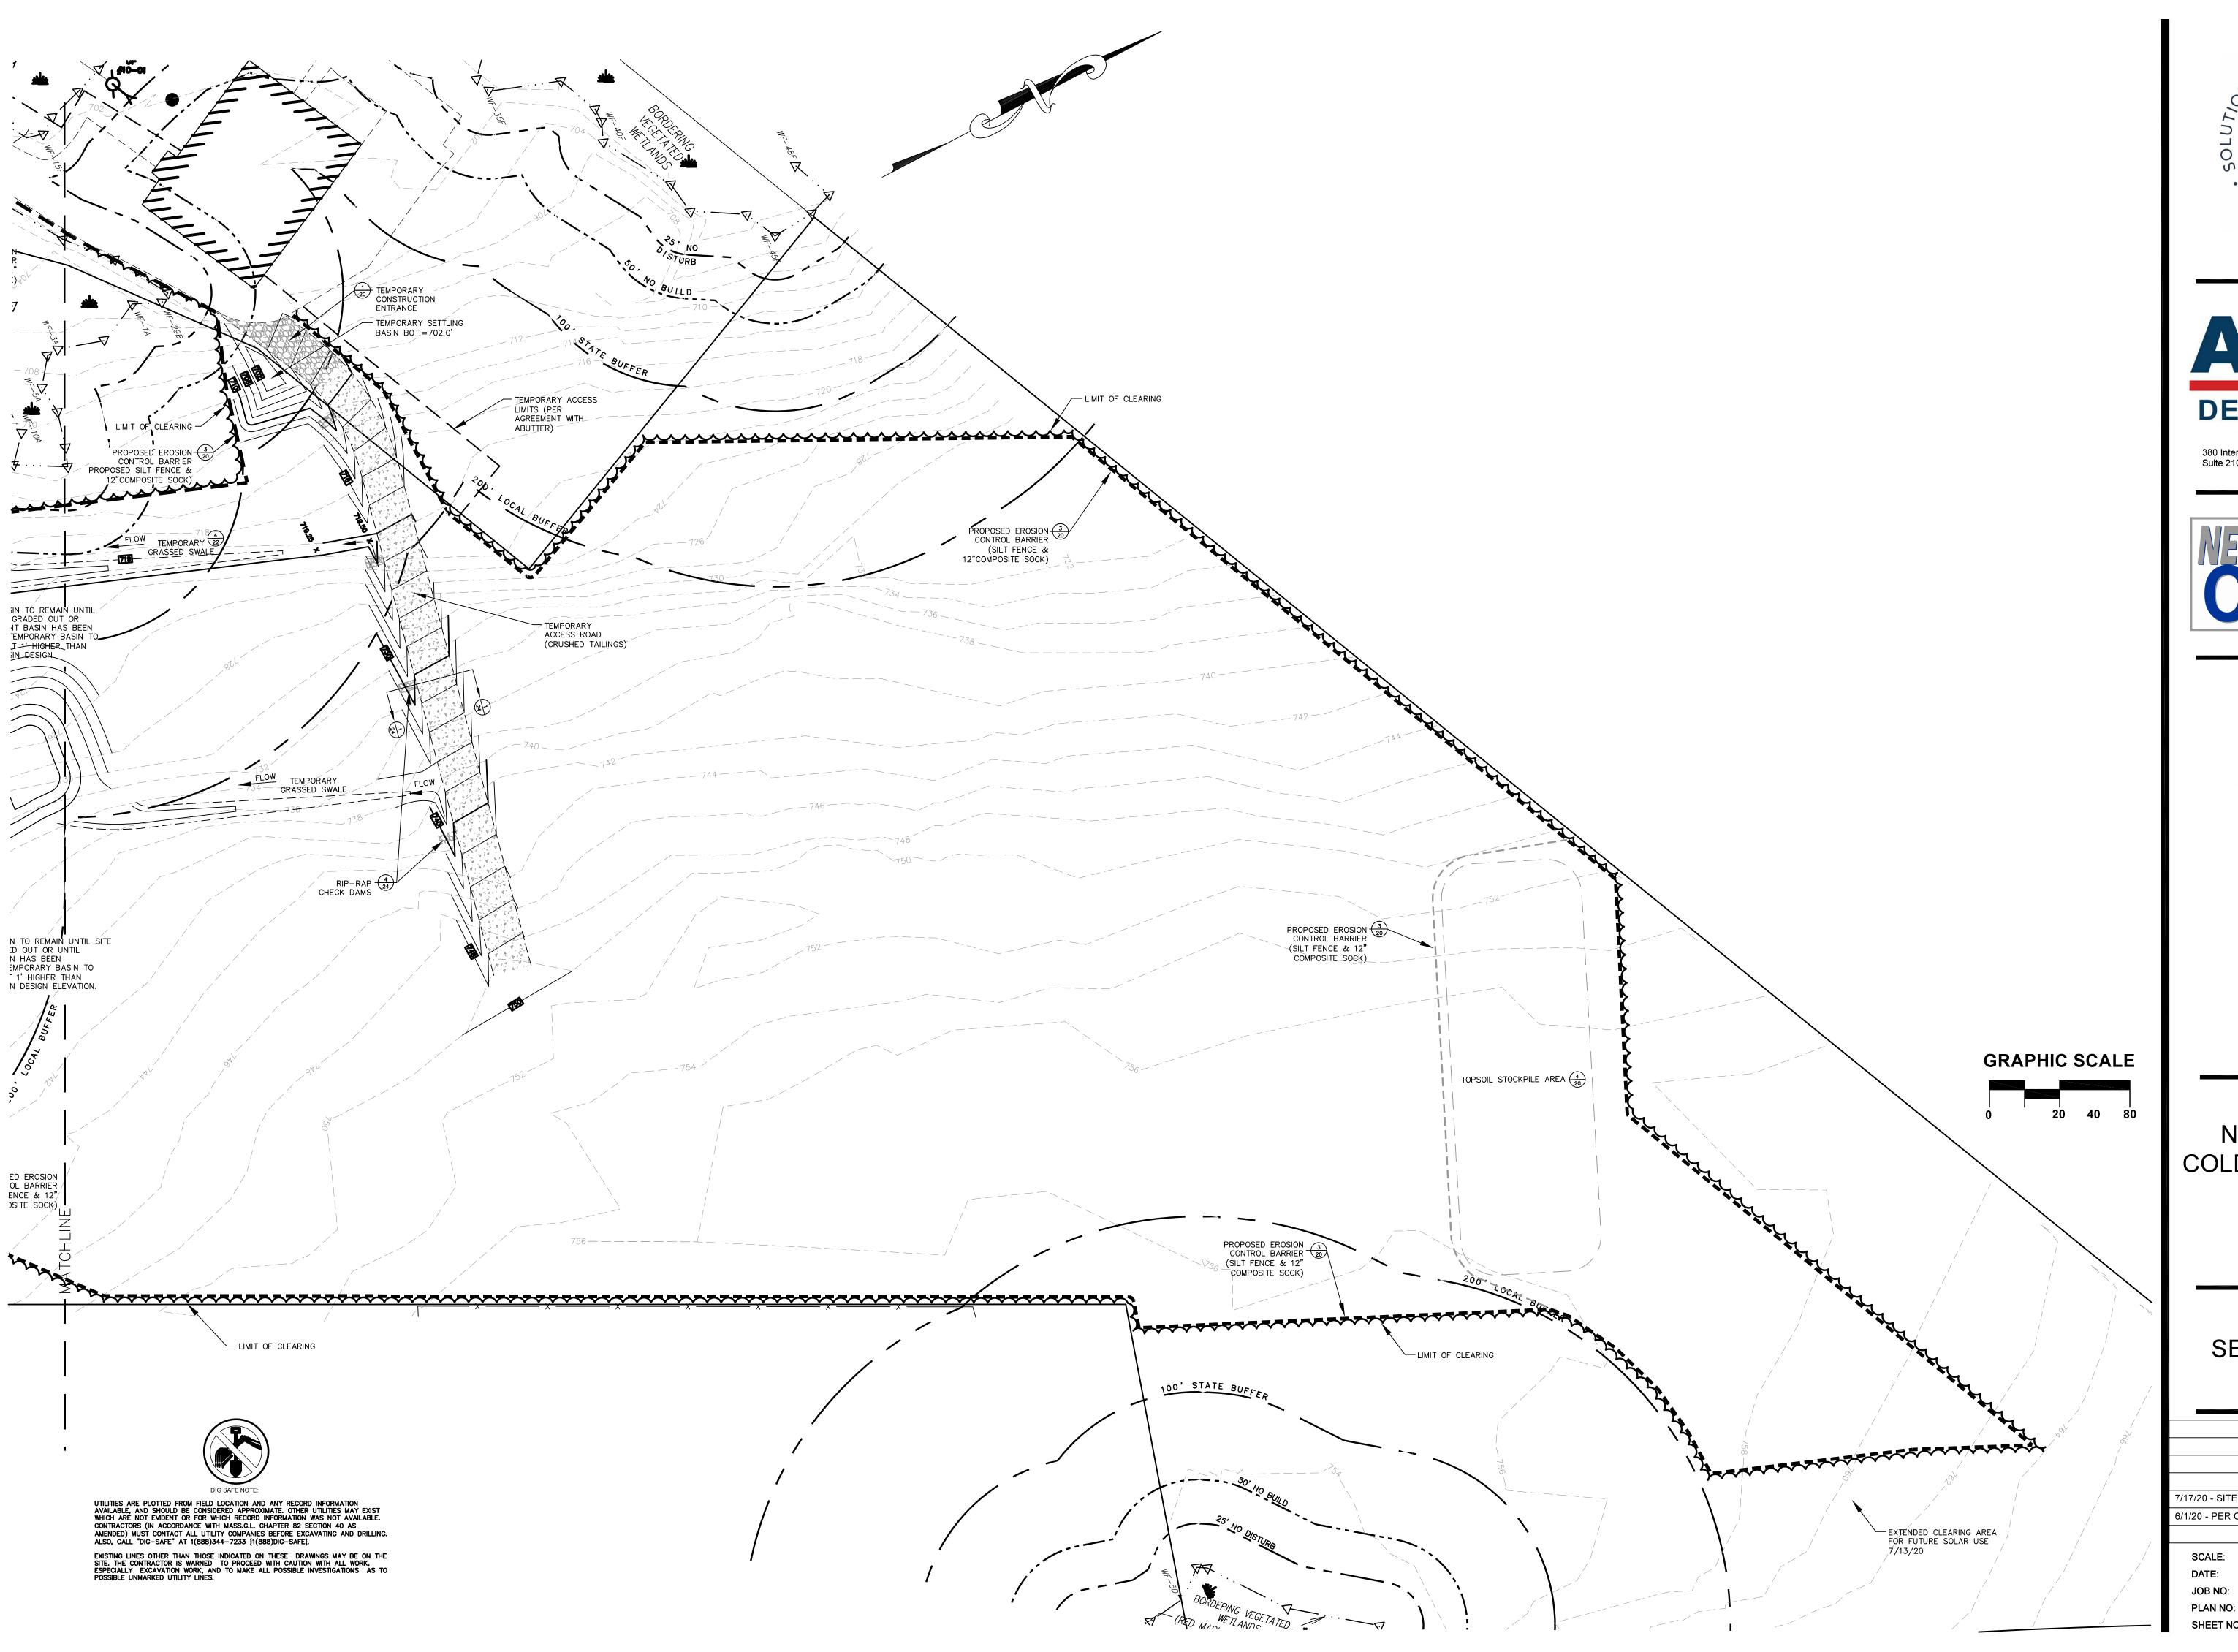









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NEW ENGLAND COLD STORAGE, LLC.

> 6 PICKER ROAD STURBRIDGE, MA

EROSION & SEDIMENTATION CONTROL

7/17/20 - SITE LAYOUT RE-DESIGN 6/1/20 - PER CONSERVATION COMMISSION COMMENTS

REVISIONS

: 1" = 40'
MAY 12, 2020
D: 20-122

20-122 20-122 DEFINITIVE SITE PLAN 5 OF 24












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NEW ENGLAND COLD STORAGE, LLC.
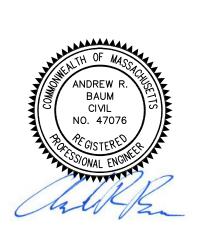
> 6 PICKER ROAD STURBRIDGE, MA

DEMO PLAN

GRAPHIC SCALE


FOR PERMITTING ONLY: NOT FOR CONSTRUCTION


7/17/20 - SITE LAYOUT RE-DESIGN
6/1/20 - PER CONSERVATION COMMISSION COMMENTS

REVISIONS

SCALE: 11 M
DATE: M
JOB NO: 20
PLAN NO: 20

MAY 12, 2020 20-122 20-122 DEFINITIVE SITE PLAN

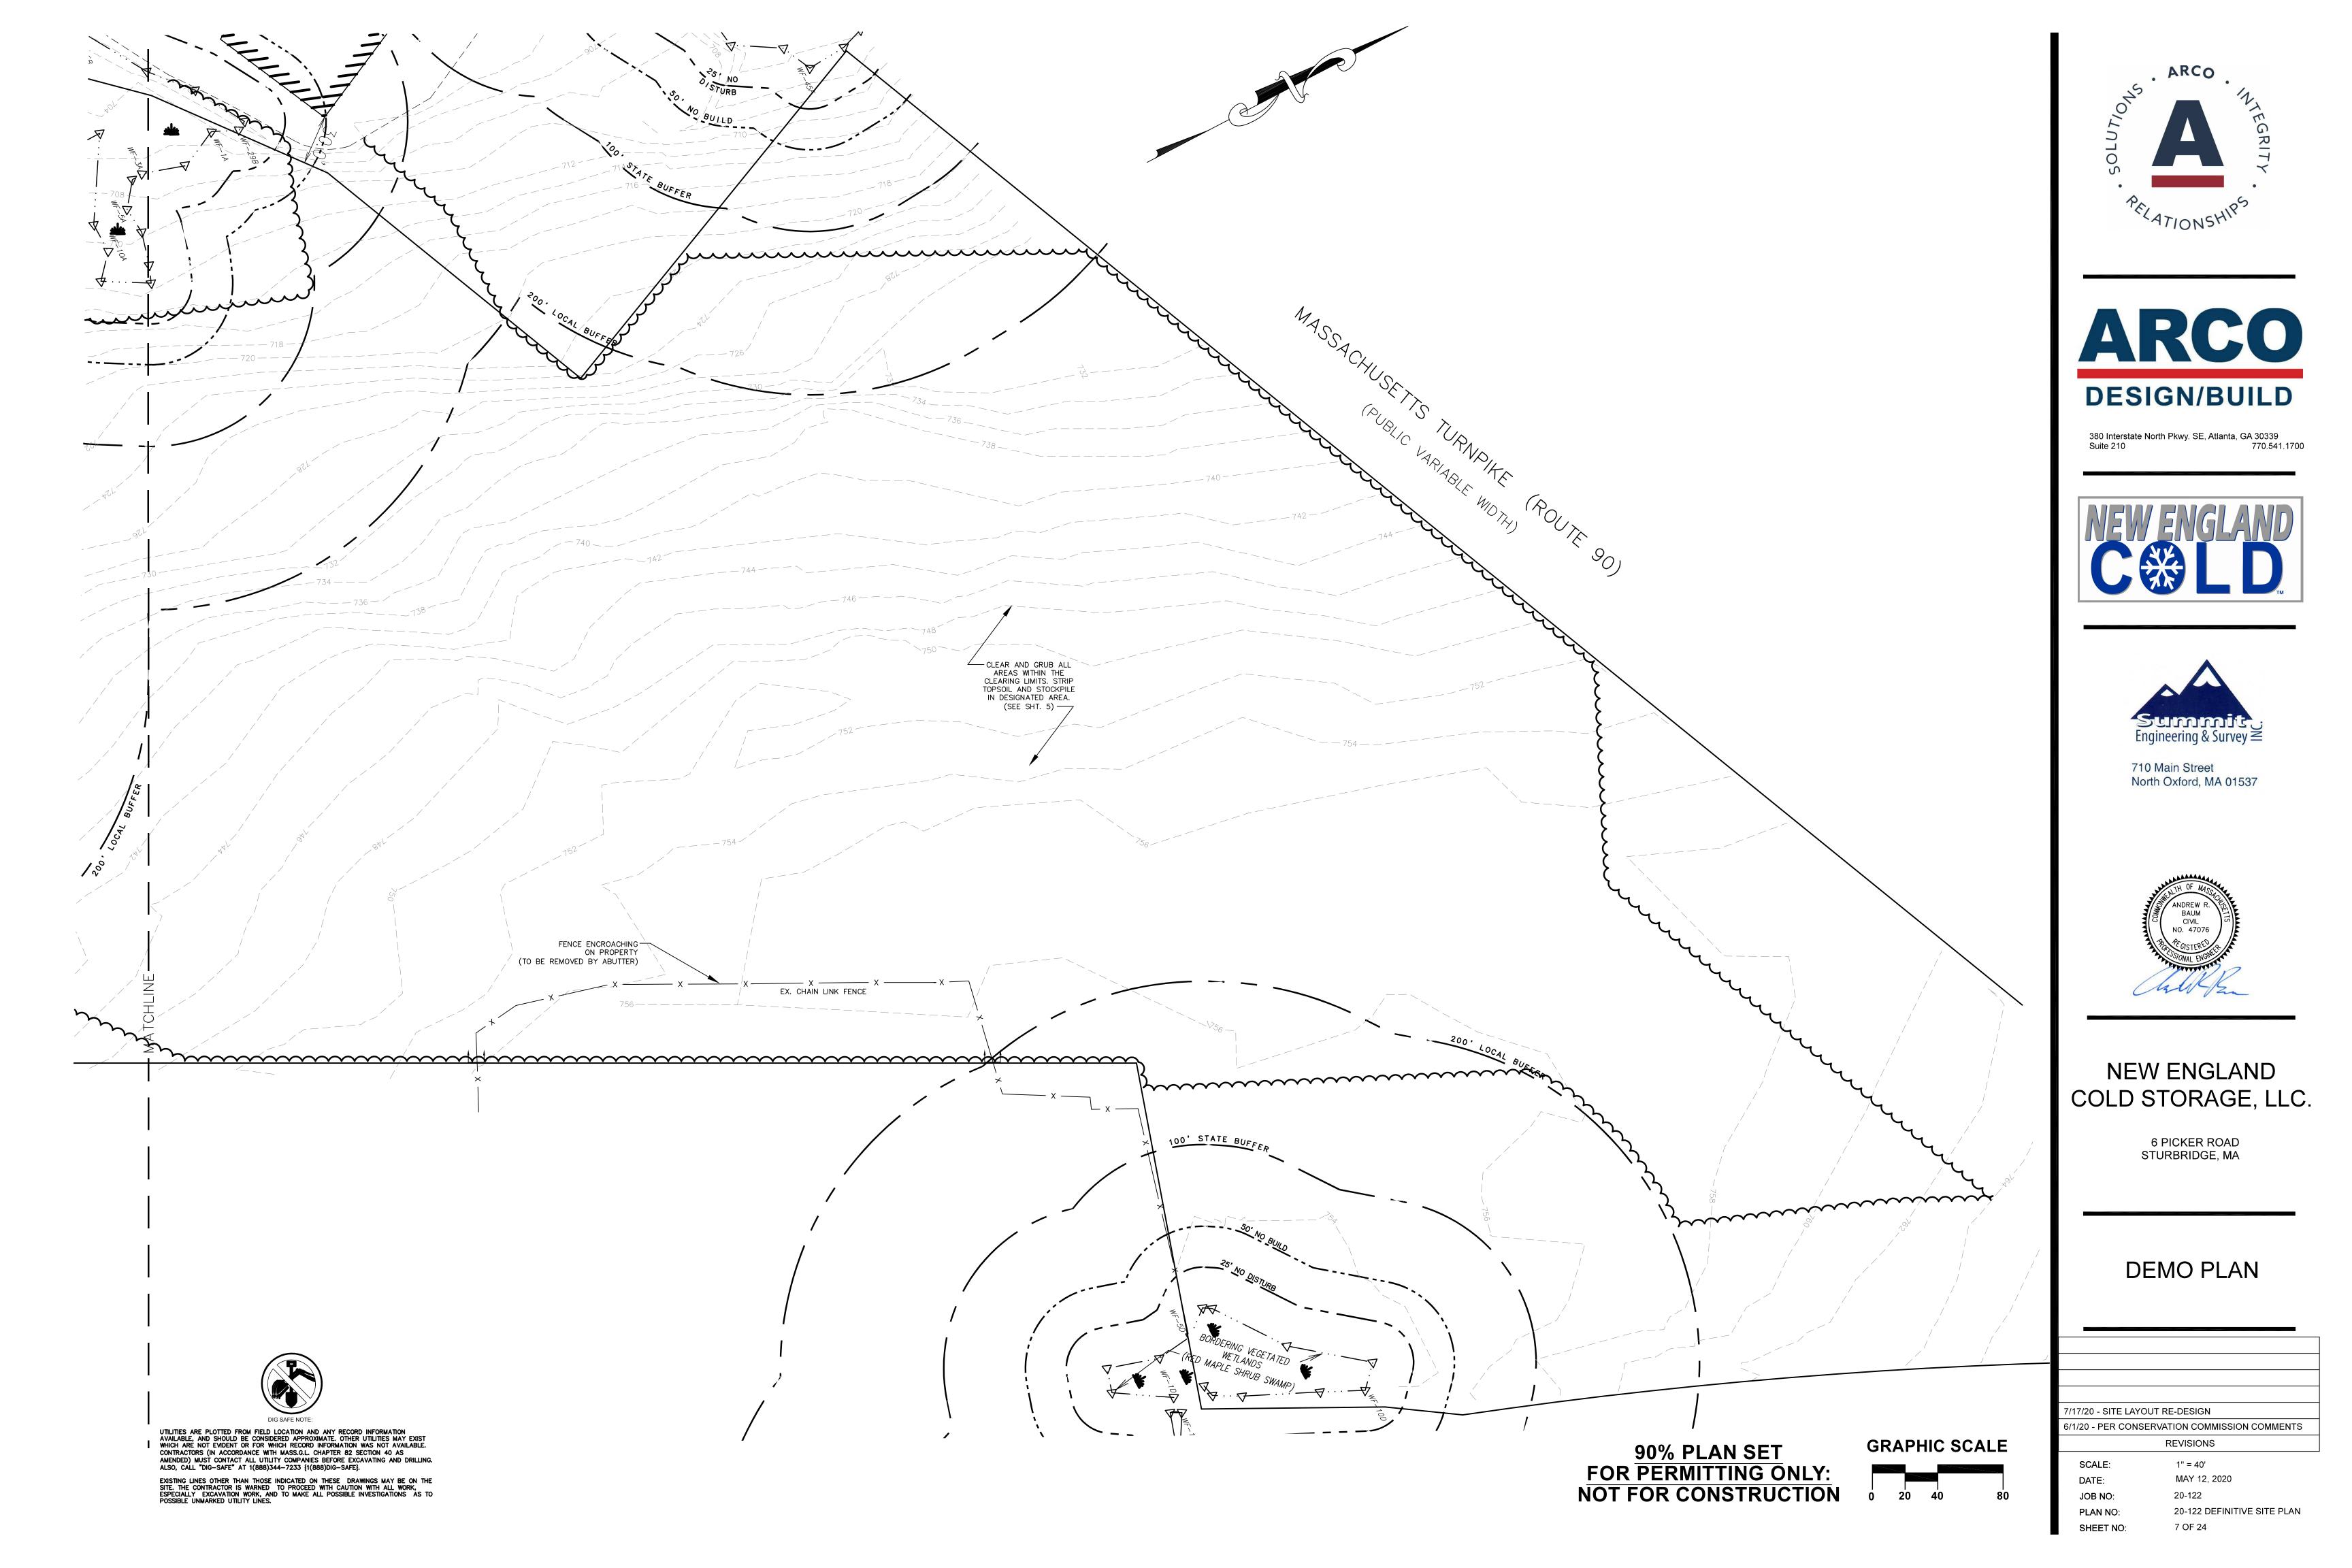

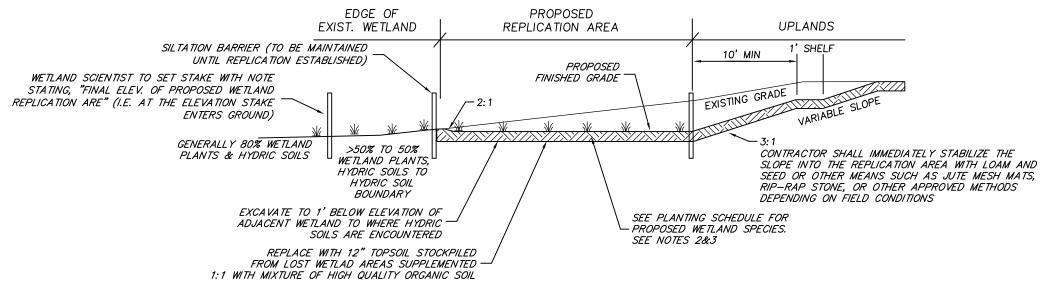

NOTES:

- 1. WETLAND REPLICATION DETAIL BY EBT ENVIRONMENTAL CONSULTANTS, INC.
 2. PLANTING SCHEDLUE TO BE 13 ED MAPLE (ACER RUBRUM, FACW), 14 COMMON WINTERBERRY (VACCINUM CORYMBOSUM, FACW), 13 NORTHERN ARROWWOOD (VIBURNUM RECOGNTIUM, FACW), 14 NORTHERN SPICEBUSH (LINDERA BENZOIN, FACW) AT 6 FOOT SPACING (TOTAL OF 67 WOODY PLANTS) 14 CINNAMON FERN (OSMUNDA CINNAMONIA, FACW) WILL BE PLACED
- 3. WETLAND SPECIALIST TO SET MULTIPLE STAKES WITH NOTES STATING "FINAL ELEVEATION OF PROPOSED WETLAND
- REPLICATION AREA AT THE ELEVATIONS THE STAKES ENTER THE GROUND"

 4. ALL PLANTS TO BE PURCHASED FROM NEW ENGLKAND WETLAND PLANTS AT THE LARGEST SIZE THEY HAVE AVALIABLE.


1 WETLAND REPLICATION AREA CROSS SECTION NOT TO SCALE





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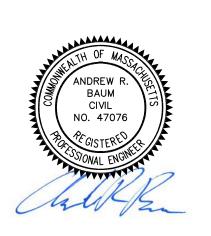


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NEW ENGLAND COLD STORAGE, LLC.
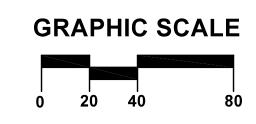
> 6 PICKER ROAD STURBRIDGE, MA

GRADING

7/17/20 - SITE LAYOUT RE-DESIGN 6/15/20 - REPLICATION AREA ADDED

6/15/20 - REPLICATION AREA ADDED 6/1/20 - PER CONSERVATION COMMISSION COMMENTS


REVISIONS

SCALE: 1" = 40'

DATE: MAY 12, 2020

JOB NO: 20-122

JOB NO: 20-122
PLAN NO: 20-122 DEFINITIVE SITE PLAN
SHEET NO: 8 OF 24

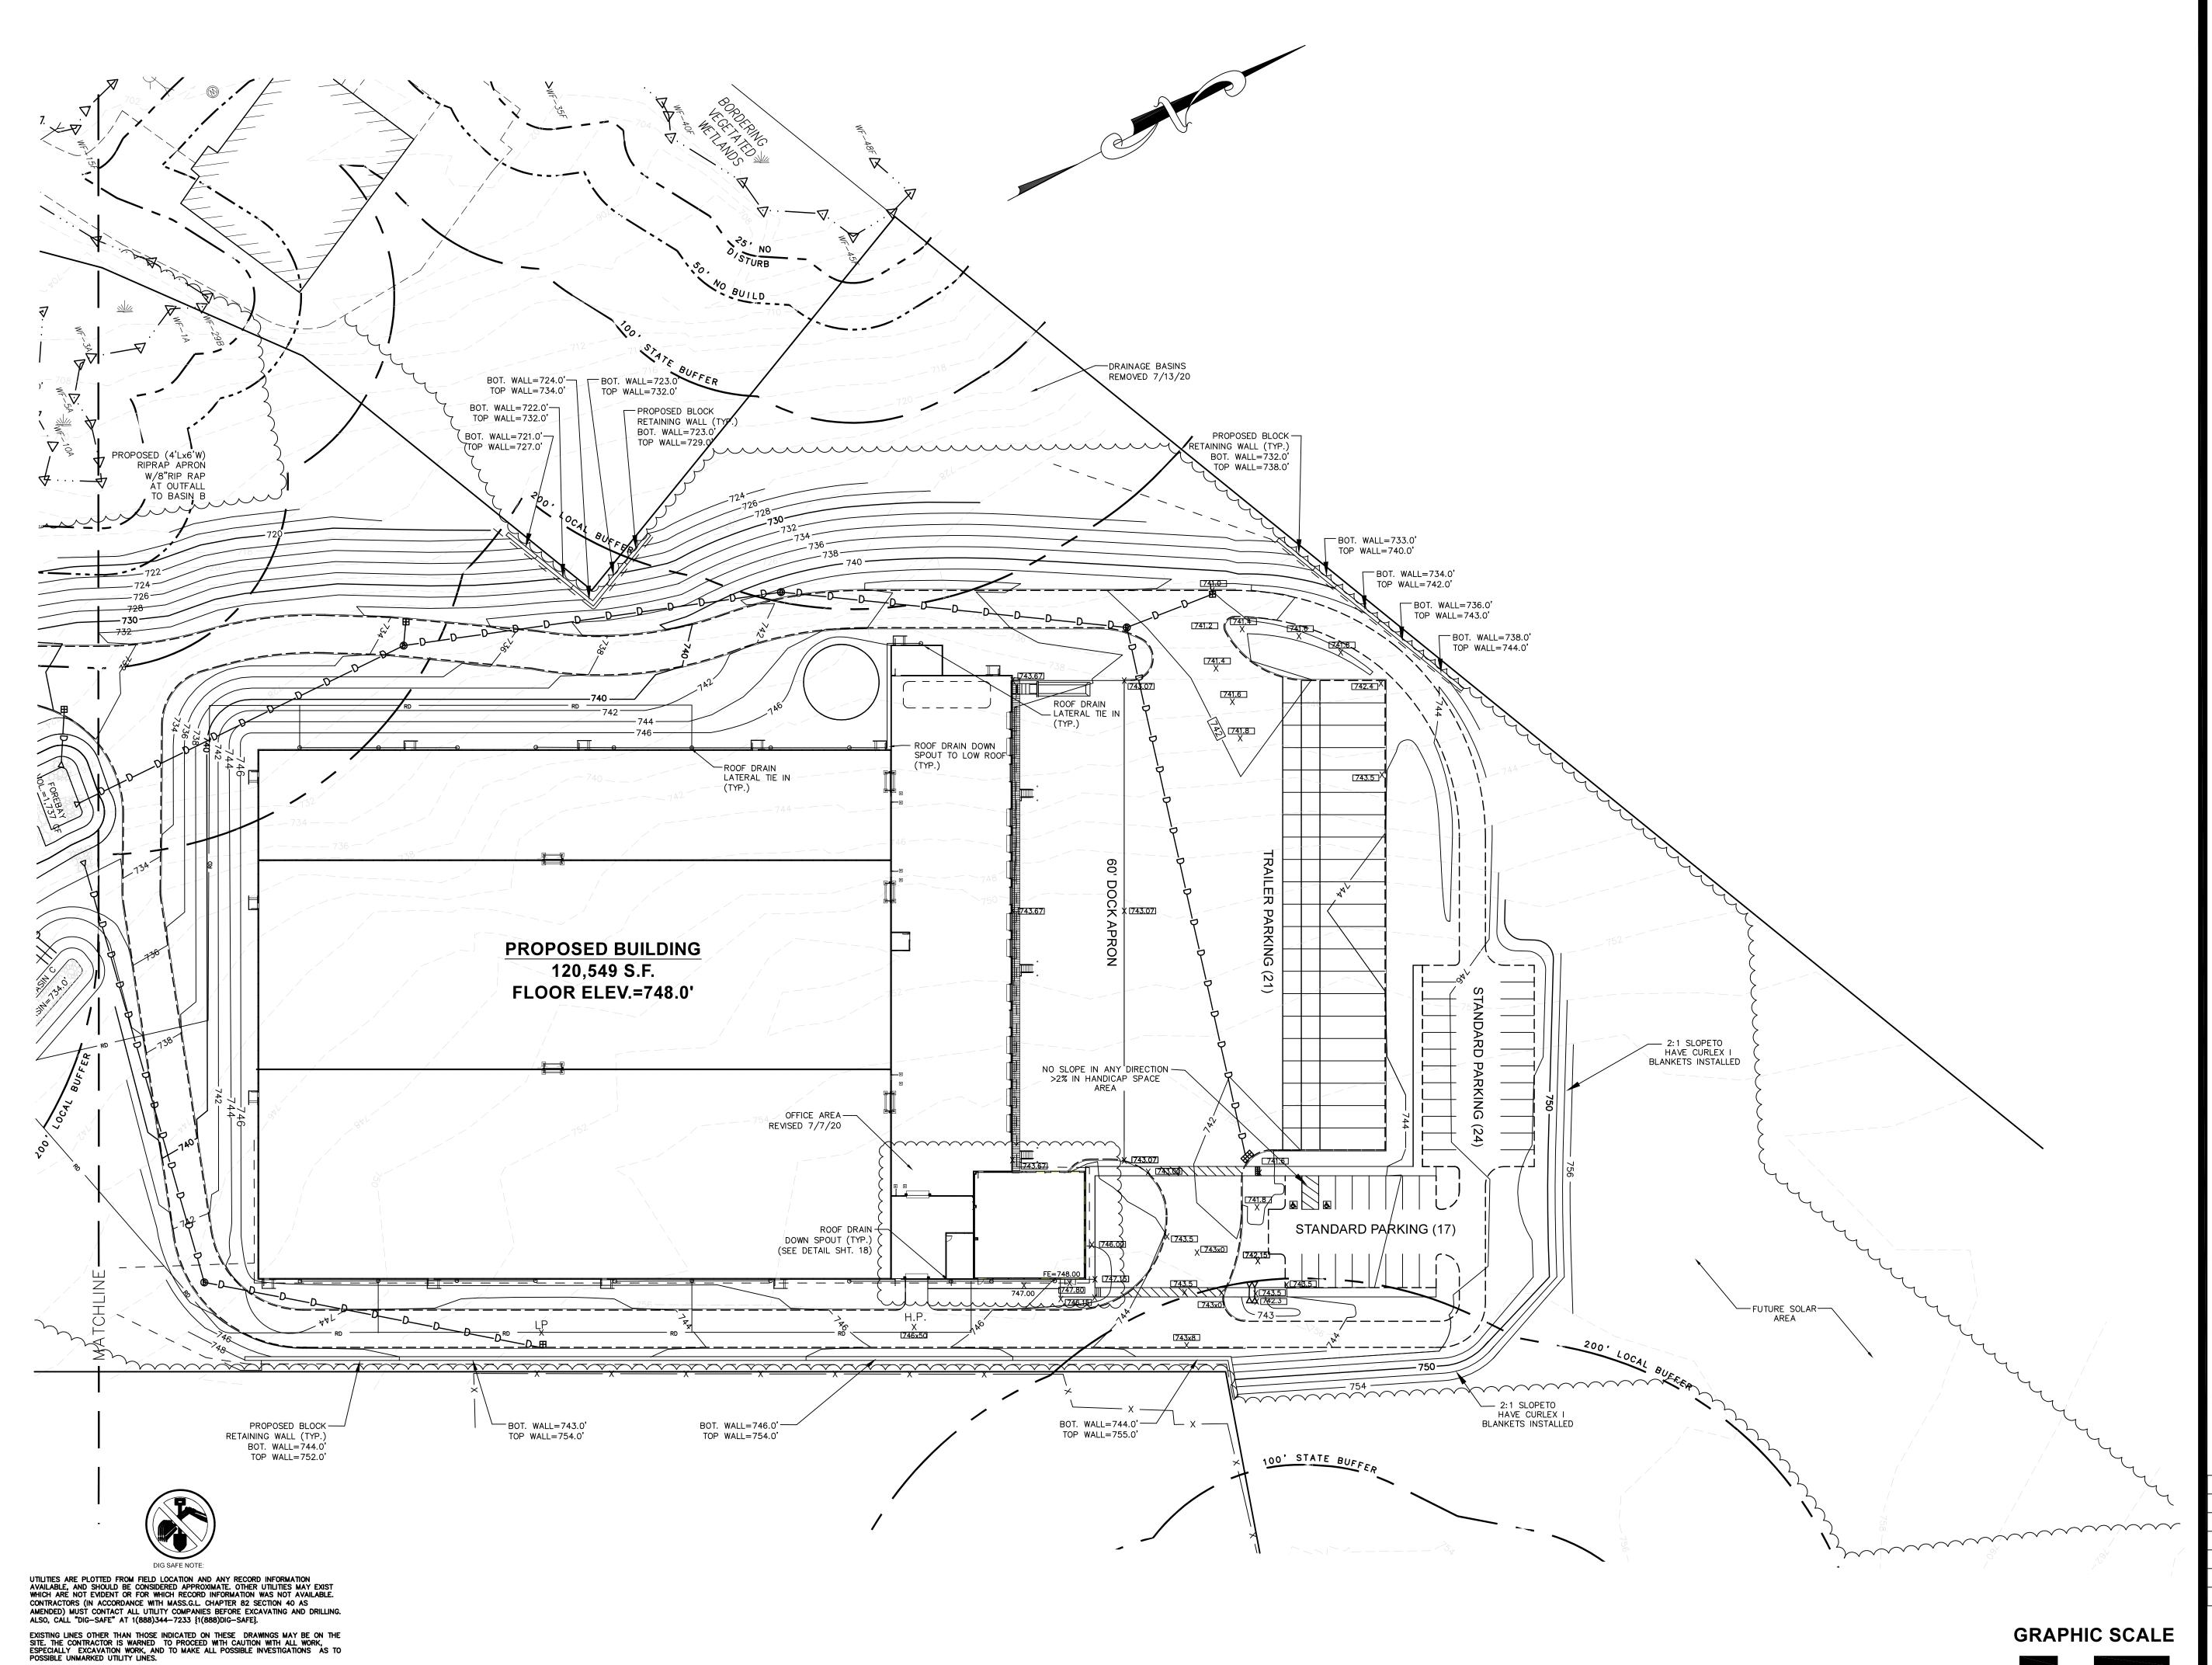




ARCO **DESIGN/BUILD**

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NEW ENGLAND COLD STORAGE, LLC.

6 PICKER ROAD STURBRIDGE, MA

GRADING

7/17/20 - SITE LAYOUT RE-DESIGN

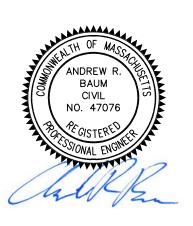DATE:

PLAN NO:

6/1/20 - PER CONSERVATION COMMISSION COMMENTS

REVISIONS


1" = 40' JOB NO:

MAY 12, 2020 20-122 20-122 DEFINITIVE SITE PLAN

STRU	CTURE SCHEDU	LE OF ELEVATIO	NS	
STRUCTURE	RIM	INVERT	PIPE DIA. (INCHES)	NOTES
	САТСНВ	ASINS		
DBL CTB A, TRUCK COURT	741.50	738.50	24	DOUBLE CATCH BASIN
CTB B, STA 11+30, 5.5' LT.	741.75	737.75	24	
CTB C, STA 6+83, 8' LT	734.25	730.75	12	
CTB D, STA 5+22 PERIMETER ROAD	743.00	739.00	15	
CTB E, STA 5+08, 18' RT	730.50	727.00	12	
CTB F, STA 3+29, 15' RT	723.50	720.50	12	
CTB G, STA 3+29, 15' LT	723.50	720.50	12	
CTB H, STA 0+42, 15' RT	717.50	714.50	12	
CTB I, STA 0+62, 15' LT	718.00	714.00	12	
	SEWER MA	NHOLES		
SMH 1, STA 9+80	742.50	733.10	6	FROM BLDG
	-	733.00	6	TO SMH 2
SMH 2, STA 7+20	737.50	728.85	6	FROM SMH 1
	-	728.75	6	TO EONE PUMP
EONE PUMP, STA 4+70	728.55	724.25	6	FROM SMH 2
	-	725.00	4	FORCEMAIN OUT
	DRAIN MA	NHOLES		
DMH-A STA, 10+84, 10' RT	741.75	735.60	24	FROM DBL CTB A.
	-	737.25	24	FROM DBL CTB B
	-	735.50	24	TO DMH STA
	1			
DMH B, STA 8+92, 13' LT	742.00	733.64	24	FROM DMH A
	-	733.54	24	ТО DMH C
	T	T	1	
DMH C, STA 6+82, 4' RT	734.25	730.00	12	FROM CTB C
	-	728.60	24	FROM DMH B
	-	728.50	24	TO BASIN A OUTFALL
DMH D, STA 3+36 PERIMETER ROAD	741.75	736.22	15	FROM CTB B
DIVITIO, STA 3+30 FERRIVIETER ROAD	741.73	736.12	15	TO BASIN A
	_	750.12	13	I O DASIN A
SDMH-1, STORMCEPTOR 450I, STA 3+50	724.00	720.00	12	FROM CTB F
•	-	720.00	12	FROM CTB G
	-	719.90	12	TO BASIN B OUTFALL
SDMH-2, STORMCEPTOR 4501, STA 0+57, 25' LT	717.75	713.88	12	FROM CTB H
	-	713.88	12	FROM CTB I
	-	713.78	12	TO PICKER ROAD OUTFALL

OUTI	ET CONTROL ST	RUCTURE SCHEDU	LE OF ELEVATIONS
DESCRIPTION	INVERT	DIAMETER (IN)	NOTES
		BASIN A	
INVERT OUT	725.00	18	HDPE DISCHARGE
	726.50	6	1 - VERTICAL ORIFACE
	729.00	10	1 - VERTICAL ORIFACE
	730.30	6	1-VERTICAL ORIFACE
	731.00	10	1-VERTICAL ORIFACE
	731.50	24	TOP STRUCTURE GRATE


	BASIN B				
INVERT OUT	718.00	12	HDPE DISCHARGE		
	718.50	3	1 - VERTICAL ORIFACE		
	719.00	4	2 - VERTICAL ORIFACE		
	719.50	24	TOP STRUCTURE GRATE		

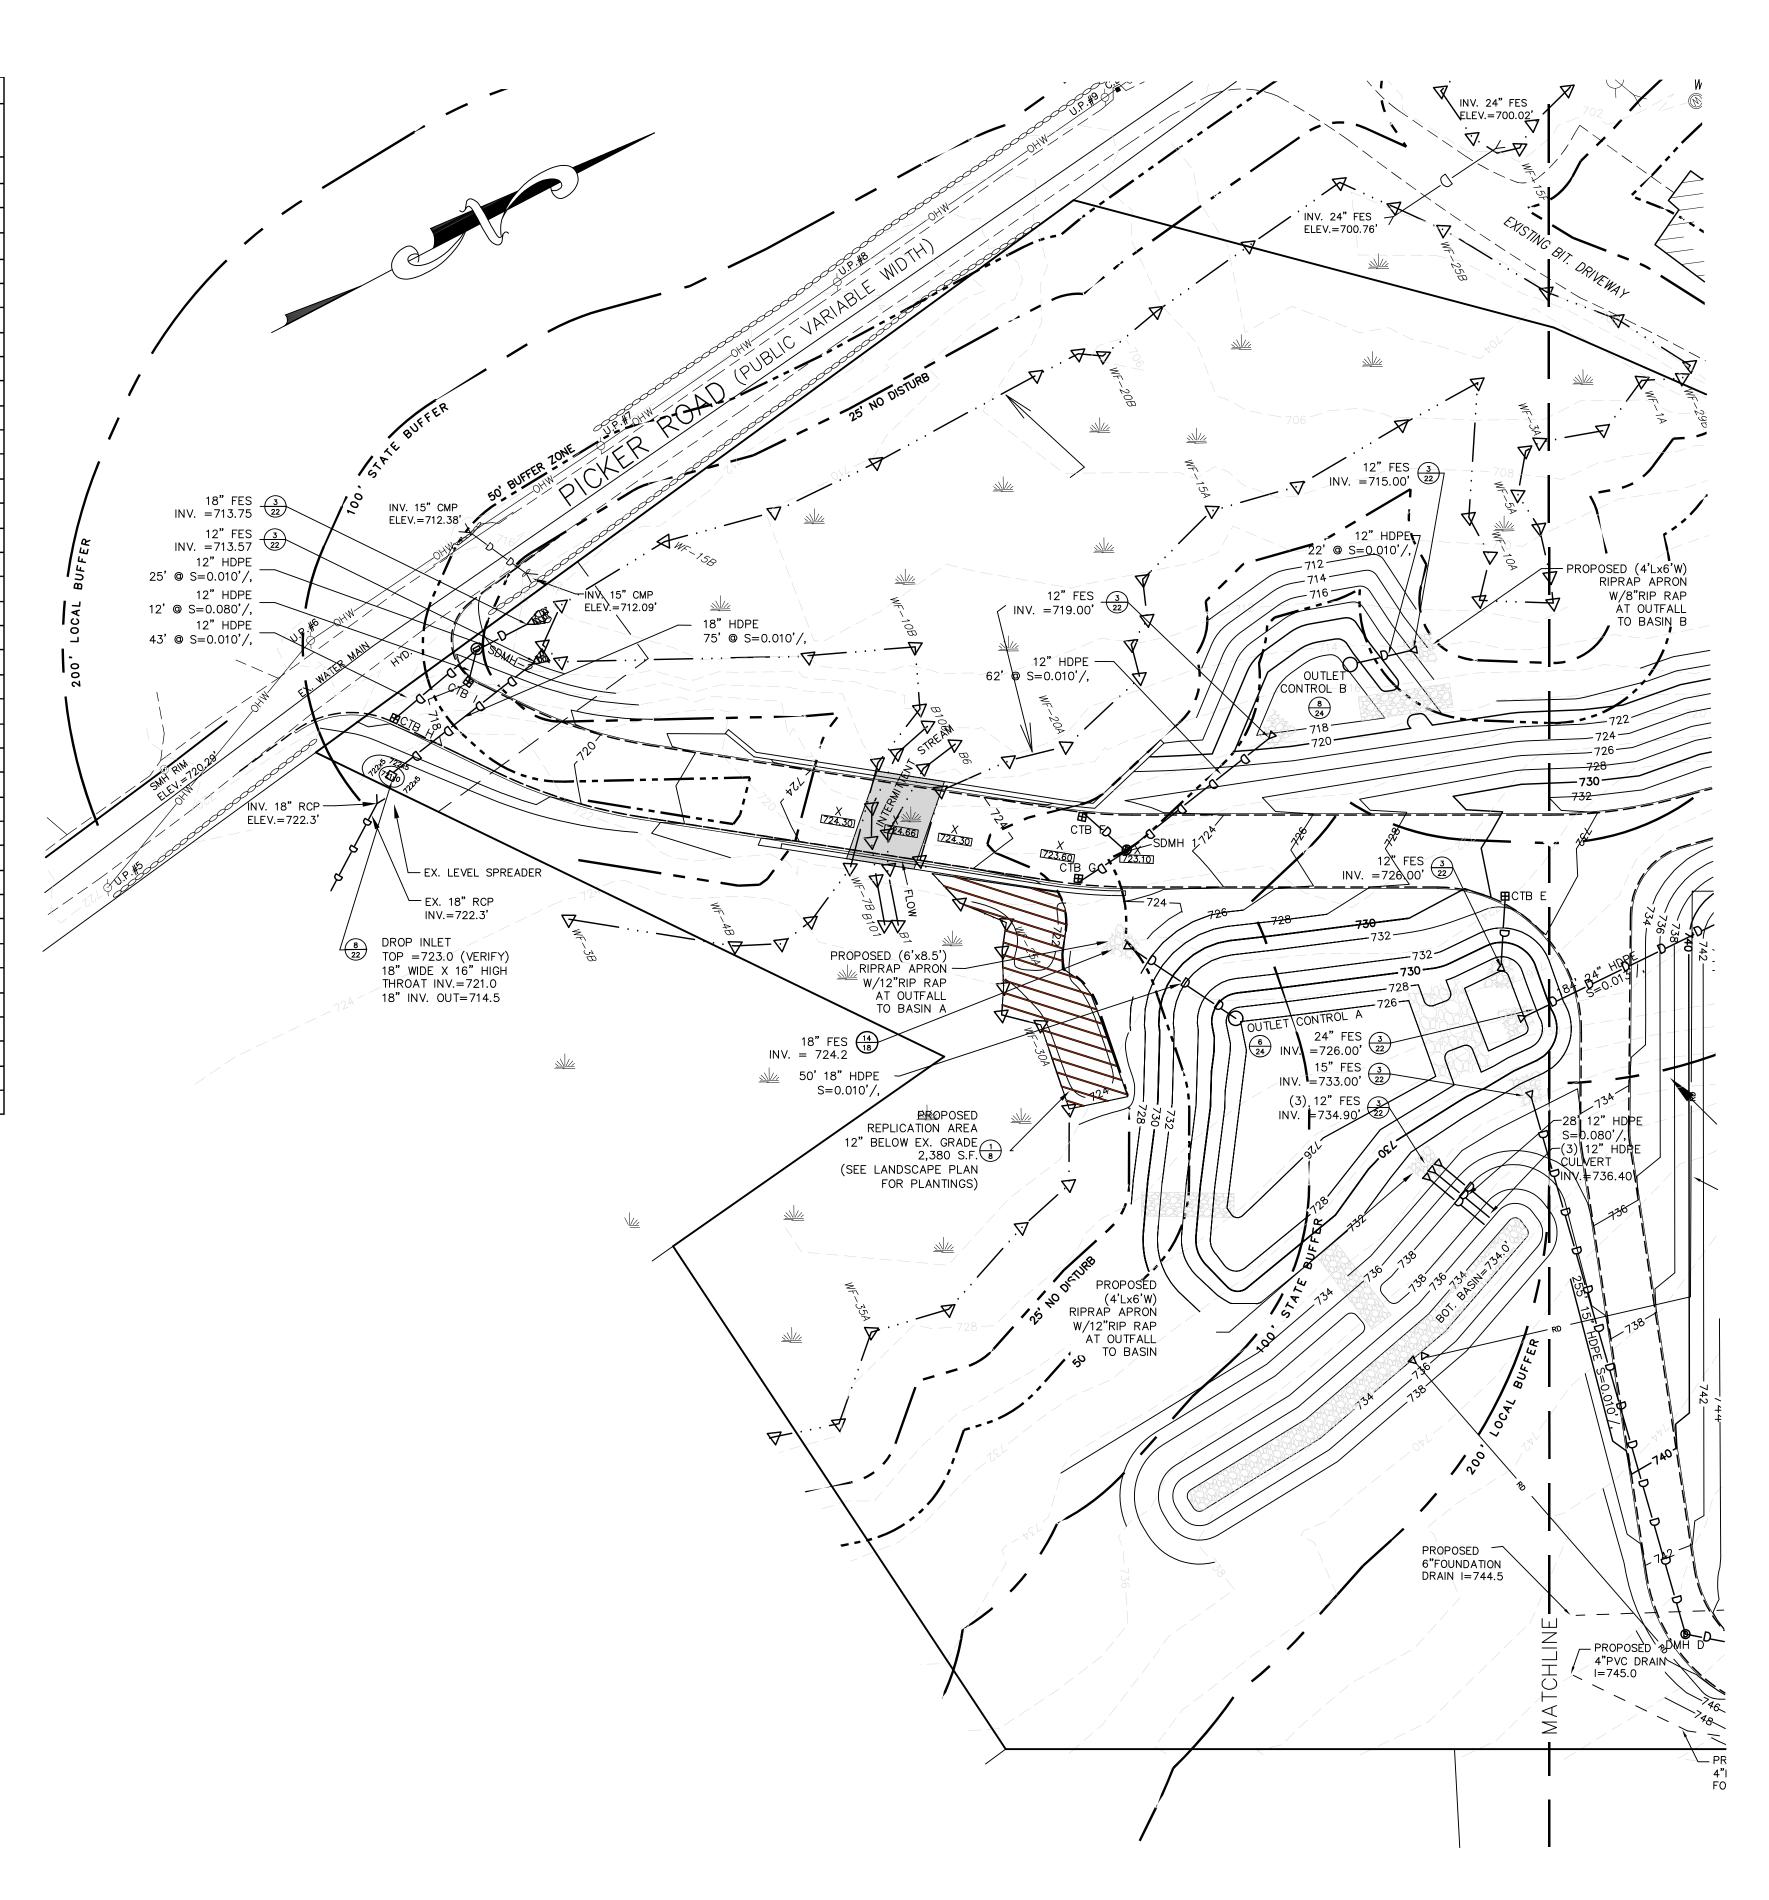



UTILITIES ARE PLOTTED FROM FIELD LOCATION AND ANY RECORD INFORMATION AVAILABLE, AND SHOULD BE CONSIDERED APPROXIMATE. OTHER UTILITIES MAY EXIST WHICH ARE NOT EVIDENT OR FOR WHICH RECORD INFORMATION WAS NOT AVAILABLE. CONTRACTORS (IN ACCORDANCE WITH MASS.G.L. CHAPTER 82 SECTION 40 AS AMENDED) MUST CONTACT ALL UTILITY COMPANIES BEFORE EXCAVATING AND DRILLING. ALSO, CALL "DIG-SAFE" AT 1(888)344-7233 {1(888)DIG-SAFE}.

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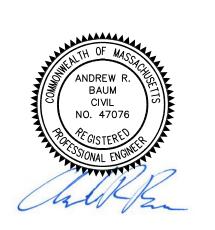

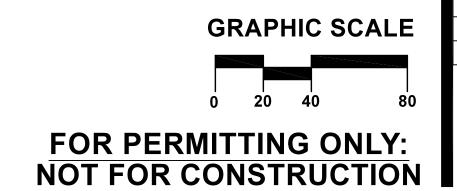
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NEW ENGLAND COLD STORAGE, LLC.

> 6 PICKER ROAD STURBRIDGE, MA

DRAINAGE

7/17/20 - SITE LAYOUT RE-DESIGN
6/15/20 - REPLICATION AREA ADDED
6/1/20 - PER CONSERVATION COMMISSION COMMENTS


REVISIONS

DATE: 1" = 40"

DATE: MAY 12, 2020

JOB NO: 20-122

PLAN NO: 20-122 DEFINITIVE SITE PLAN

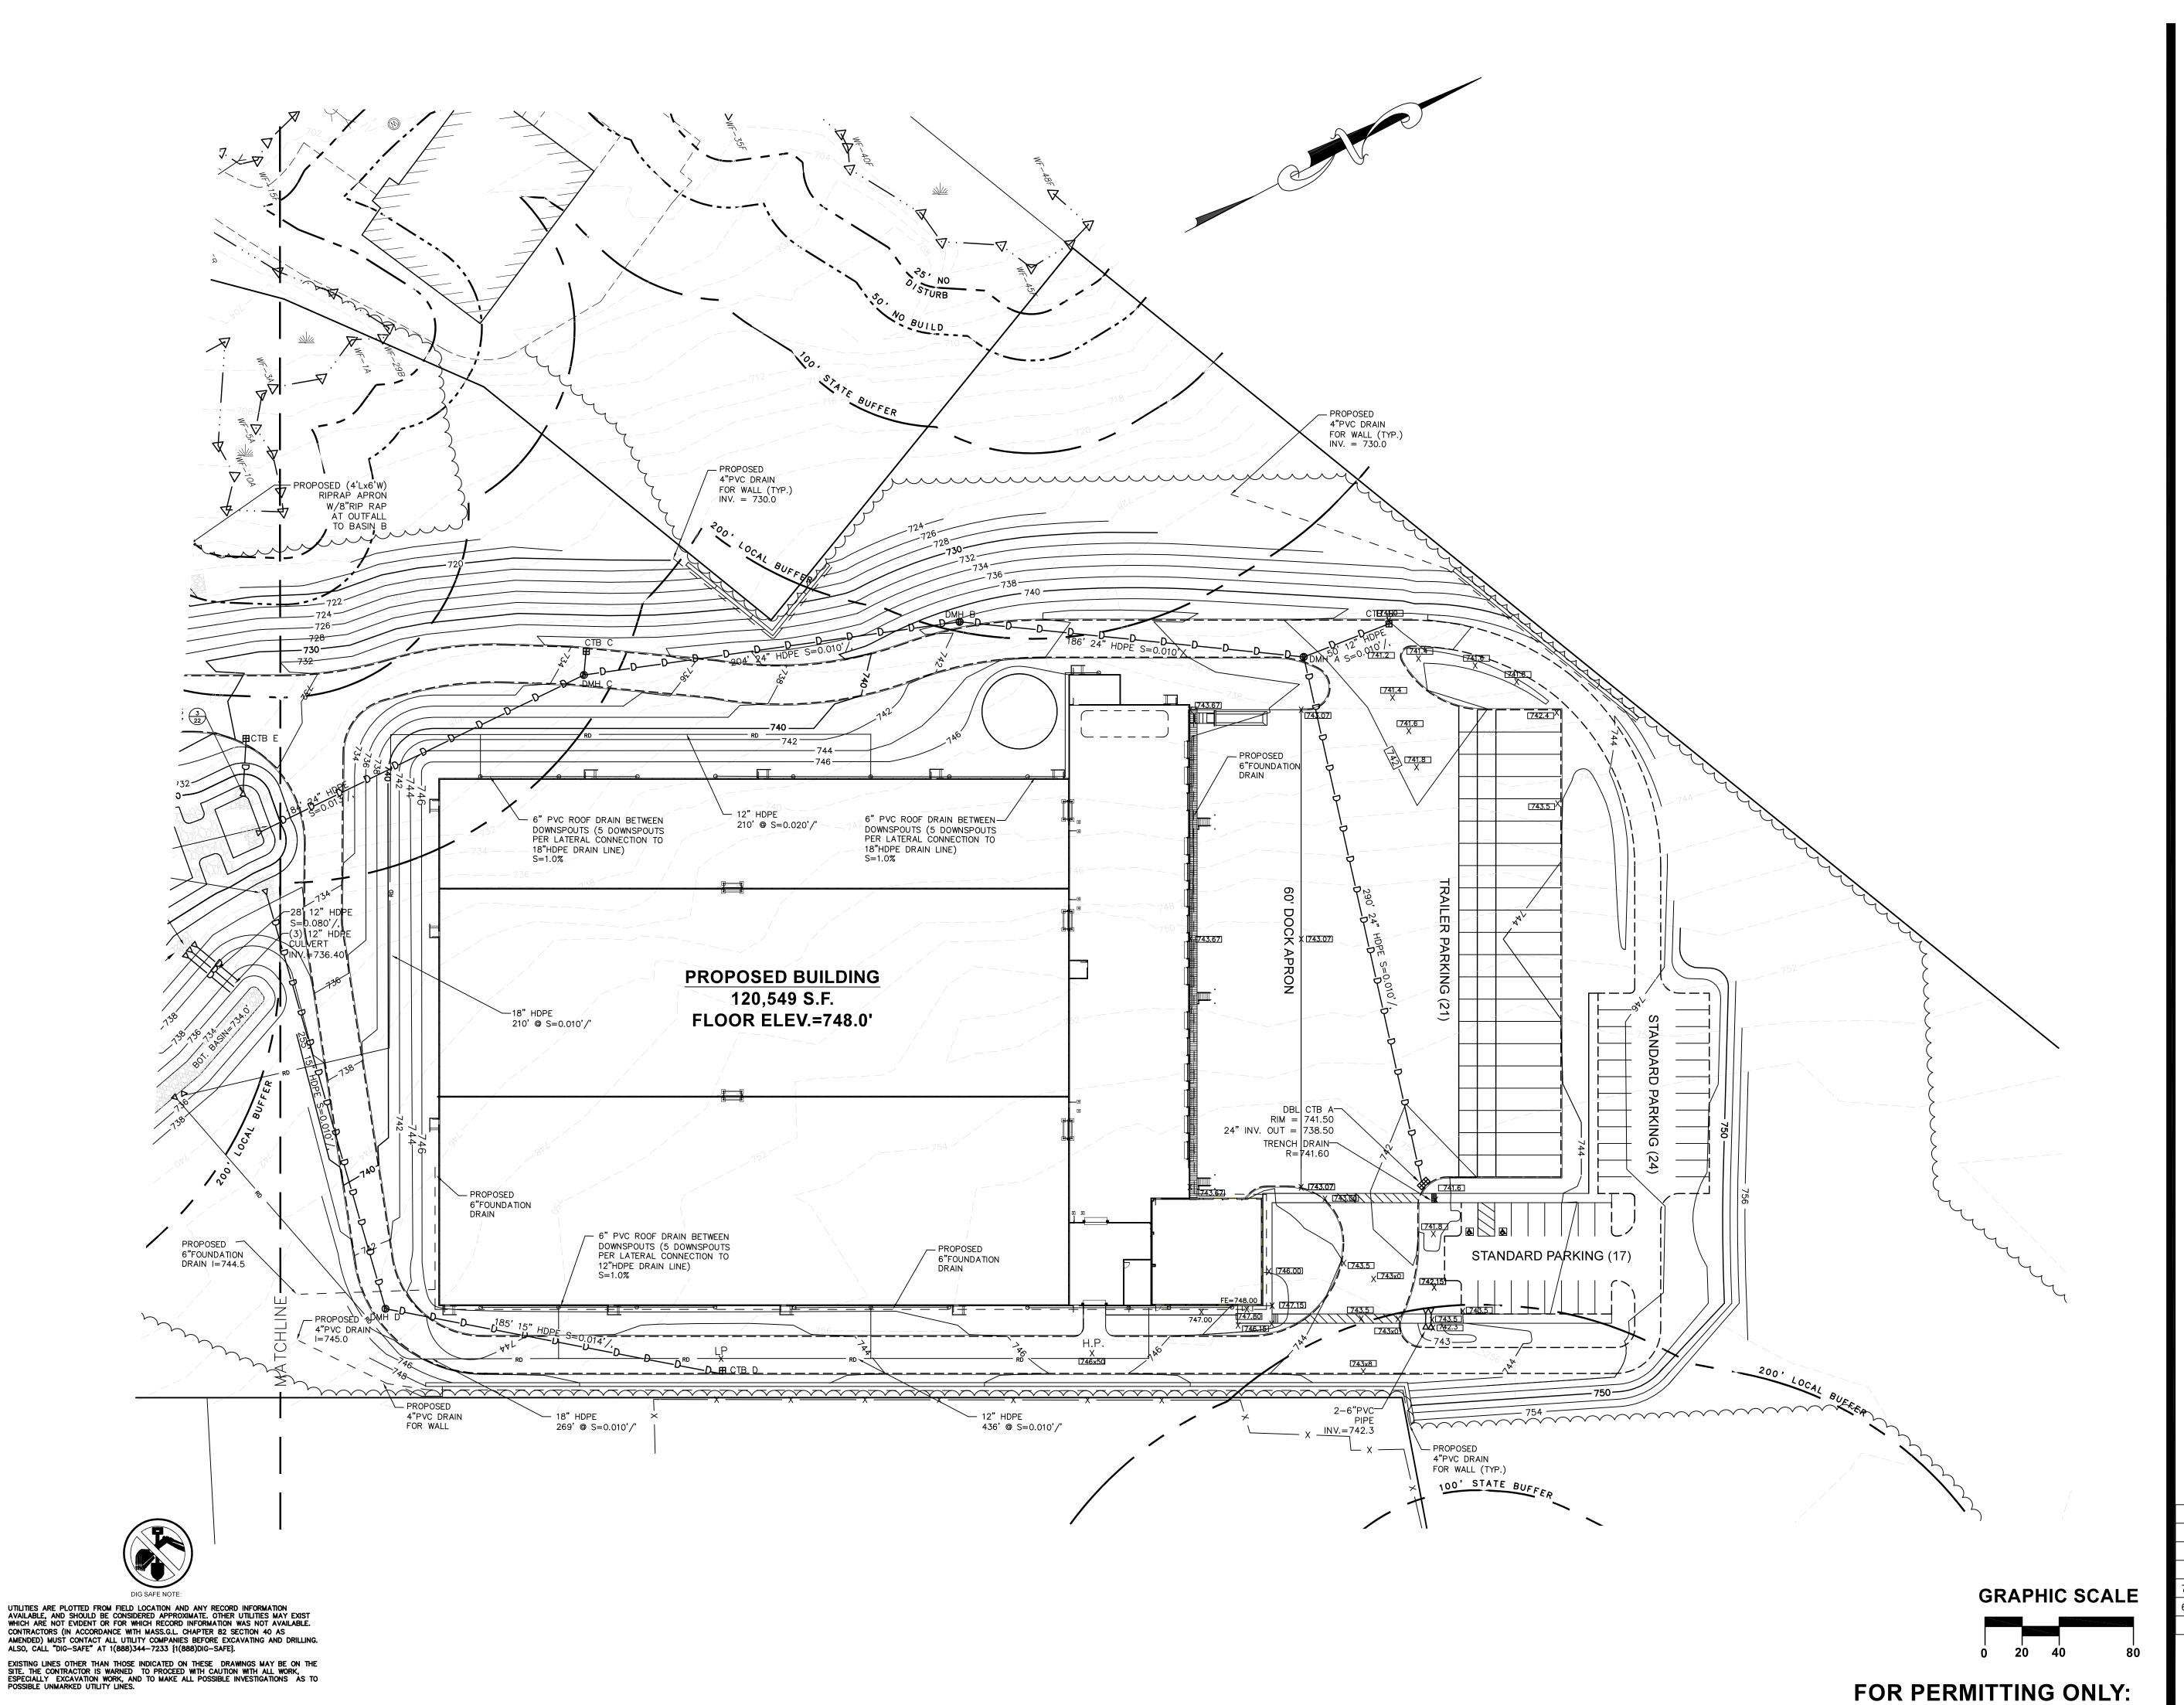










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NEW ENGLAND COLD STORAGE, LLC.

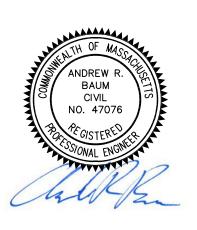6 PICKER ROAD STURBRIDGE, MA

DRAINAGE


7/17/20 - SITE LAYOUT RE-DESIGN

6/1/20 - PER CONSERVATION COMMISSION COMMENTS REVISIONS

MAY 12, 2020 DATE: 20-122 JOB NO:

PLAN NO: 20-122 DEFINITIVE SITE PLAN 11 OF 24

NOT FOR CONSTRUCTION

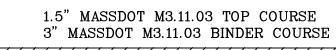

MASS DOT M2.01.07 18" DENSE GRADED CRUSHED STONE SUB-BASE

HEAVY DUTY (ONE-WAY) PAVEMENT DETAIL

NOT TO SCALE

2" MASSDOT M3.11.03 TOP COURSE 3" MASSDOT M3.11.03 BINDER COURSE

MASS DOT M2.01.07 18" DENSE GRADED CRUSHED STONE SUB-BASE


5" HEAVY DUTY (TWO-WAY) PAVEMENT DETAIL

NOT TO SCALE

SIGN NO.	SIGN	SIZE AND COLOR
R1–1	STOP	30"X30"; WHITE ON RED
X–R6–R1	ONE WAY	6" X 18"; BLACK ON WHITE 3" MIN LETTERS
	RESERVED PARKING	18"X12"; WHITE ON BLUE
D-3	LEFT TURN ONLY	18"X24"; BLACK ON WHITE
R5–1	DO NOT SATER	30"X30"; RED ON WHITE

TRAFFIC CONTROL SIGNAGE

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PAVEMENT TYPE

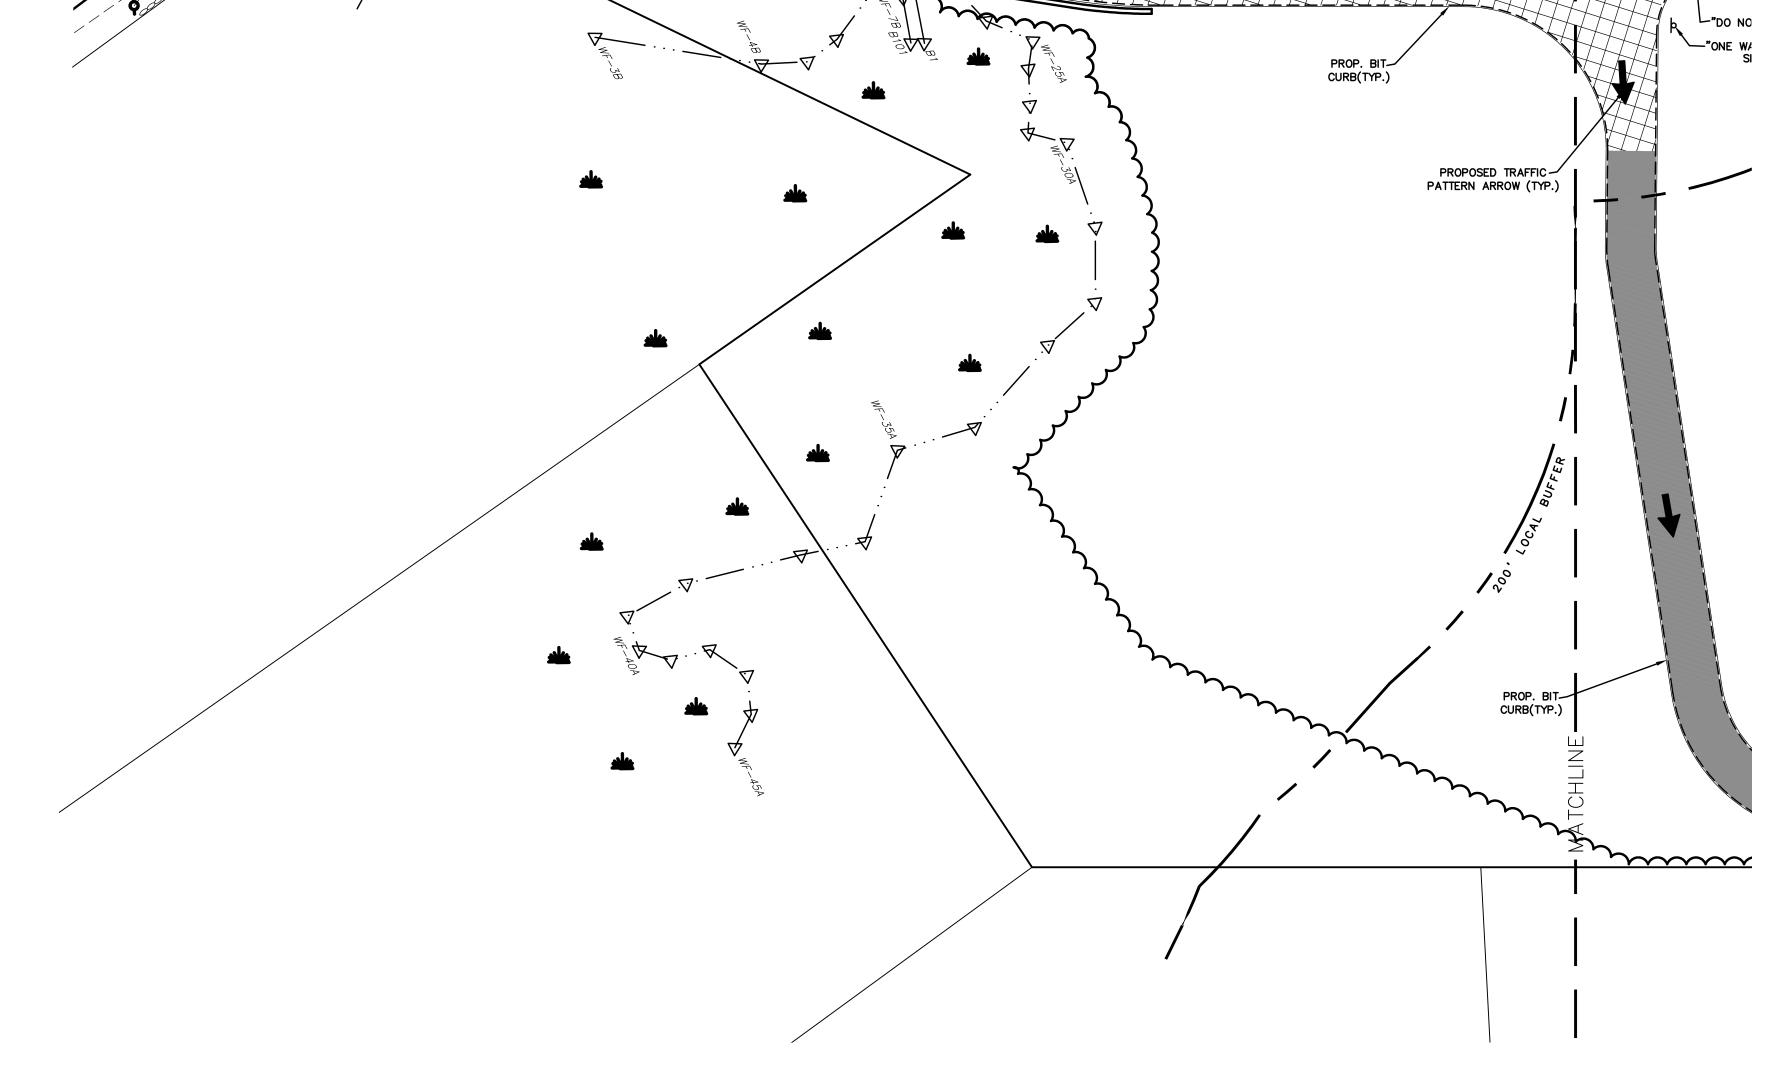CONCRETE SIDEWALK

CONCRETE APRON

PROP. BIT-

STANDARD PAVEMENT

LIGHT DUTY PAVEMENT HEAVY DUTY PAVEMENT

5" HEAVY DUTY PAVEMENT

GRAPHIC SCALE

NOT FOR CONSTRUCTION






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NEW ENGLAND COLD STORAGE, LLC.

6 PICKER ROAD STURBRIDGE, MA

PAVING PLAN


7/17/20 - SITE LAYOUT RE-DESIGN

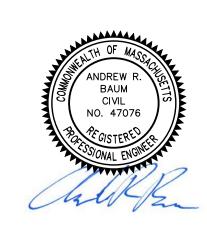6/1/20 - PER CONSERVATION COMMISSION COMMENTS


SCALE: 1" = 40' MAY 12, 2020

20-122 DEFINITIVE SITE PLAN 12 OF 24

EXISTING LINES OTHER THAN THOSE INDICATED ON THESE DRAWINGS MAY BE ON THE SITE. THE CONTRACTOR IS WARNED TO PROCEED WITH CAUTION WITH ALL WORK, ESPECIALLY EXCAVATION WORK, AND TO MAKE ALL POSSIBLE INVESTIGATIONS AS TO POSSIBLE UNMARKED UTILITY LINES. FOR PERMITTING ONLY: PLAN NO:

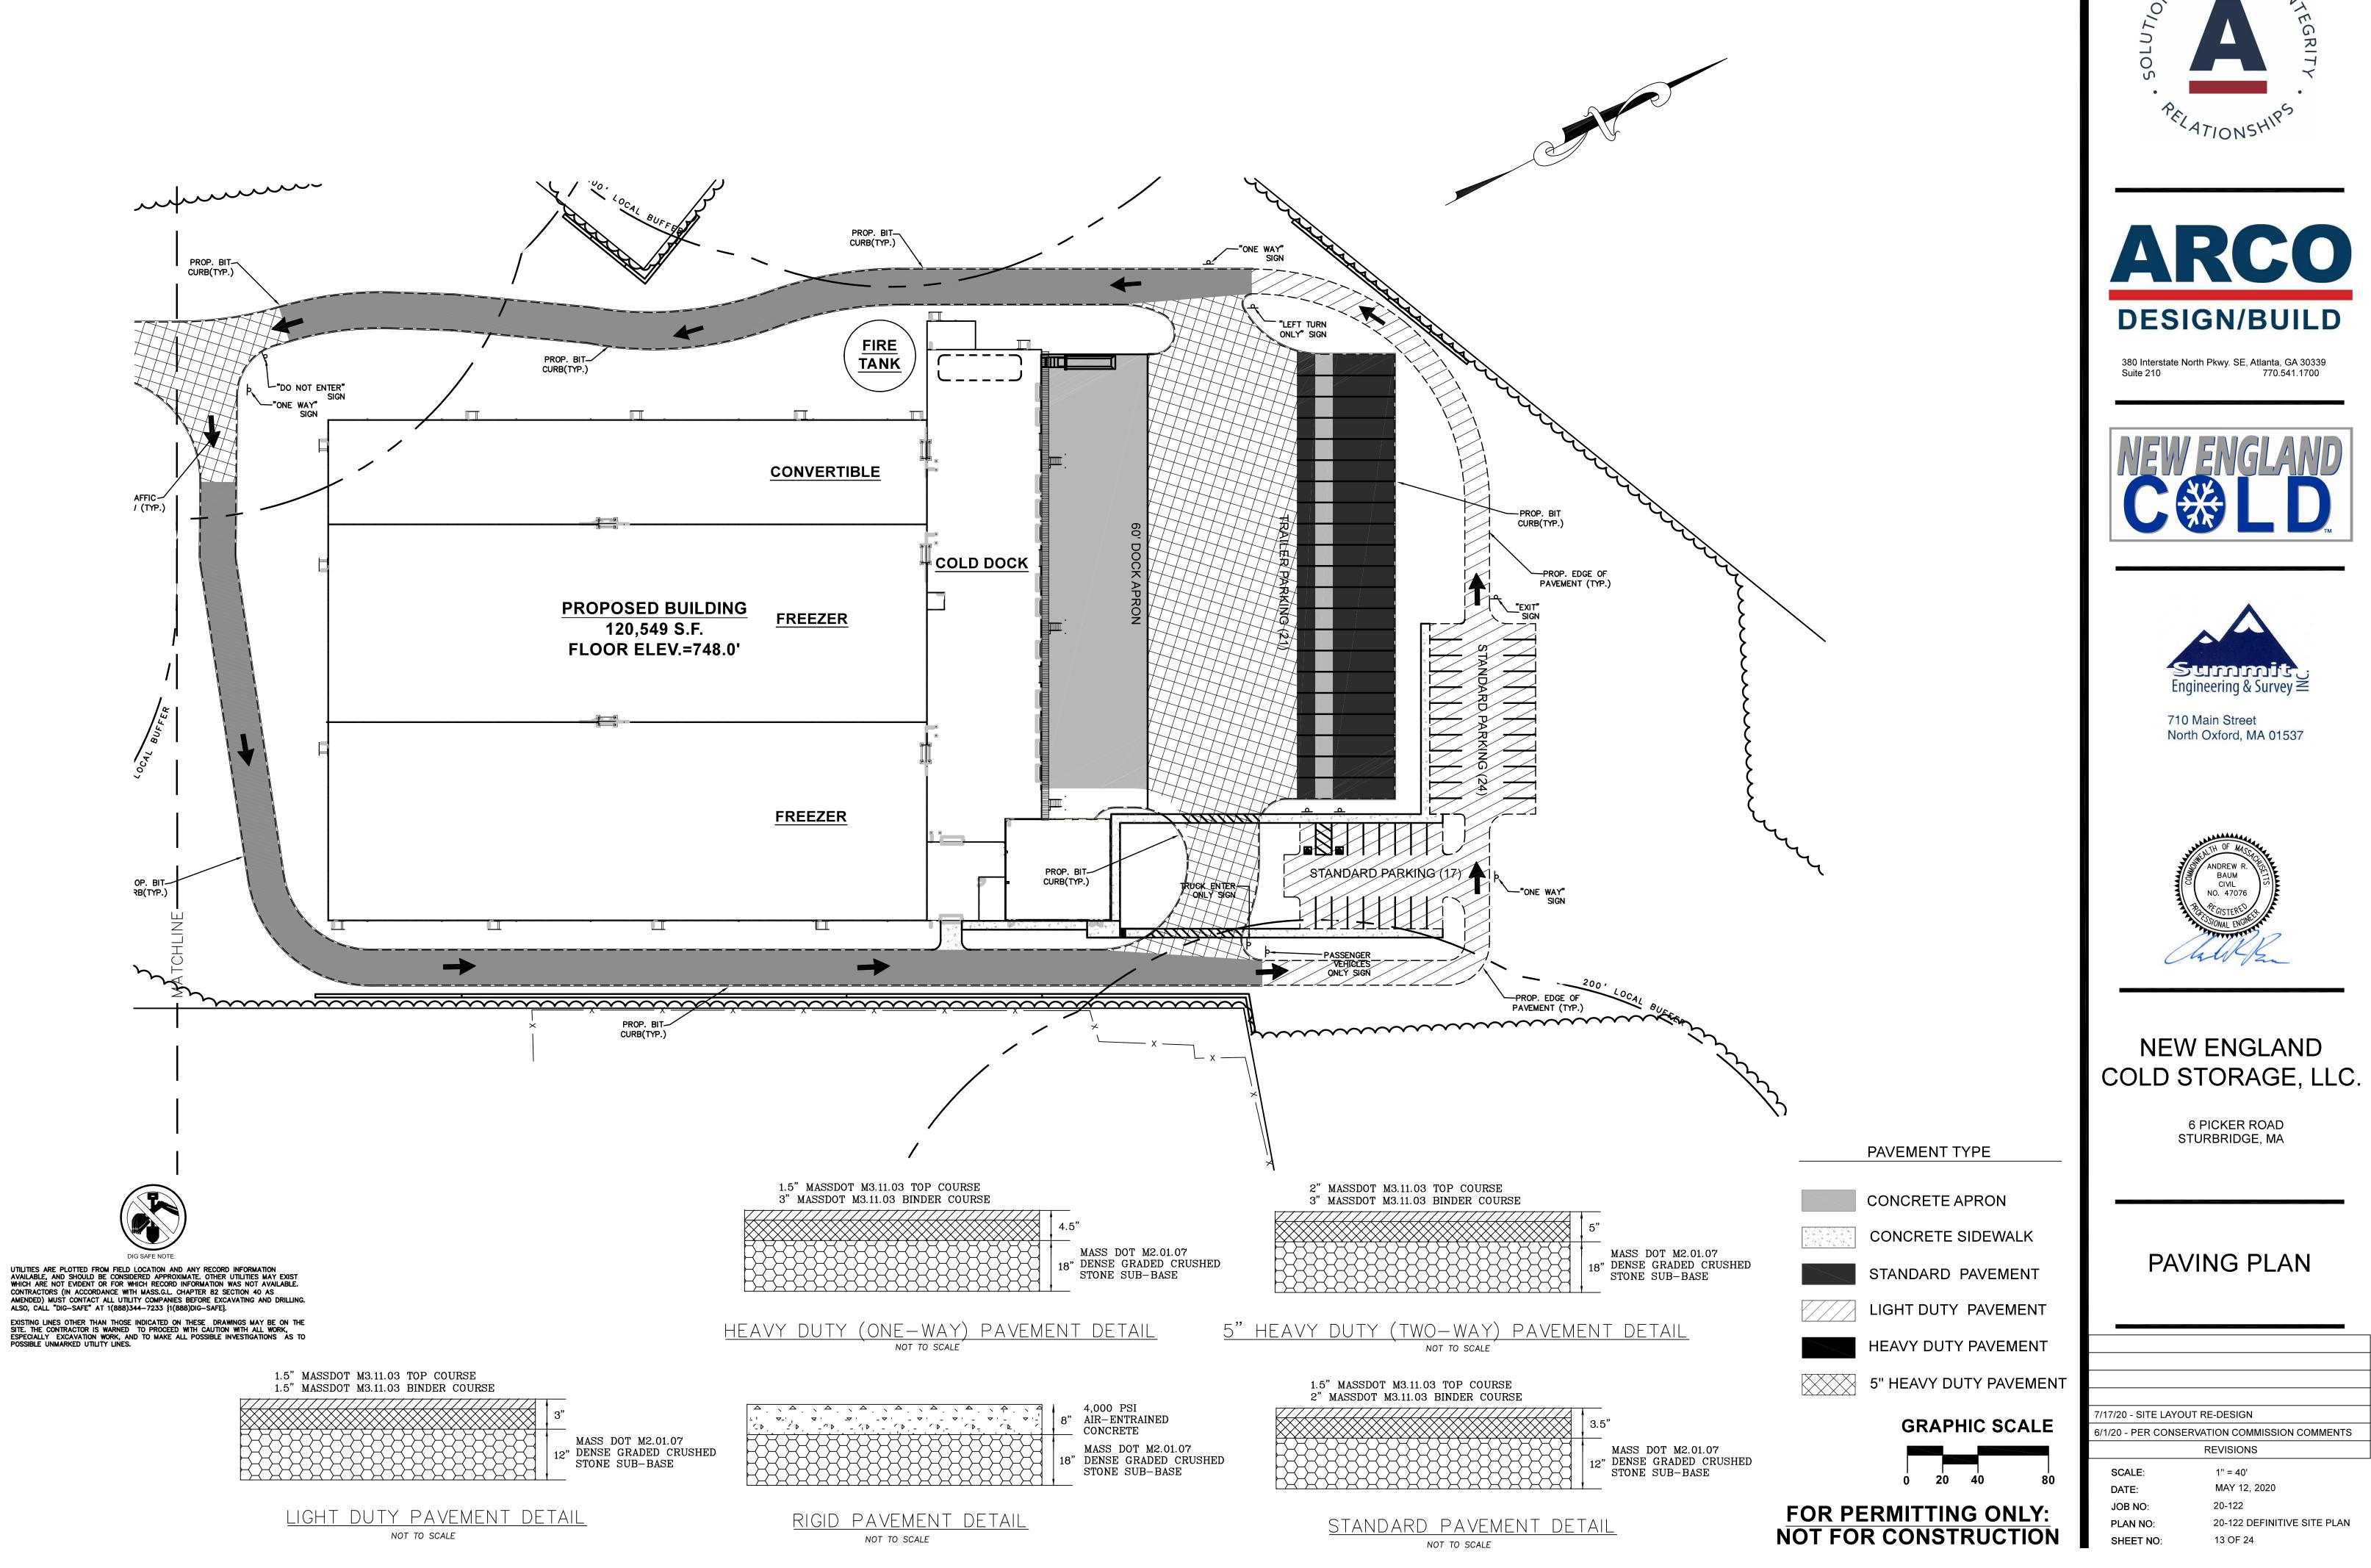



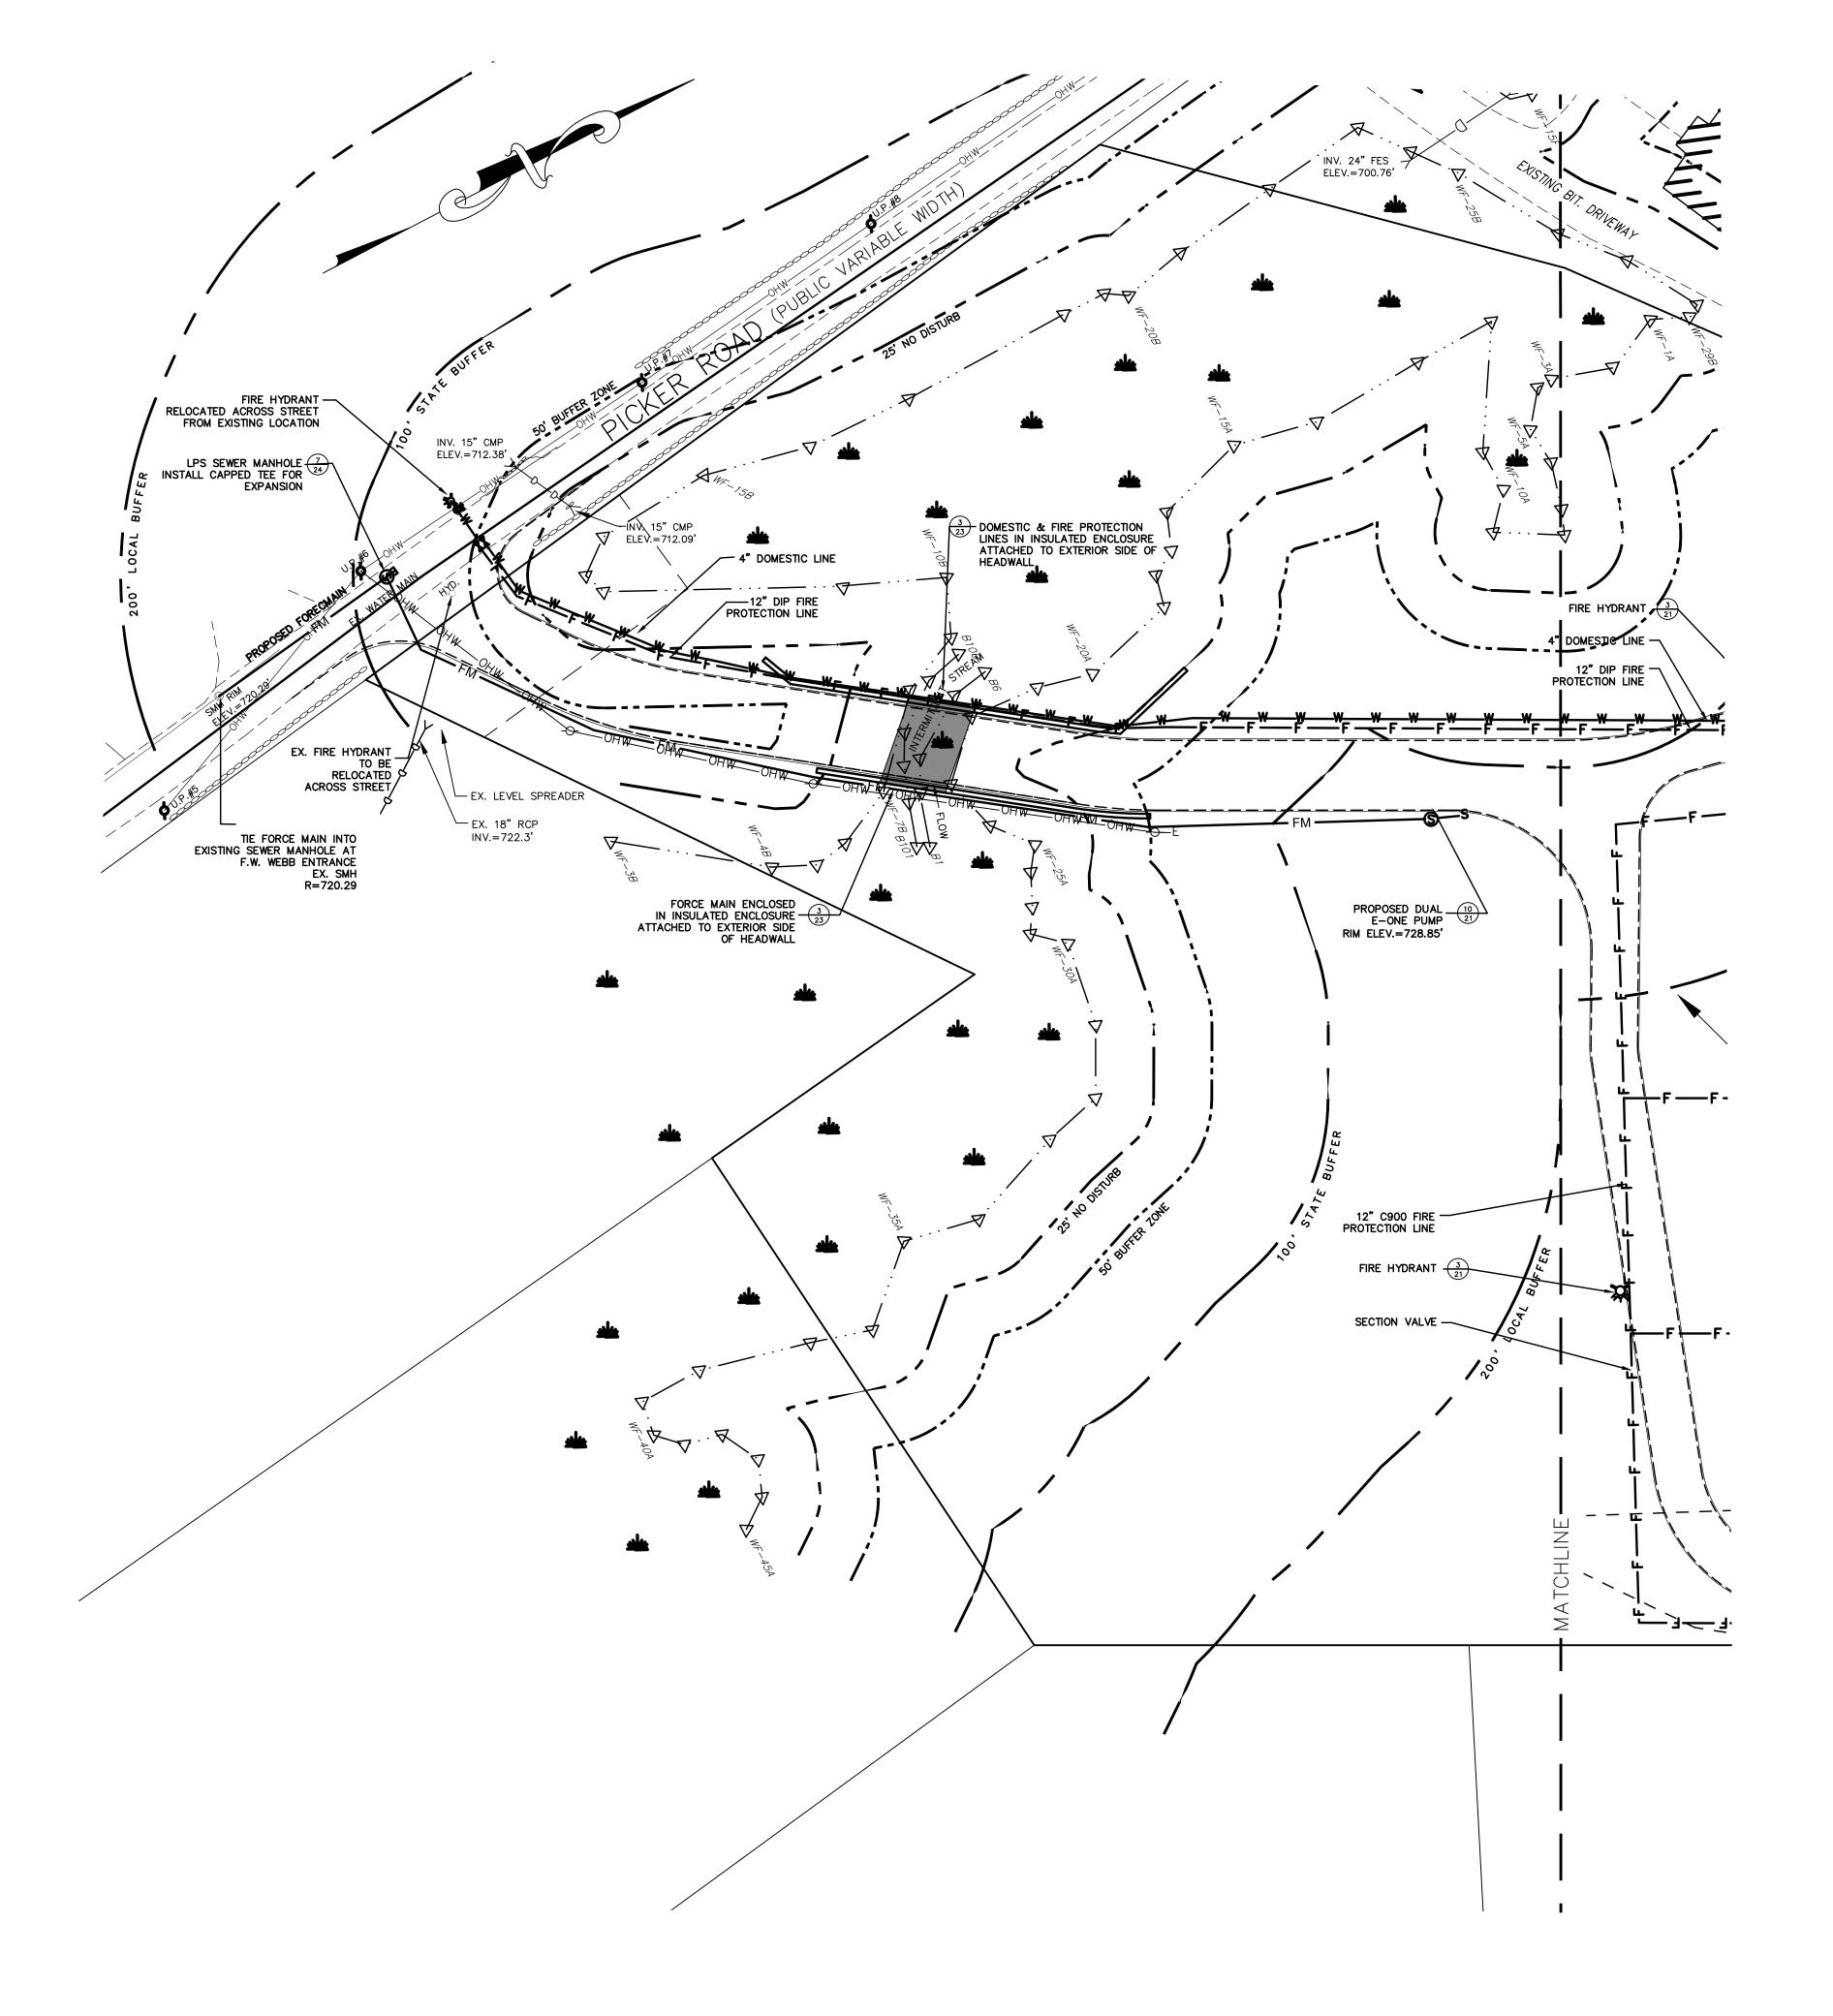









710 Main Street North Oxford, MA 01537



NEW ENGLAND COLD STORAGE, LLC.

6 PICKER ROAD STURBRIDGE, MA

LAYOUT & UTILITIES

14 OF 24

GRAPHIC SCALE

6/1/20 - PER CONSERVATION COMMISSION COMMENTS REVISIONS

SCALE: 1" = 40' MAY 12, 2020 20-122 20-122 DEFINITIVE SITE PLAN PLAN NO:

7/17/20 - SITE LAYOUT RE-DESIGN

FOR PERMITTING ONLY: NOT FOR CONSTRUCTION

-----W----W-----W WATER LINE

FIRE PROTECTION LINE
OHW—OHW—OHW—OWERHEAD WIRES

GUARD RAILING (AS NOTED)

<u>LEGEND</u>

SEWER MANHOLE DRAIN MANHOLE CATCH BASIN CLEANOUT UTILITY POLE

WATER GATE VALVE WATER SHUT OFF

SPOT LIGHT

ELECTRIC LINE


SEWER LINE DRAIN LINE

LIGHT POLE / LAMP POST

VERTICAL GRANITE CURBING CONCRETE CURBING

CAPE COD BERM (BITUMINOUS) BITUMINOUS CURBING (GENERIC)

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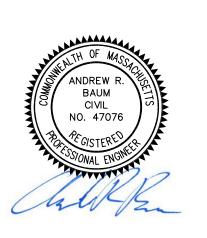


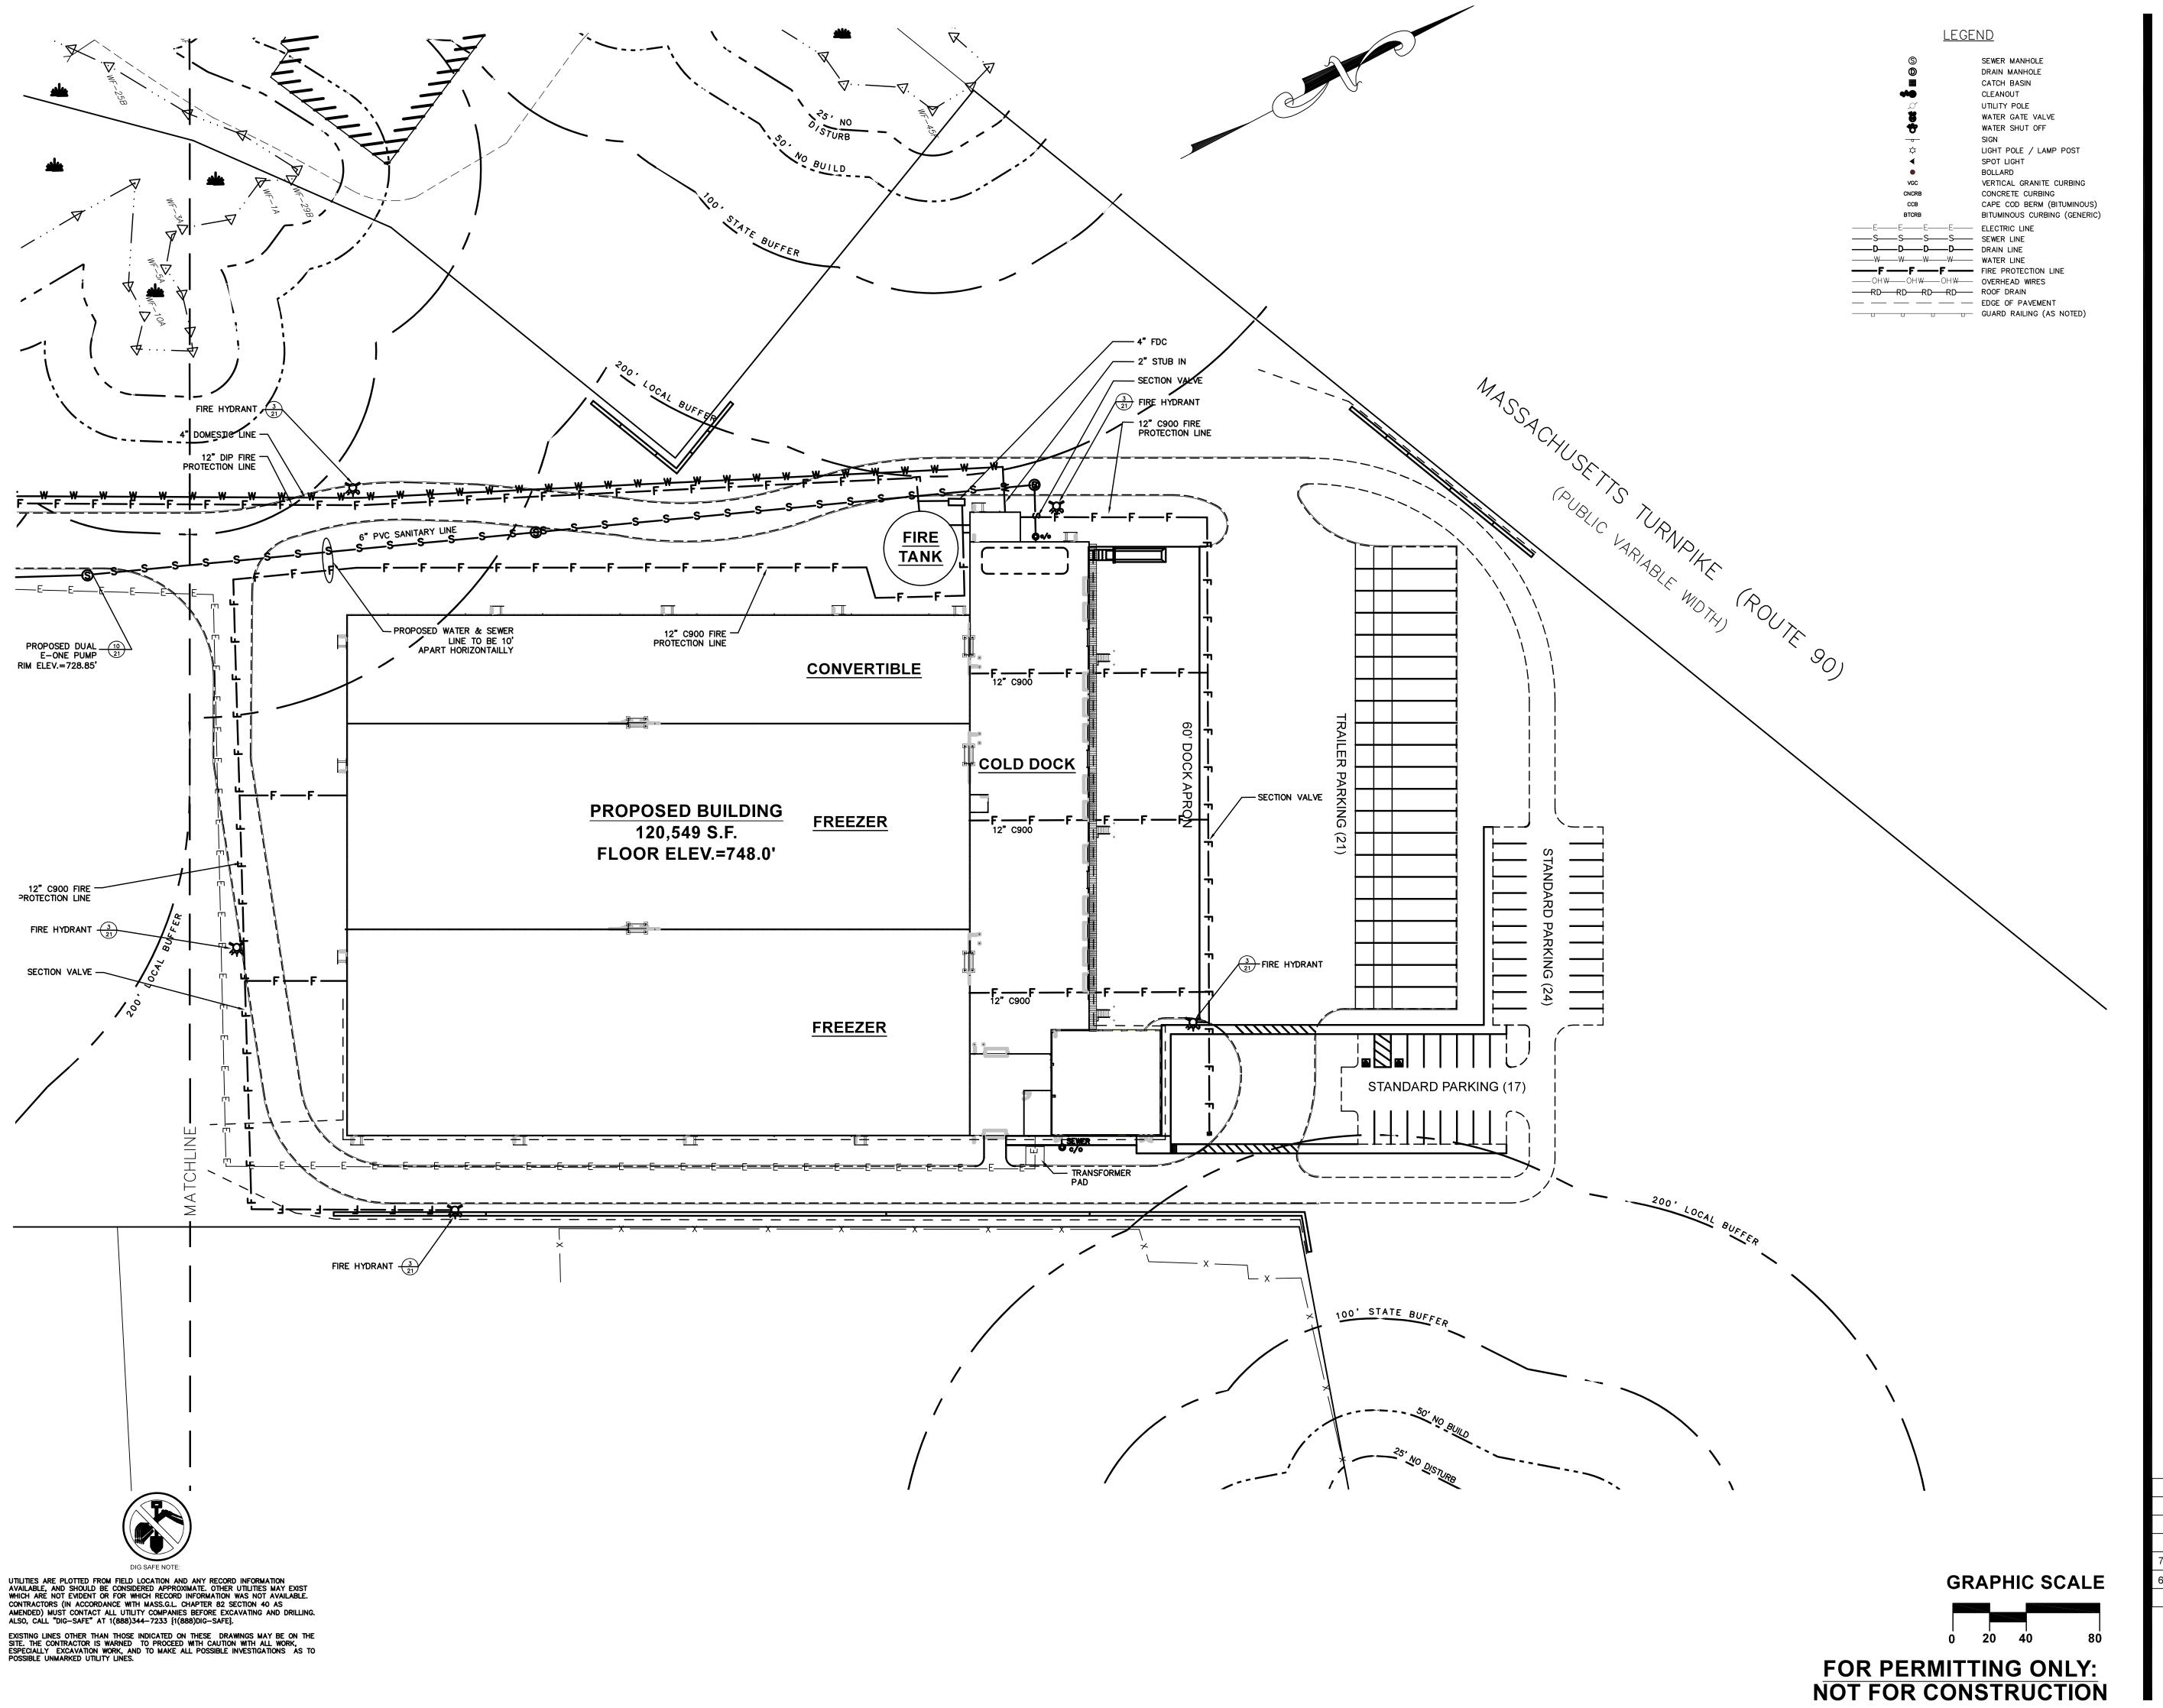





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NEW ENGLAND COLD STORAGE, LLC.

> 6 PICKER ROAD STURBRIDGE, MA

LAYOUT & UTILITIES

7/?/20 - SITE LAYOUT RE-DESIGN

REVISIONS

SCALE: 1" = 40'


DATE: MAY 12, 2020

20-122

JOB NO: 20-122

PLAN NO: 20-122 DEFINITIVE SITE PLAN

SHEET NO: 15 OF 24

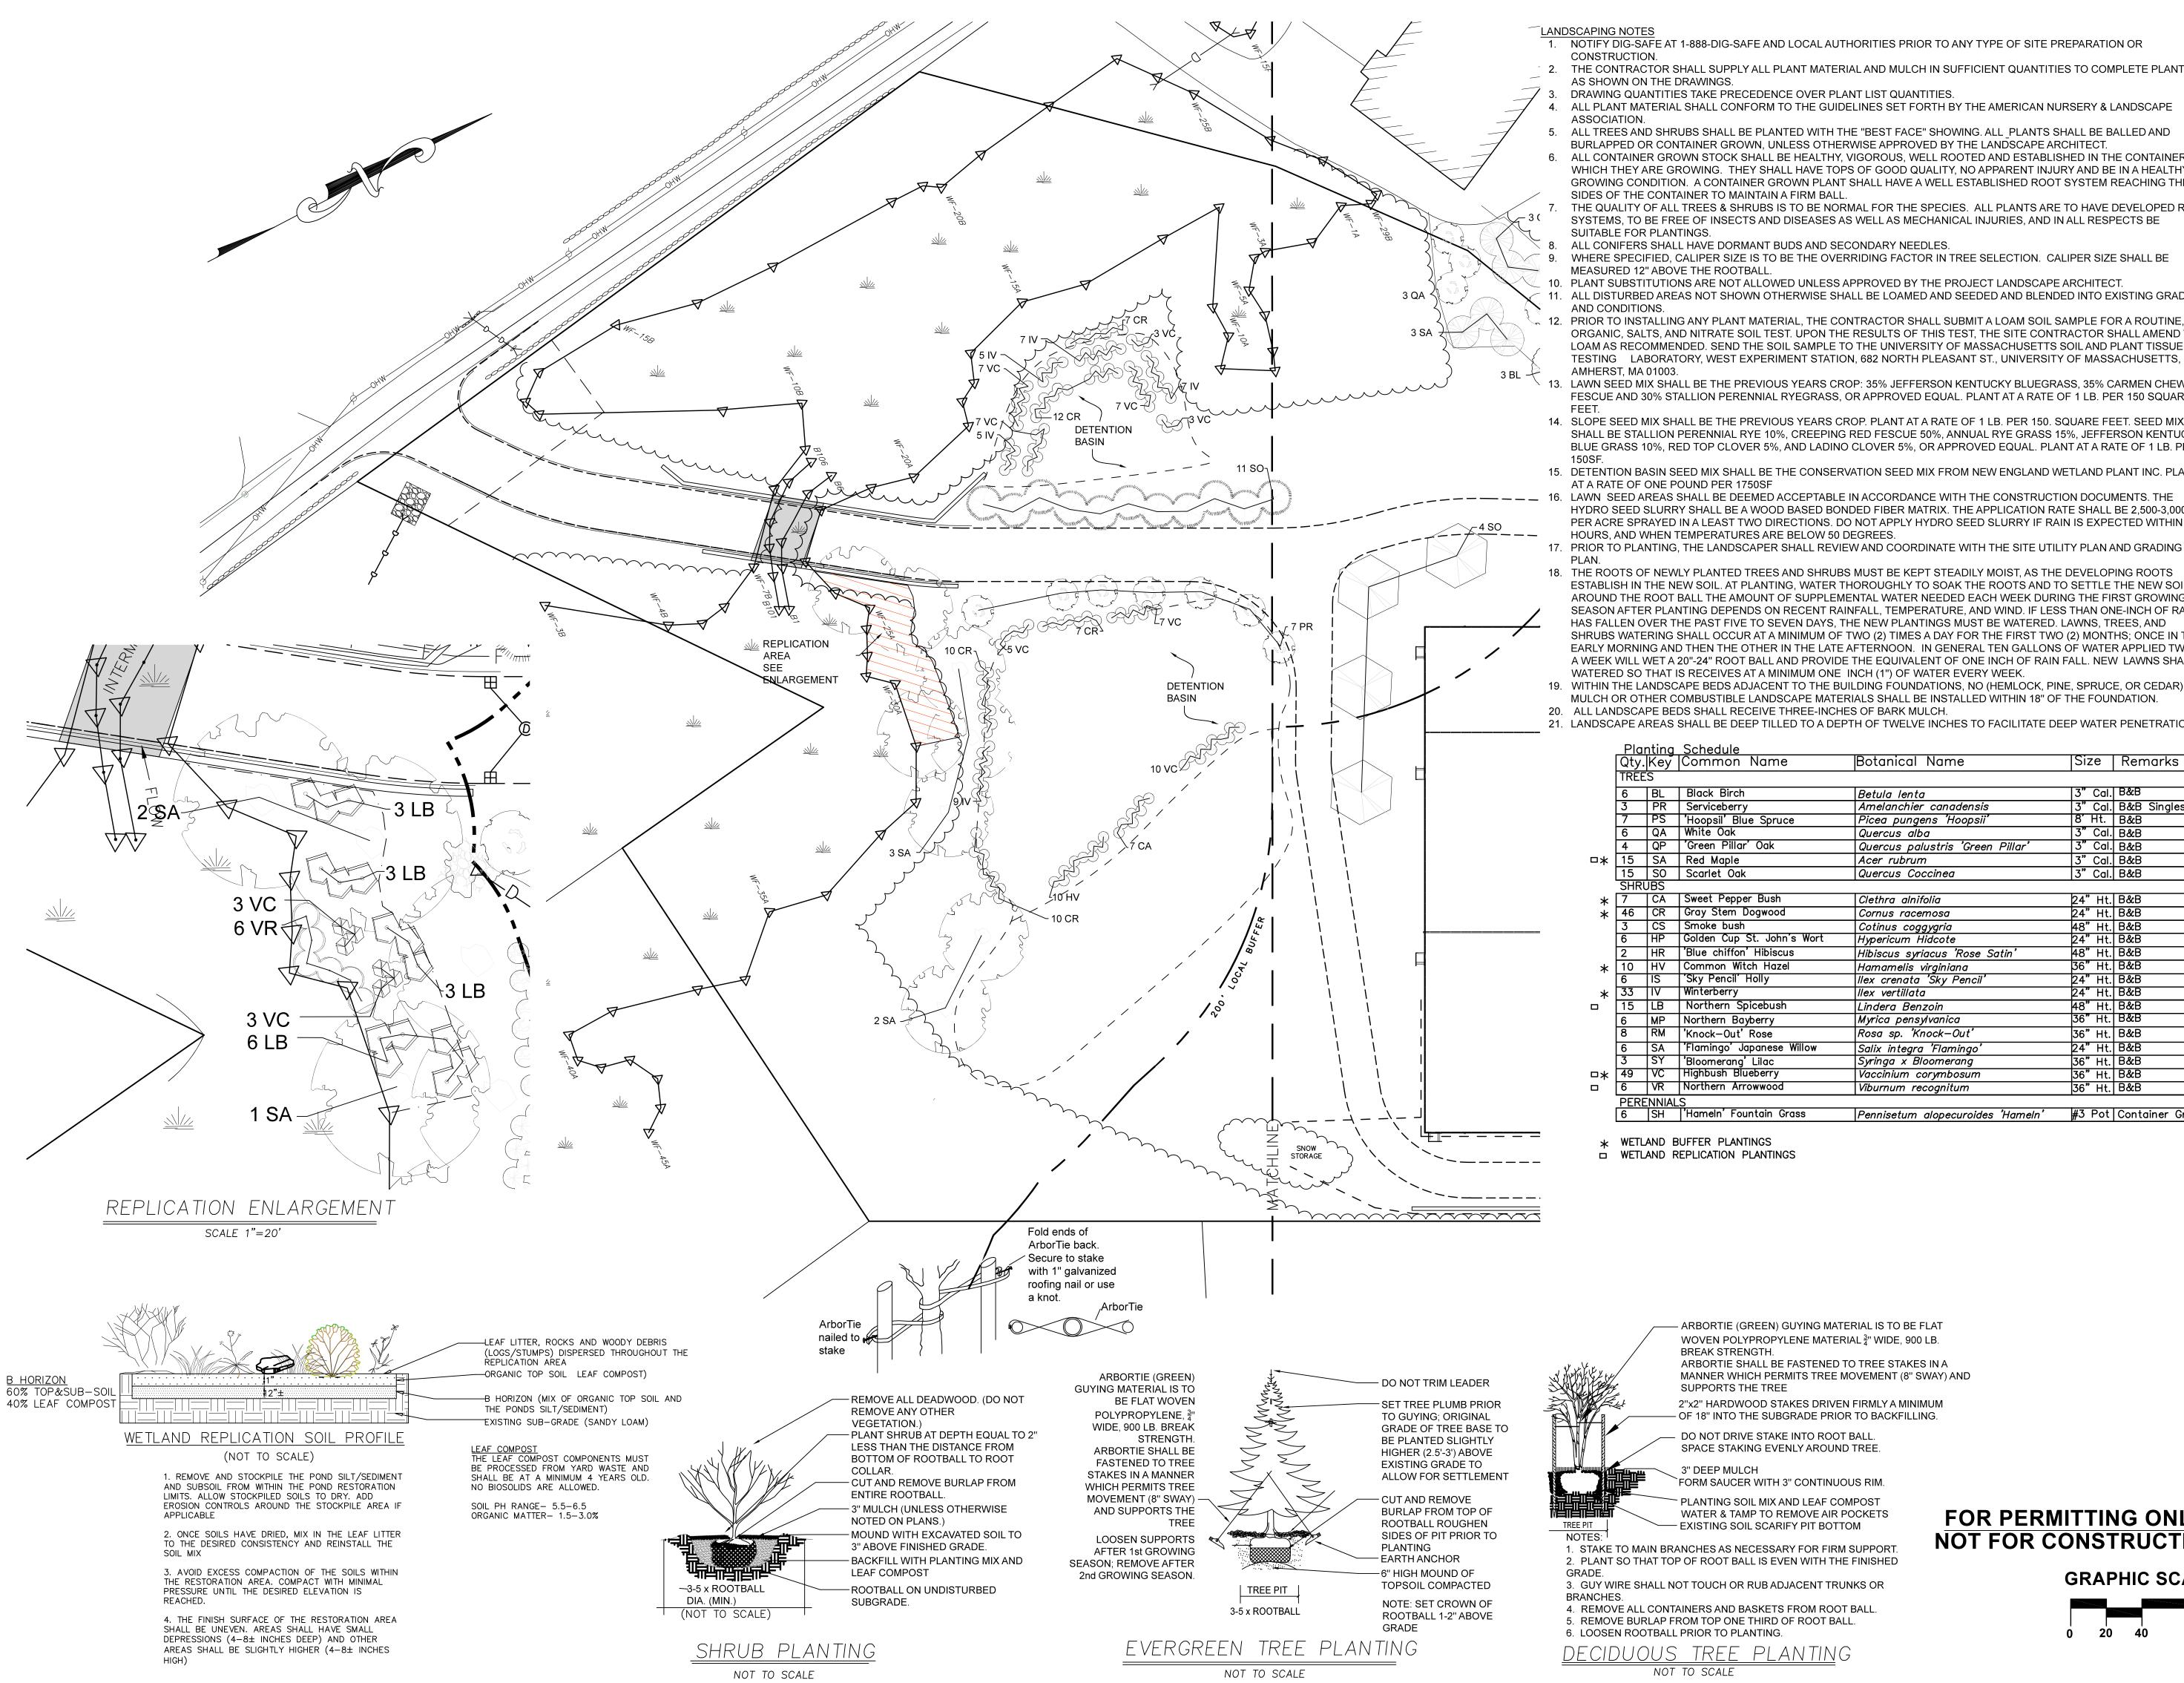

1. NOTIFY DIG-SAFE AT 1-888-DIG-SAFE AND LOCAL AUTHORITIES PRIOR TO ANY TYPE OF SITE PREPARATION OR

THE CONTRACTOR SHALL SUPPLY ALL PLANT MATERIAL AND MULCH IN SUFFICIENT QUANTITIES TO COMPLETE PLANTING

AS SHOWN ON THE DRAWINGS. DRAWING QUANTITIES TAKE PRECEDENCE OVER PLANT LIST QUANTITIES.

ALL PLANT MATERIAL SHALL CONFORM TO THE GUIDELINES SET FORTH BY THE AMERICAN NURSERY & LANDSCAPE

5. ALL TREES AND SHRUBS SHALL BE PLANTED WITH THE "BEST FACE" SHOWING. ALL PLANTS SHALL BE BALLED AND

BURLAPPED OR CONTAINER GROWN, UNLESS OTHERWISE APPROVED BY THE LANDSCAPE ARCHITECT.

ALL CONTAINER GROWN STOCK SHALL BE HEALTHY, VIGOROUS, WELL ROOTED AND ESTABLISHED IN THE CONTAINER IN WHICH THEY ARE GROWING. THEY SHALL HAVE TOPS OF GOOD QUALITY, NO APPARENT INJURY AND BE IN A HEALTHY GROWING CONDITION. A CONTAINER GROWN PLANT SHALL HAVE A WELL ESTABLISHED ROOT SYSTEM REACHING THE SIDES OF THE CONTAINER TO MAINTAIN A FIRM BALL.

THE QUALITY OF ALL TREES & SHRUBS IS TO BE NORMAL FOR THE SPECIES. ALL PLANTS ARE TO HAVE DEVELOPED ROOT SYSTEMS, TO BE FREE OF INSECTS AND DISEASES AS WELL AS MECHANICAL INJURIES, AND IN ALL RESPECTS BE

8. ALL CONIFERS SHALL HAVE DORMANT BUDS AND SECONDARY NEEDLES.

WHERE SPECIFIED, CALIPER SIZE IS TO BE THE OVERRIDING FACTOR IN TREE SELECTION. CALIPER SIZE SHALL BE MEASURED 12" ABOVE THE ROOTBALL

10. PLANT SUBSTITUTIONS ARE NOT ALLOWED UNLESS APPROVED BY THE PROJECT LANDSCAPE ARCHITECT 11. ALL DISTURBED AREAS NOT SHOWN OTHERWISE SHALL BE LOAMED AND SEEDED AND BLENDED INTO EXISTING GRADE

12. PRIOR TO INSTALLING ANY PLANT MATERIAL, THE CONTRACTOR SHALL SUBMIT A LOAM SOIL SAMPLE FOR A ROUTINE, ORGANIC, SALTS, AND NITRATE SOIL TEST. UPON THE RESULTS OF THIS TEST, THE SITE CONTRACTOR SHALL AMEND THE LOAM AS RECOMMENDED. SEND THE SOIL SAMPLE TO THE UNIVERSITY OF MASSACHUSETTS SOIL AND PLANT TISSUE

LAWN SEED MIX SHALL BE THE PREVIOUS YEARS CROP: 35% JEFFERSON KENTUCKY BLUEGRASS, 35% CARMEN CHEWING FESCUE AND 30% STALLION PERENNIAL RYEGRASS. OR APPROVED EQUAL, PLANT AT A RATE OF 1 LB. PER 150 SQUARE

14. SLOPE SEED MIX SHALL BE THE PREVIOUS YEARS CROP. PLANT AT A RATE OF 1 LB. PER 150. SQUARE FEET. SEED MIX SHALL BE STALLION PERENNIAL RYE 10%, CREEPING RED FESCUE 50%, ANNUAL RYE GRASS 15%, JEFFERSON KENTUCKY BLUE GRASS 10%, RED TOP CLOVER 5%, AND LADINO CLOVER 5%, OR APPROVED EQUAL. PLANT AT A RATE OF 1 LB. PER

15. DETENTION BASIN SEED MIX SHALL BE THE CONSERVATION SEED MIX FROM NEW ENGLAND WETLAND PLANT INC. PLANT AT A RATE OF ONE POUND PER 1750SF

LAWN SEED AREAS SHALL BE DEEMED ACCEPTABLE IN ACCORDANCE WITH THE CONSTRUCTION DOCUMENTS. THE HYDRO SEED SLURRY SHALL BE A WOOD BASED BONDED FIBER MATRIX. THE APPLICATION RATE SHALL BE 2.500-3.000LB. PER ACRE SPRAYED IN A LEAST TWO DIRECTIONS. DO NOT APPLY HYDRO SEED SLURRY IF RAIN IS EXPECTED WITHIN 12 HOURS, AND WHEN TEMPERATURES ARE BELOW 50 DEGREES.

17. PRIOR TO PLANTING, THE LANDSCAPER SHALL REVIEW AND COORDINATE WITH THE SITE UTILITY PLAN AND GRADING

18. THE ROOTS OF NEWLY PLANTED TREES AND SHRUBS MUST BE KEPT STEADILY MOIST, AS THE DEVELOPING ROOTS ESTABLISH IN THE NEW SOIL. AT PLANTING, WATER THOROUGHLY TO SOAK THE ROOTS AND TO SETTLE THE NEW SOIL AROUND THE ROOT BALL THE AMOUNT OF SUPPLEMENTAL WATER NEEDED EACH WEEK DURING THE FIRST GROWING SEASON AFTER PLANTING DEPENDS ON RECENT RAINFALL, TEMPERATURE, AND WIND. IF LESS THAN ONE-INCH OF RAIN HAS FALLEN OVER THE PAST FIVE TO SEVEN DAYS, THE NEW PLANTINGS MUST BE WATERED. LAWNS, TREES, AND SHRUBS WATERING SHALL OCCUR AT A MINIMUM OF TWO (2) TIMES A DAY FOR THE FIRST TWO (2) MONTHS; ONCE IN THE EARLY MORNING AND THEN THE OTHER IN THE LATE AFTERNOON. IN GENERAL TEN GALLONS OF WATER APPLIED TWICE A WEEK WILL WET A 20"-24" ROOT BALL AND PROVIDE THE EQUIVALENT OF ONE INCH OF RAIN FALL. NEW LAWNS SHALL BE WATERED SO THAT IS RECEIVES AT A MINIMUM ONE INCH (1") OF WATER EVERY WEEK.

19. WITHIN THE LANDSCAPE BEDS ADJACENT TO THE BUILDING FOUNDATIONS, NO (HEMLOCK, PINE, SPRUCE, OR CEDAR) MULCH OR OTHER COMBUSTIBLE LANDSCAPE MATERIALS SHALL BE INSTALLED WITHIN 18" OF THE FOUNDATION.


20. ALL LANDSCAPE BEDS SHALL RECEIVE THREE-INCHES OF BARK MULCH. 21. LANDSCAPE AREAS SHALL BE DEEP TILLED TO A DEPTH OF TWELVE INCHES TO FACILITATE DEEP WATER PENETRATION.

<u>Planting Schedule</u> Botanical Name Qty.|Key |Common Name |Size | Remarks 3" Cal. B&B BL Black Birch Betula lenta 3" Cal. B&B Singlestem PR Serviceberry Amelanchier canadensis 7 PS 'Hoopsil' Blue Spruce Picea pungens 'Hoopsii' 8′ Ht. | B&B 6 QA White Oak 3" Cal. B&B Quercus alba 4 QP 'Green Pillar' Oak Quercus palustris 'Green Pillar' 3" Cal. B&B □* 15 SA Red Maple 3" Cal. B&B Acer rubrum 15 SO Scarlet Oak Quercus Coccinea 3" Cal. B&B SHRUBS k 7 CA Sweet Pepper Bush Clethra alnifolia 24" Ht. B&E 46 CR Gray Stem Dogwood Cornus racemosa CS Smoke bush 18" Ht. B&B Cotinus coggygria 6 HP Golden Cup St. John's Wort 24" Ht. B&B Hypericum Hidcote 2 HR 'Blue chiffon' Hibiscus 48" Ht. B&B Hibiscus syriacus 'Rose Satin' 36" Ht. B&B HV Common Witch Hazel Hamamelis virginiana 6 IS 'Sky Pencil' Holly 4" Ht. B&B llex crenata 'Sky Pencil' 33 IV Winterberry 24" Ht. B&B llex vertillata 15 LB Northern Spicebush 48" Ht. B&B Lindera Benzoin Myrica pensylvanica 36" Ht. B&B MP Northern Bayberry RM 'Knock-Out' Rose 36" Ht. B&B Rosa sp. 'Knock-Out 24" Ht. B&B 6 SA 'Flamingo' Japanese Willow Salix integra 'Flamingo' 3 SY 'Bloomerang' Lilac 36" Ht. B&B Syringa x Bloomerang 36" Ht. B&B Vaccinium corymbosum 6 VR Northern Arrowwood 36" Ht. B&B Viburnum recognitum

Pennisetum alopecuroides 'Hameln'

* WETLAND BUFFER PLANTINGS WETLAND REPLICATION PLANTINGS

'Hameln' Fountain Grass

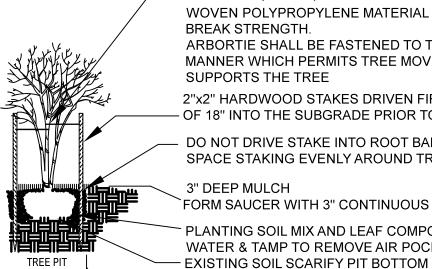

ARBORTIE (GREEN) GUYING MATERIAL IS TO BE FLAT WOVEN POLYPROPYLENE MATERIAL ³/₄" WIDE, 900 LB. BREAK STRENGTH. ARBORTIE SHALL BE FASTENED TO TREE STAKES IN A MANNER WHICH PERMITS TREE MOVEMENT (8" SWAY) AND

SUPPORTS THE TREE 2"x2" HARDWOOD STAKES DRIVEN FIRMLY A MINIMUM OF 18" INTO THE SUBGRADE PRIOR TO BACKFILLING.

DO NOT DRIVE STAKE INTO ROOT BALL

SPACE STAKING EVENLY AROUND TREE.

3" DEEP MULCH

FORM SAUCER WITH 3" CONTINUOUS RIM. PLANTING SOIL MIX AND LEAF COMPOST WATER & TAMP TO REMOVE AIR POCKETS

1. STAKE TO MAIN BRANCHES AS NECESSARY FOR FIRM SUPPORT 2. PLANT SO THAT TOP OF ROOT BALL IS EVEN WITH THE FINISHED

3. GUY WIRE SHALL NOT TOUCH OR RUB ADJACENT TRUNKS OR

4. REMOVE ALL CONTAINERS AND BASKETS FROM ROOT BALL. 5. REMOVE BURLAP FROM TOP ONE THIRD OF ROOT BALL. 6. LOOSEN ROOTBALL PRIOR TO PLANTING.

<u>DECIDUOUS TREE PLANTING</u> NOT TO SCALE

FOR PERMITTING ONLY: NOT FOR CONSTRUCTION

GRAPHIC SCALE



#3 Pot Container Grown





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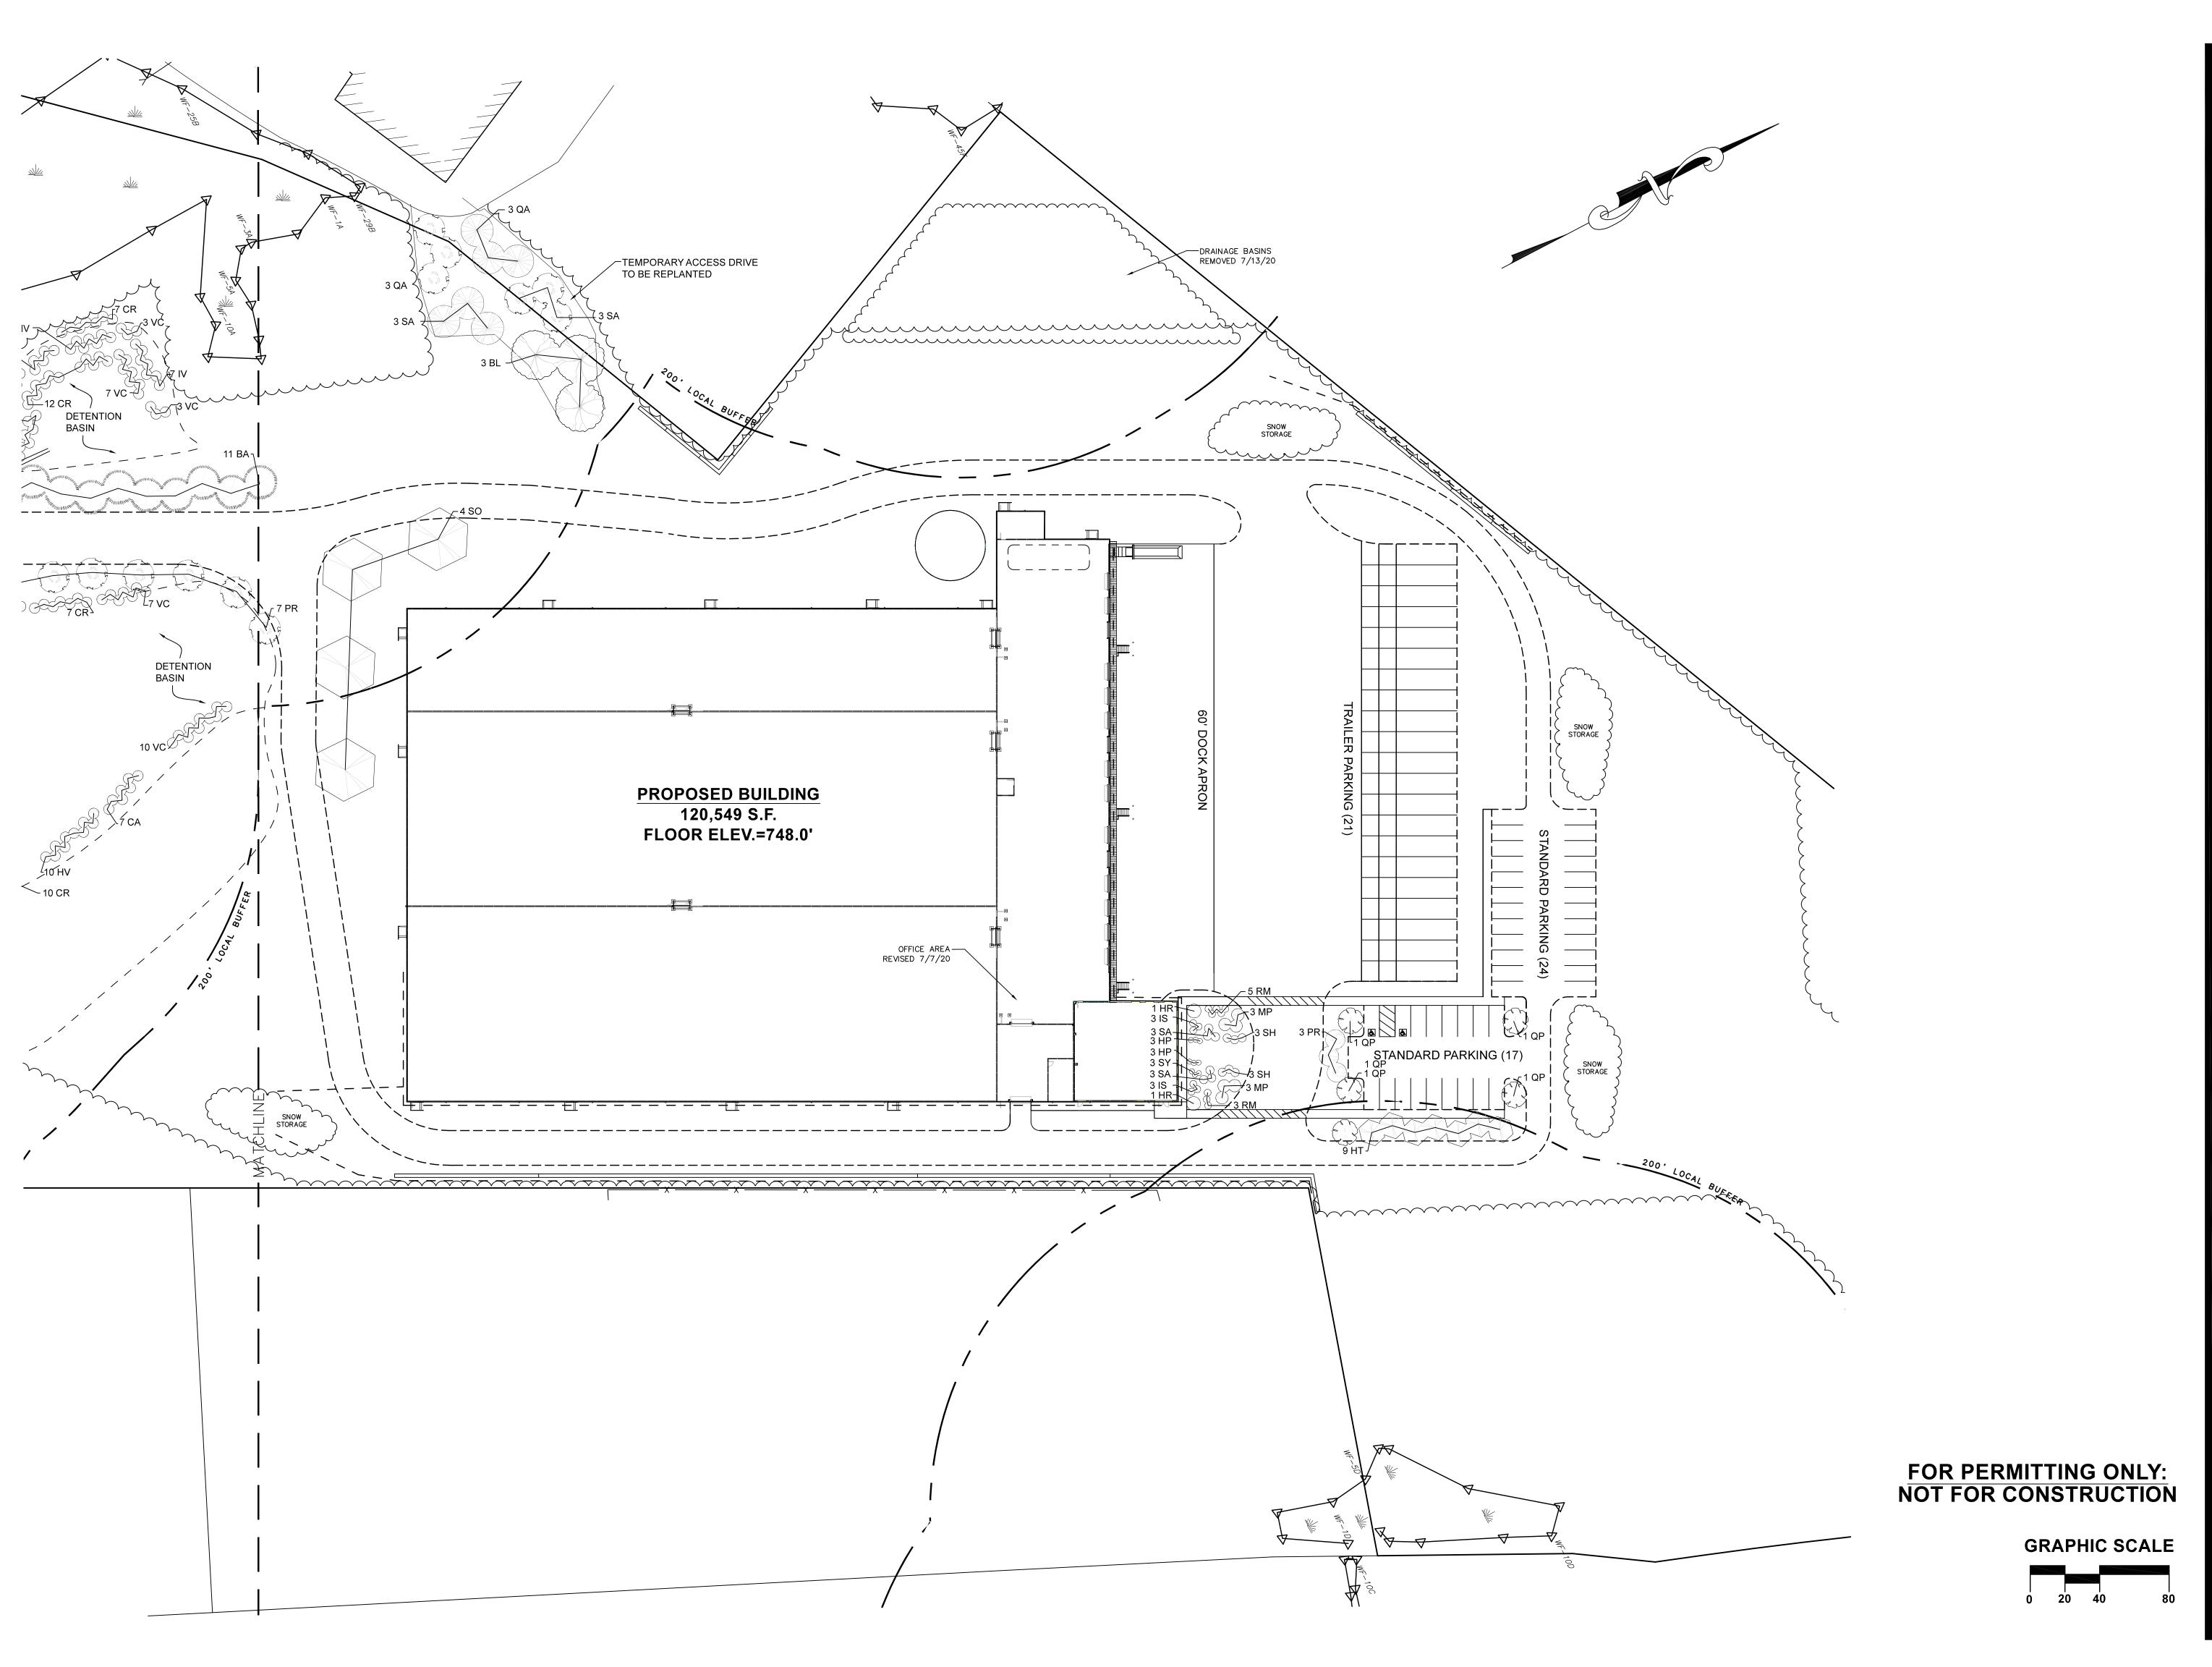
LANDSCAPE

8/1/20 - PER CONSERVATION COMMISSION COMMENTS 17/20 - SITE LAYOUT RE-DESIGN

REVISIONS

SCALE: 1" = 40' MAY 12, 2020 20-122 PLAN NO:

20-122 DEFINITIVE SITE PLAN 16 OF 24 SHEET NO:











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NEW ENGLAND COLD STORAGE, LLC.

6 PICKER ROAD STURBRIDGE, MA


LANDSCAPE


6/1/20 - PER CONSERVATION COMMISSION COMMENTS 17/20 - SITE LAYOUT RE-DESIGN

REVISIONS

1" = 40' MAY 12, 2020 20-122

20-122 DEFINITIVE SITE PLAN 17 OF 24

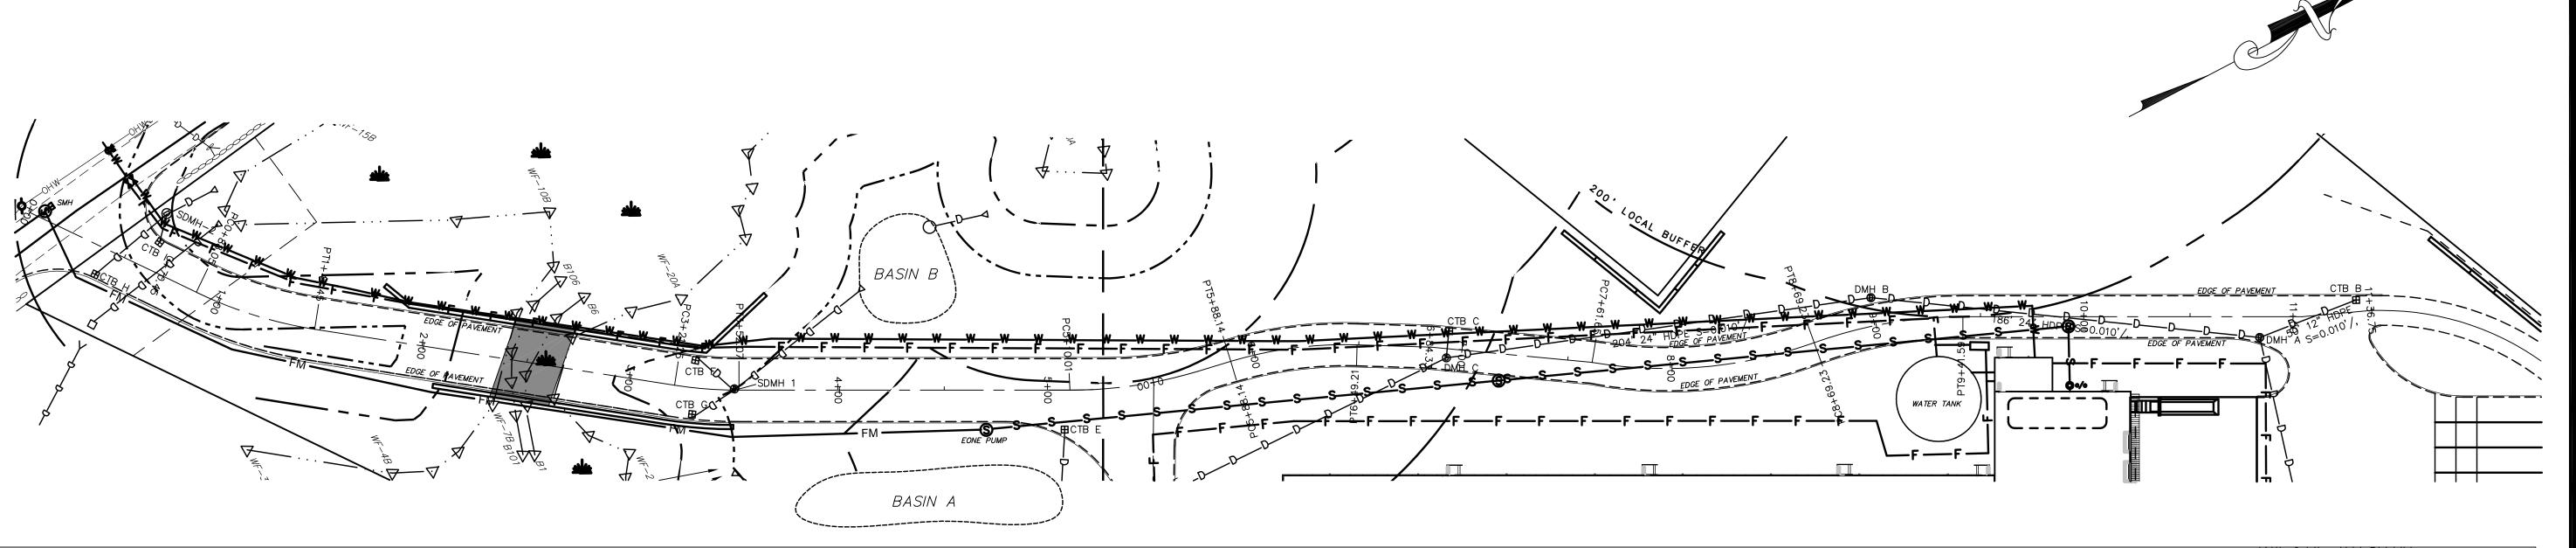

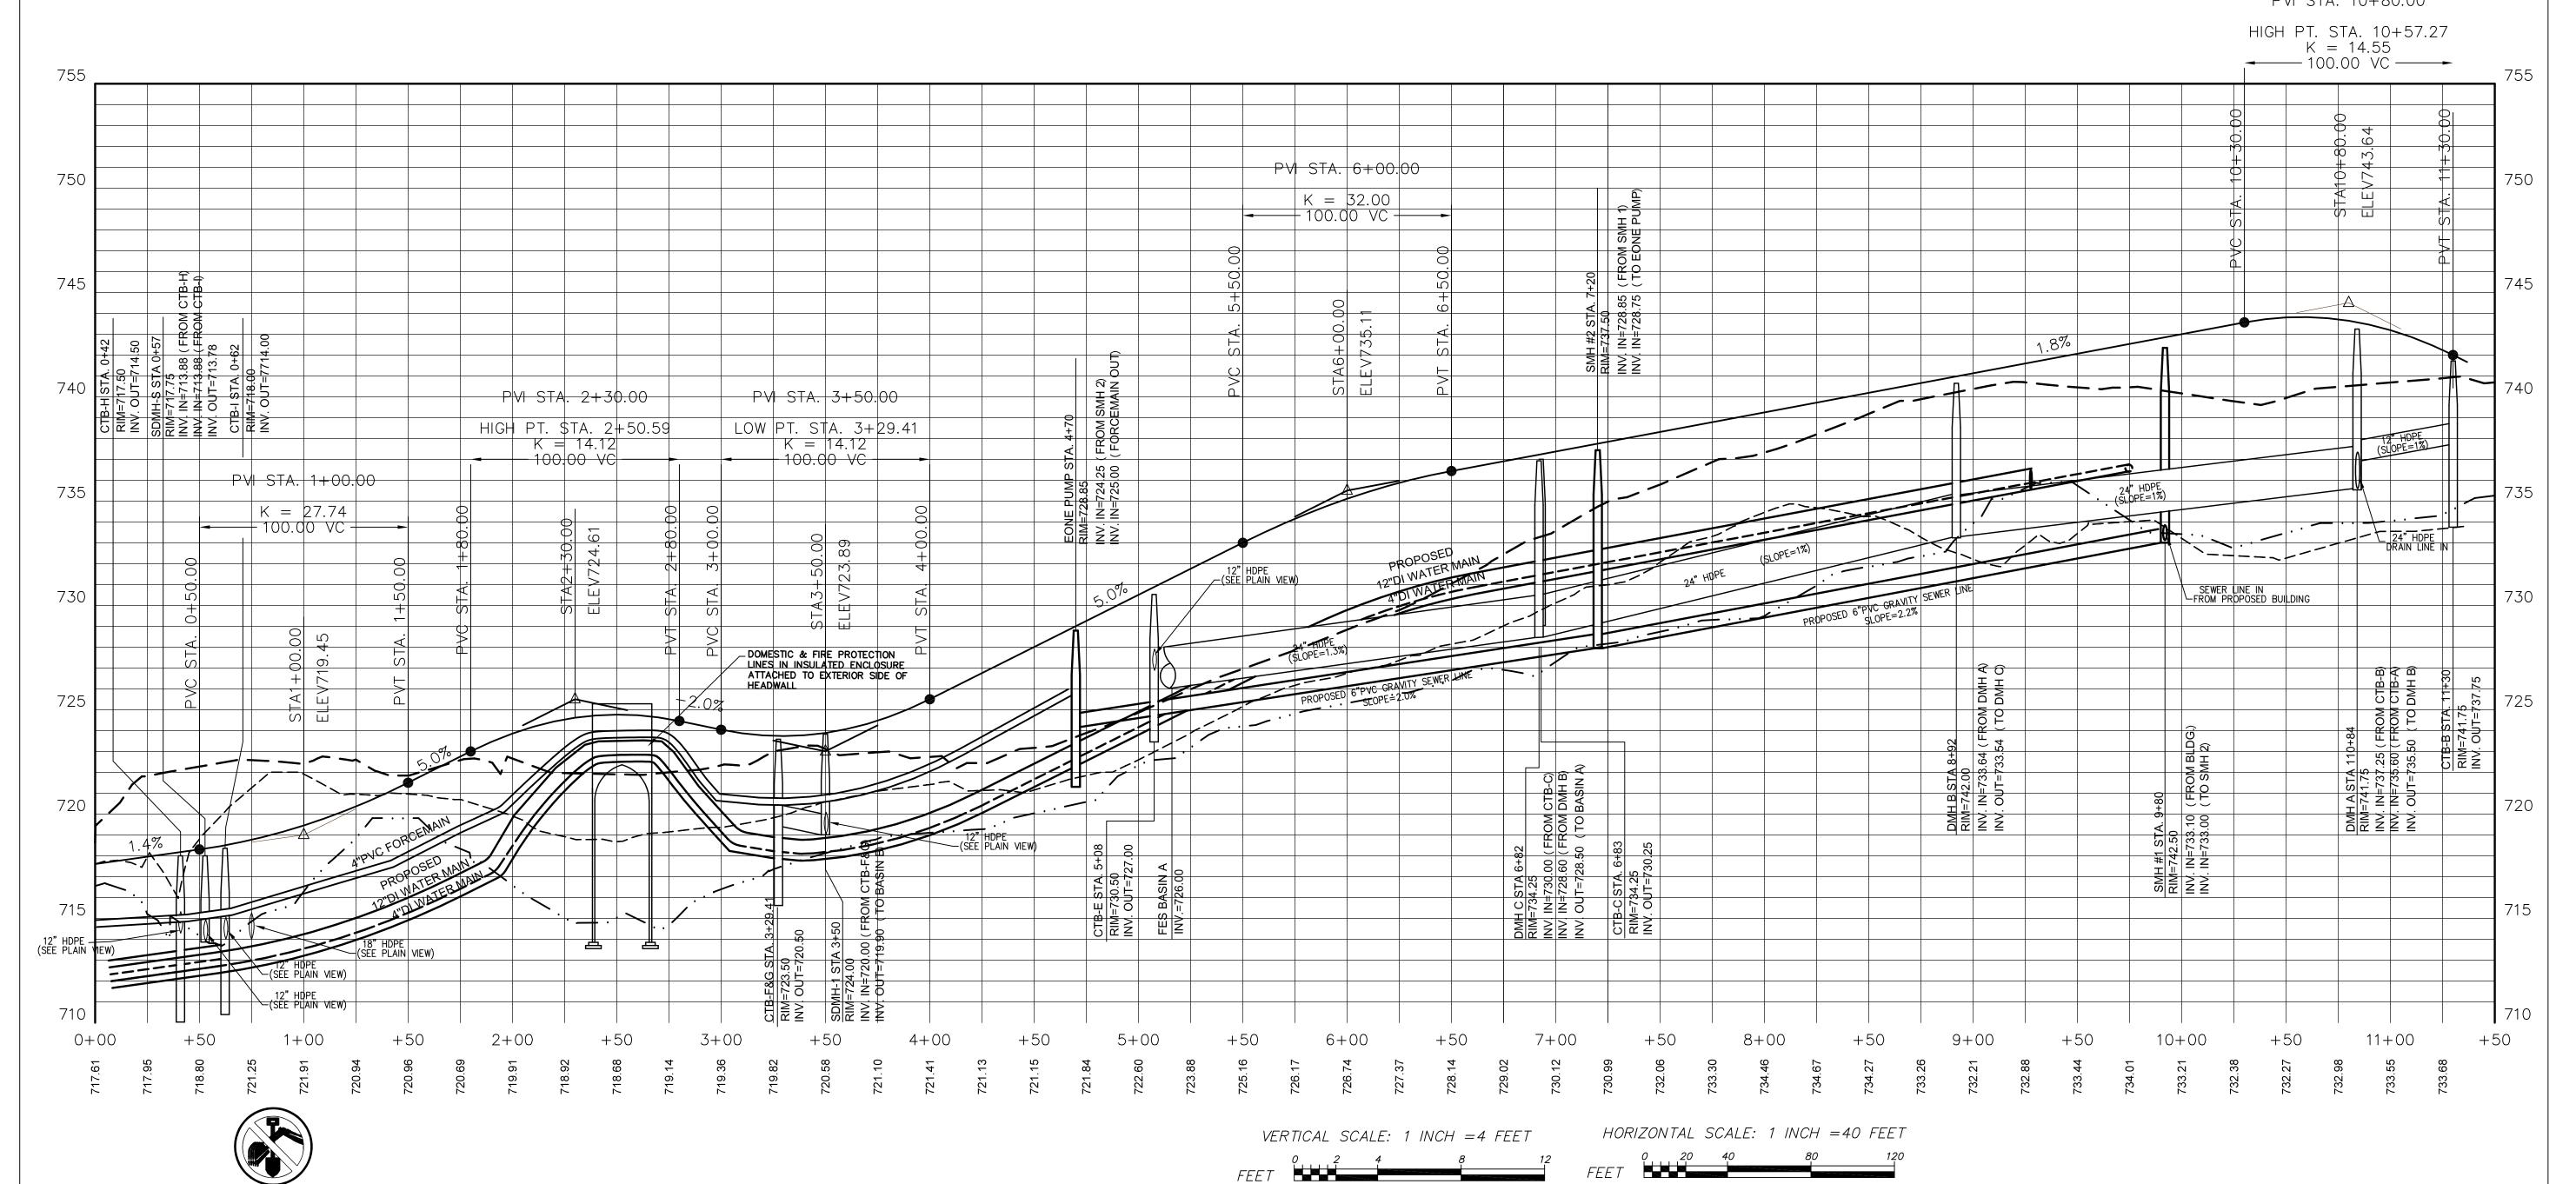

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6 PICKER ROAD STURBRIDGE, MA

PROFILE


7/?/20 - SITE LAYOUT RE-DESIGN


6/1/20 - PER CONSERVATION COMMISSION COMMENTS REVISIONS

SCALE: DATE:

1" = 40' MAY 12, 2020

20-122 JOB NO: 20-122 DEFINITIVE SITE PLAN PLAN NO: SHEET NO:

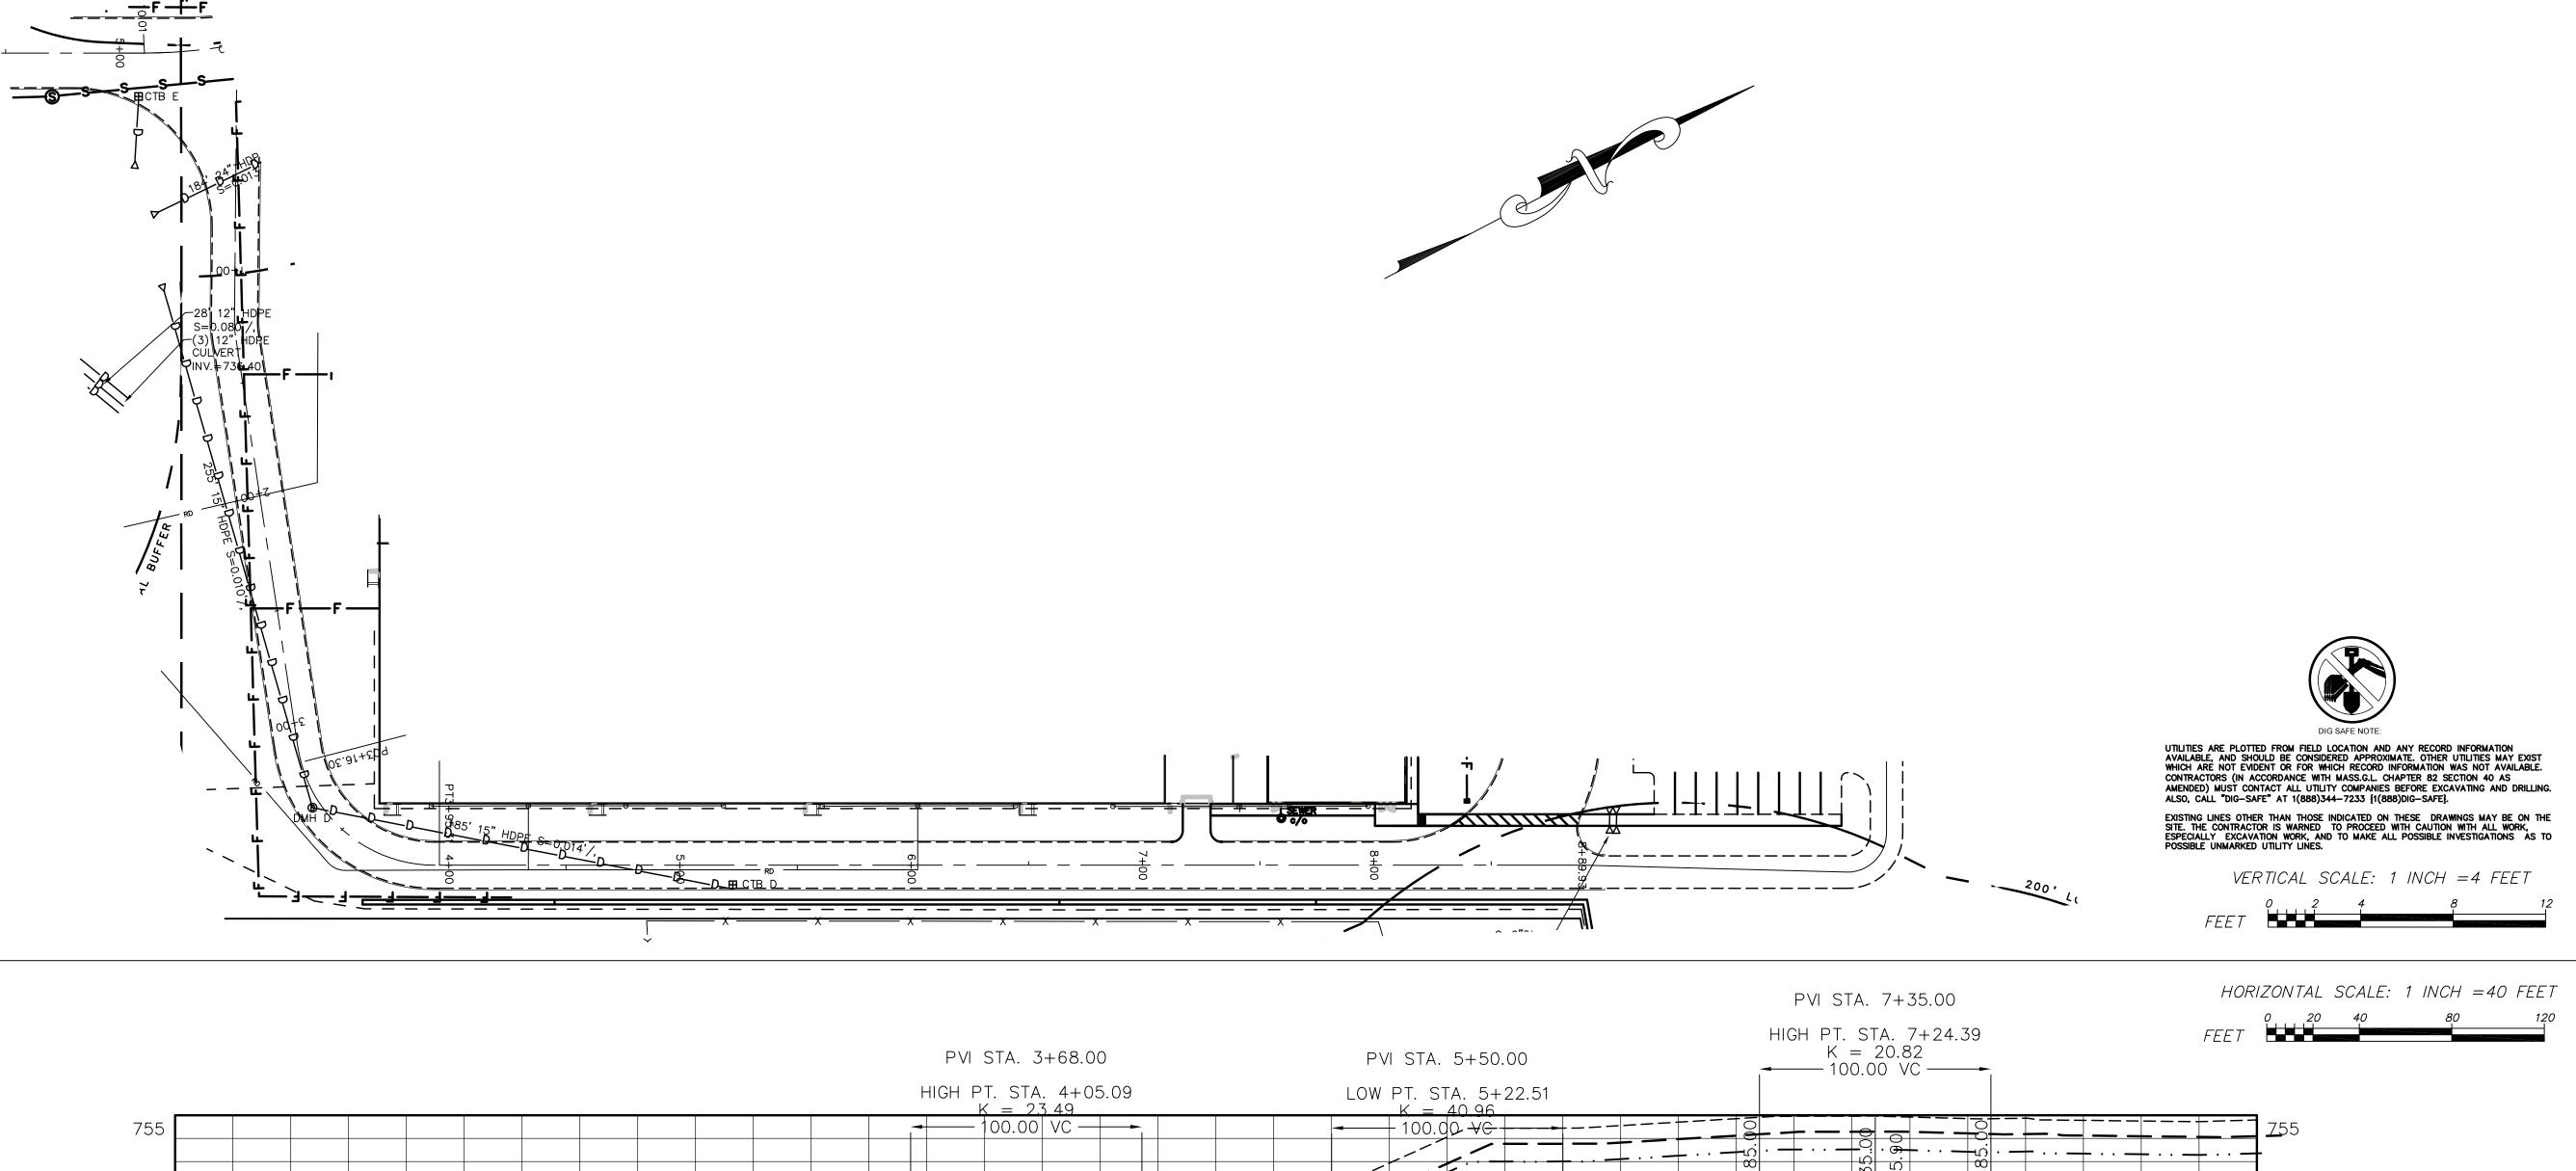

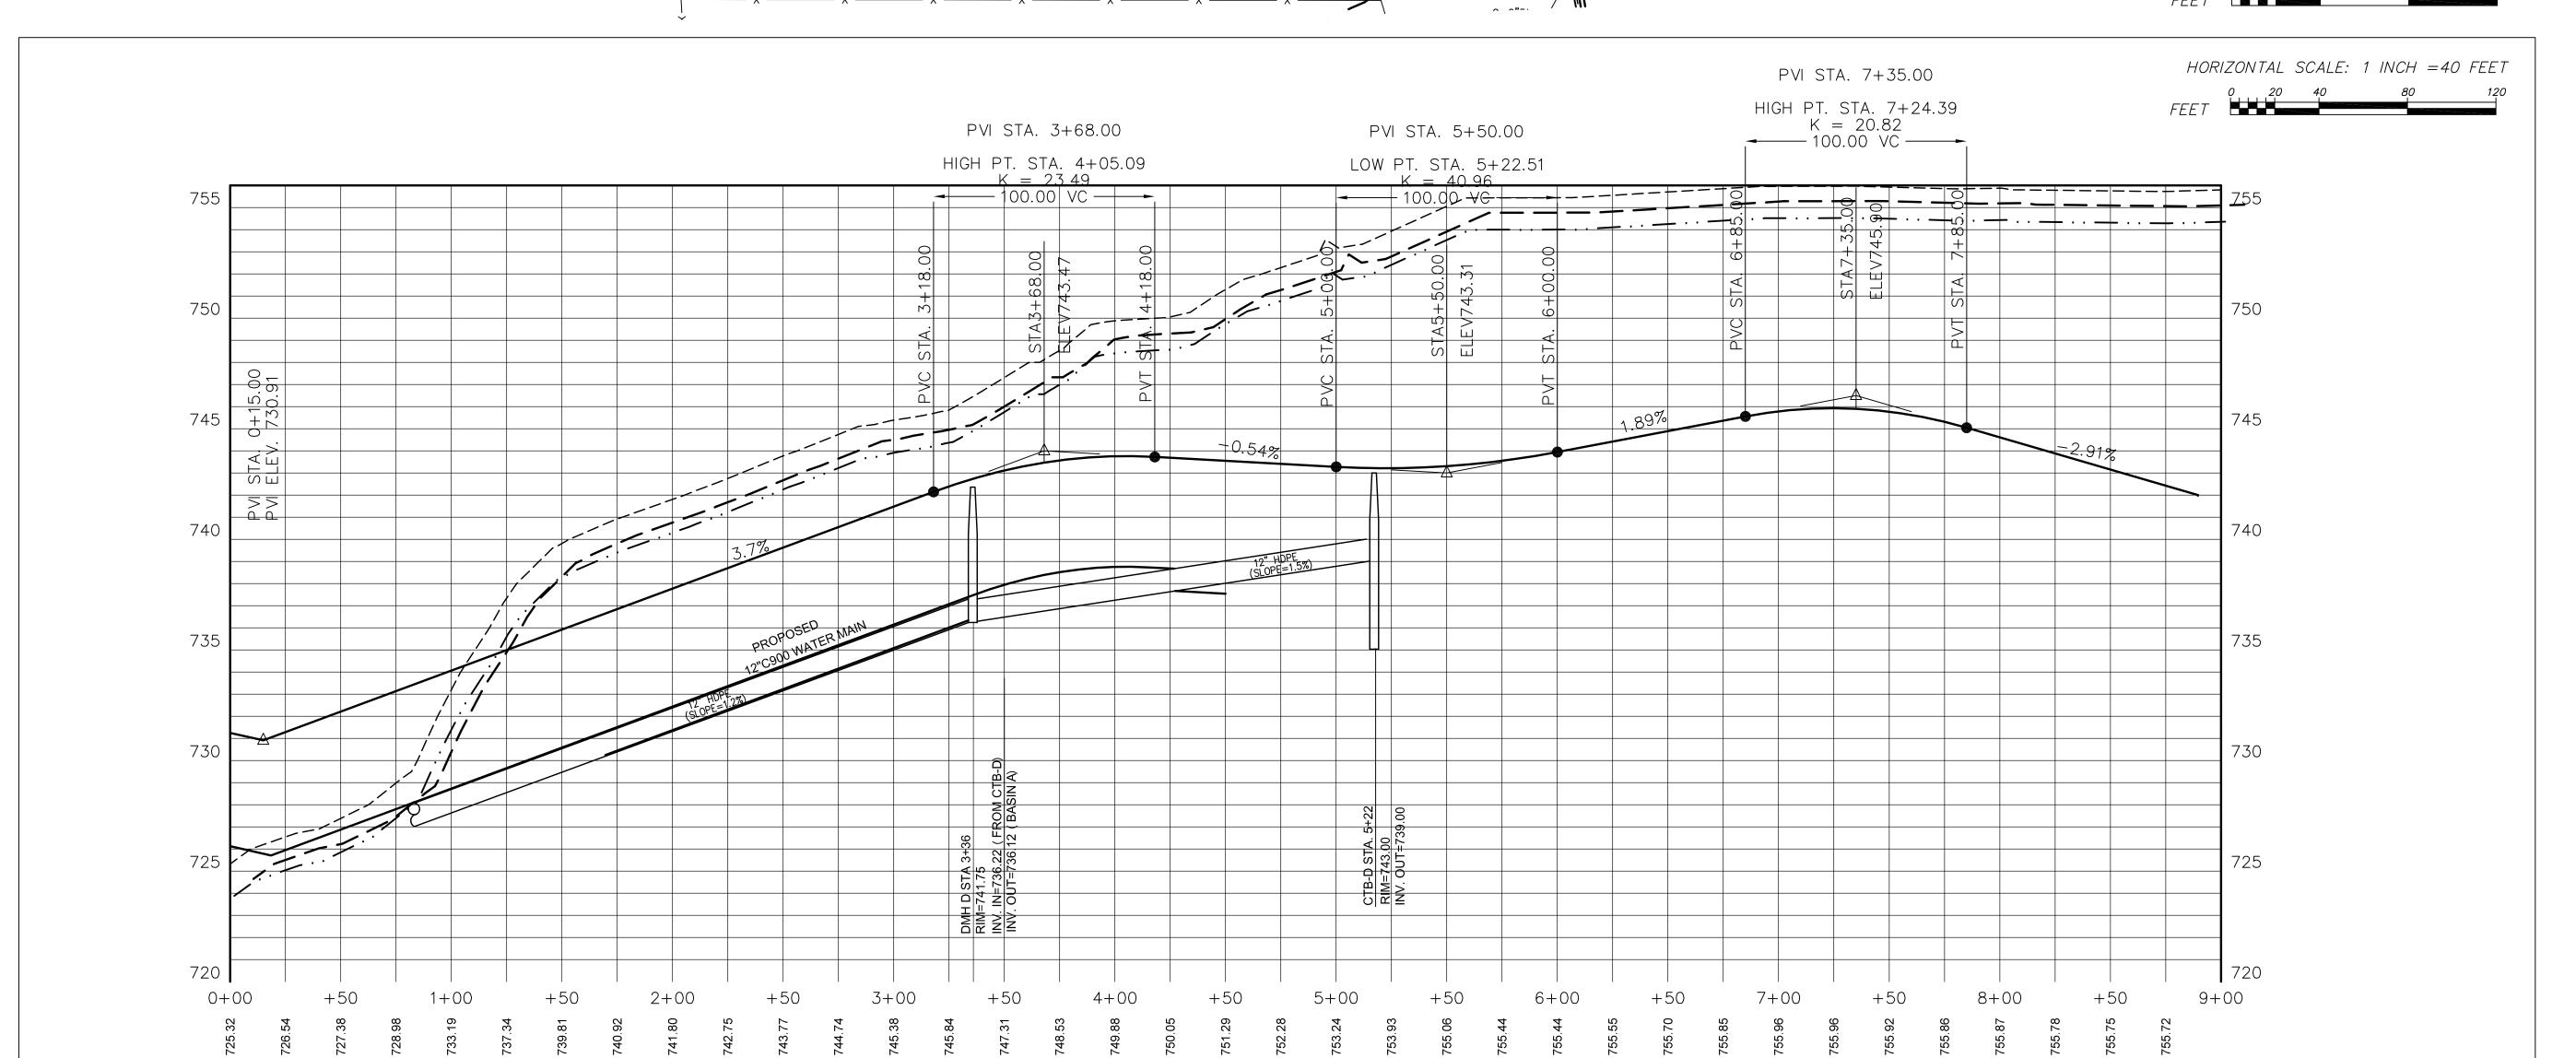









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NEW ENGLAND COLD STORAGE, LLC.

> 6 PICKER ROAD STURBRIDGE, MA

PROFILE

7/17/20 - SITE LAYOUT RE-DESIGN
6/1/20 - PER CONSERVATION COMMISSION COMMENTS
REVISIONS

REVISIONS

SCALE: 1" = 40'

MAY 12.5

PLAN NO:

1" = 40'
MAY 12, 2020
20-122
20-122 DEFINITIVE SITE PLAN

FOR PERMITTING ONLY:
NOT FOR CONSTRUCTION

PRELIMINARY SITE WORK:

1. MATERIAL REMOVED SHOULD BE STOCKPILED, SEPARATING THE TOPSOIL FOR FUTURE USE ON THE SITE. EROSION CONTROLS SHALL BE UTILIZED ALONG THE DOWNSLOPE SIDE OF THE PILES IF THE PILES ARE TO REMAIN MORE THAN THREE WEEKS OR SUBJECT TO EROSIVE CONDITIONS SUCH AS INTENSE RAIN. WIND OR OTHER EXPOSURE.

2. STOCKPILES SHALL BE LOCATED AS SPECIFIED HEREIN AND AS REQUIRED. SHOULD ADDITIONAL AREAS BE NEEDED THEY SHALL BE LOCATED WITHIN THE LIMITS OF DISTURBANCE, IN AREAS OF MINIMAL IMPACT. IF A STOCKPILE IS LOCATED ON A SLOPE, THE RUNOFF SHALL BE DIRECTED AWAY FROM THE PILE.

3. IF INTENSE RAINFALL IS ANTICIPATED, THE INSTALLATION OF SUPPLEMENTAL HAYBALE DIKES, SILT FENCES, OR ARMORED DIKES SHALL BE UTILIZED.

4. IF THE SITE CONSTRUCTION OCCURS AT ANY TIME OTHER THAN THE MAY -NOVEMBER CONSTRUCTION SEASON, THE SITE DRAINAGE SYSTEM SHALL BE INSTALLED, MAINTAINING HYDRAULIC CAPACITY, PRIOR TO ANY ROUGH GRADING IN THE BUFFER

INSTALLATION OF UTILITIES:

. CARE SHALL BE TAKEN TO ASSURE THAT THE UTILITY TRENCHES DO NOT CHANNELIZE RUNOFF TOWARDS EXISTING STREETS OR OTHER OFF-SITE AREAS.

ACCORDANCE WITH THE APPLICABLE UTILITY COMPANY SPECIFICATIONS.

2. THE INSTALLATION OF SUBSURFACE UTILITIES AND APPURTENANCES SHALL BE IN

TRENCH EXCAVATIONS SHALL BE LIMITED TO THE MINIMUM LENGTH REQUIRED FOR DAILY UTILITY INSTALLATION. ALL TRENCHES SHALL BE BACKFILLED AS SOON AS

LANDSCAPING:

LANDSCAPING SHALL OCCUR AS SOON AS POSSIBLE TO PROVIDE PERMANENT STABILIZATION OF DISTURBED SURFACES.

2. CONTRACTOR SHALL UTILIZE A VARIETY OF SLOPE STABILIZATION METHODS AND MATERIALS WHICH SHALL BE ADJUSTED TO THE SITE CONDITIONS. EROSION CONTROL BLANKETS OR MIRAFI MIRAMAT (OR SIMILAR PRODUCTS) SHALL BE AVAILABLE ON SITE.

3. IF THE SEASON OR ADVERSE WEATHER CONDITIONS DO NOT ALLOW THE ESTABLISHMENT OF VEGETATION, TEMPORARY MULCHING WITH HAY, TACKIFIED WOOD CHIPS OR OTHER METHODS SHALL BE PROVIDED.

4. A MINIMUM OF 6" TOPSOIL SHALL BE PLACED AND ITS SURFACE SMOOTHED TO THE SPECIFIED GRADES.

5. SEED APPLICATIONS SHALL BE IN ACCORDANCE WITH THE GRASS AND SLOPE COVER

PRE-CONSTRUCTION:

AN EROSION CONTROL BARRIER (SEE SHEET 4) SHALL BE INSTALLED AS DEPICTED ON THE SITE PLAN, BETWEEN THE AREAS TO BE DISTURBED AND WETLAND AREAS. THIS BARRIER SHALL REMAIN IN PLACE UNTIL ALL TRIBUTARY SURFACES HAVE BEEN FULLY STABILIZED. THE EROSION CONTROL BARRIERS AS SHOWN ON THE SITE PLAN ARE THE MINIMUM REQUIRED TO PROTECT THE ON & OFF SITE DRAINAGE SYSTEMS.

PHOTOGRAPHS AND/OR VIDEO IMAGES OF THE PRE-CONSTRUCTION CONDITION OF THE SITE AND SURROUNDING AREAS, ESPECIALLY THE ADJACENT STREETS SHALL BE TAKEN, DEVELOPED AND DATED. A COPY OF THESE MATERIALS SHALL BE SUBMITTED TO THE COMMISSION AND OWNER FOR THEIR FILES. THESE PICTURES AND IMAGES SHALL REFERENCE EXISTING SITE CONDITIONS AND PERMANENT REFERENCE MARKS TO ENABLE RECOGNITION OF THE AREA BEING PHOTOGRAPHED, AND SHALL REPRESENT A COMPREHENSIVE VIEW OF THE SITE PRIOR TO DEVELOPMENT.

3. THE CONTRACTOR SHALL ESTABLISH A STAGING AREA ON A PORTION OF THE AREA TO BE DISTURBED FOR THE OVERNIGHT STORAGE OF EQUIPMENT AND STOCKPILING OF MATERIALS. THE STAGING AREA SHALL BE OUTSIDE OF THE 100' WETLANDS BUFFER ZONE.

4. IN THE STAGING AREA, THE CONTRACTOR SHALL HAVE A STOCKPILE OF MATERIALS REQUIRED TO CONTROL EROSION ON-SITE TO BE USED TO SUPPLEMENT OR REPAIR EROSION CONTROL DEVICES. THESE MATERIALS SHALL INCLUDE, BUT ARE NOT LIMITED TO: HAYBALES, SILT FENCE AND CRUSHED STONE.

OF SILT, MUD, ETC. ONTO EXISTING ROADS. THE STONE SHALL BE REPLACED REGULARLY AS WELL AS WHEN THE STONE IS SILT LADEN OR EQUIPMENT IS OBSERVED TO BE TRACKING SOIL ONTO THE ROADWAYS.

5. A TEMPORARY STONE CONSTRUCTION ENTRANCE IS REQUIRED TO PREVENT TRACKING

6. THE CONTRACTOR IS RESPONSIBLE FOR EROSION CONTROL ON SITE AND SHALL UTILIZE EROSION CONTROL MEASURES WHERE NEEDED, REGARDLESS OF WHETHER THE MEASURES ARE SPECIFIED HEREIN, ON THE PLAN OR IN ANY ORDER OF CONDITIONS.

GENERAL CONSTRUCTION REQUIREMENTS:

ANY REFUELING OF CONSTRUCTION VEHICLES AND EQUIPMENT SHALL TAKE PLACE OUTSIDE OF THE 100 FOOT BUFFER ZONE TO THE ENTRANCE TO THE DRAINAGE SYSTEM AND SHALL NOT BE CONDUCTED IN PROXIMITY TO SEDIMENTATION BASINS OR DIVERSION

2. NO ON-SITE DISPOSAL OF SOLID WASTE, INCLUDING BUILDING MATERIALS IS ALLOWED IN THE 100 FOOT BUFFER ZONE. THE BURIAL OF STUMPS, CONSTRUCTION DEBRIS OR OTHER MATERIALS SHALL NOT BE ALLOWED ANYWHERE ON-SITE.

3. NO MATERIALS SHALL BE DISPOSED OF INTO THE WETLANDS OR EXISTING OR PROPOSED DRAINAGE SYSTEMS. ALL CONTRACTORS INCLUDING: CONCRETE SUPPLIERS. PAINTERS AND PLASTERERS, SHALL BE INFORMED THAT THE CLEANING OF EQUIPMENT IS PROHIBITED IN AREAS WHERE THE WASH—WATER WILL DRAIN DIRECTLY TO THE SITE

4. CONTRACTOR IS RESPONSIBLE FOR DUST CONTROL WHICH SHALL INCLUDE STREET SWEEPING OF ALL PAVED SURFACES WITHIN THE SITE AND OFF-SITE AREAS THAT ARE IMPACTED BY SITE CONSTRUCTION ON A REGULAR BASIS, AS NEEDED.

RADIUS FLARED END

-1/2" CRUSHED STONE

-ROADWAY WIDTH - 30'

AS A MINIMUM REQUIREMENT.

NON SENSITIVE AREA ON-SITE.

2. DISPOSE OF STONE & ENTRAPPED MATERIALS IN A

4. ALL TRAFFIC ENTERING / EXISTING SITE TO CROSS

5. USE MIRAFI 700X FILTER FABRIC OR APPROVED EQUAL

EMPORARY CONSTRUCTION ENTRANCE

3. DO NOT REUSE STONE FOR SAME PURPOSE.

BENEATH STONE ON CONSTRUCTION ENTRANCE.

NOT TO SCALE

TEMPORARY CONSTRUCTION ENTRANCE

CONSTRUCTION NOTES

1.) ALL MATERIALS AND CONSTRUCTION PRACTICES SHALL BE IN CONFORMANCE WITH THE LATEST EDITION OF THE MASSACHUSETTS DEPARTMENT OF PUBLIC WORKS (MDPW) CONSTRUCTION STANDARDS AND THE MDPW "STANDARD SPECIFICATIONS FOR HIGHWAYS AND BRIDGES", UNLESS OTHERWISE SPECIFIED BY LOCAL AUTHORITY OR THE ENGINEER.

2.) THE CONTRACTOR SHALL UTILIZE ALL MEASURES AND MATERIALS NECESSARY TO ENSURE THE SAFETY OF ALL PERSONS AND PROPERTIES AT THE SITE DURING CONSTRUCTION. ALL EXCAVATIONS SHALL CONFORM TO CURRENT OSHA STANDARDS.

3.) UNLESS OTHERWISE NOTED, ALL DISTURBED AREAS SHALL BE DRESSED WITH A MINIMUM OF FOUR INCHES (4") OF LOAM AND SHALL BE SEEDED WITH AN APPROVED GRASS MIX.

4.) THE CONTRACTOR SHALL PROVIDE APPROPRIATE EROSION AND SEDIMENTATION CONTROL MEASURES AT ALL TIMES. DEWATERING OPERATIONS SHALL BE PROVIDED, IF REQUIRED; ALL DISCHARGE SHALL PASS THROUGH SEDIMENTATION CONTROL DEVICES TO PREVENT IMPACTS UPON WATER BODIES, BORDERING VEGETATED WETLANDS, DRAINAGE SYSTEMS AND ABUTTING PROPERTIES.

5.) NO MATERIALS SUBJECT TO EROSION SHALL BE STOCKPILED OVERNIGHT WITHIN 100 FEET OF A CATCH BASIN. ALL MATERIALS STOCKPILED WITHIN 100 FEET OF A CATCH BASIN, SHALL BE RELOCATED, MULCHED OR OTHERWISE TREATED TO INSURE THAT THE MATERIALS ARE NOT CARRIED TO THE CATCH BASIN.

6.) DISTURBED AREAS SHALL BE STABILIZED BY LOAMING AND SEEDING SOON AFTER THE FINISHED GRADE HAS BEEN MET. IF FINAL GRADING DOES NOT OCCUR DURING THE GROWING SEASON, THESE AREAS SHALL BE MULCHED WITH HAY SECURED BY WEIGHTED SNOW FENCE, CHICKEN WIRE MESH OR JUTE NETTING WITH STAPLES. SEED FOR PERMANENT GRASS COVER SHOULD BE ACCORDING TO SOIL CONSERVATION SERVICE GUIDELINES FOR SOIL AND MOISTURE CONDITIONS FOUND ON THE SITE.

7.) SEDIMENTATION CONTROL FENCE AND/OR HAY BALES SHALL BE MAINTAINED UNTIL ALL SLOPES HAVE BEEN STABILIZED AND THERE IS NO DANGER OF EROSION OUTSIDE OF THE PROPERTY.

8.) PRIOR TO INITIATING CONSTRUCTION, SEDIMENTATION CONTROL DEVICES SHALL BE INSTALLED AS SHOWN ON THE PLANS. THE CONTRACTOR SHALL MAINTAIN THE DEVICES UNTIL ALL WORK IS COMPLETE AND ALL AREAS HAVE BEEN STABILIZED.

9.) ACCUMULATED SEDIMENT SHALL BE REMOVED AND DISPOSED OF BY THE CONTRACTOR AS REQUIRED BY THE CONSERVATION COMMISSION OR AS DIRECTED BY THE

10.) THE FUNCTIONING OF TEMPORARY CULVERTS, DITCHES, SWALES, OR CONSTRUCTION OPERATIONS SHALL NOT CAUSE NOTICEABLE SEDIMENTATION PLUMES. IF PLUMES OCCUR, THE CONTRACTOR SHALL STOP WORK AND INSTALL ADDITIONAL SEDIMENTATION CONTROL DEVICES IMMEDIATELY TO PREVENT FURTHER SEDIMENTATION.

11.) IT SHALL BE THE RESPONSIBILITY OF THE CONTRACTOR TO COORDINATE HIS WORK WITH THE APPROPRIATE HIGHWAY AND UTILITY DEPARTMENTS. CONTRACTOR SHALL MAINTAIN ALL EXISTING AND NEWLY INSTALLED UTILITIES IN GOOD WORKING ORDER AND SHALL PROTECT THEM FROM DAMAGE AT ALL TIMES UNTIL THE WORK IS COMPLETED AND ACCEPTED.

12.) THE CONTRACTOR SHALL PROVIDE FOR ALL TRAFFIC CONTROL IN ACCORDANCE WITH THE TOWN OF STURBRIDGE REQUIREMENTS.

13.) NO TRENCHES SHALL BE ALLOWED TO REMAIN OPEN OVERNIGHT.

14.) ALL POTABLE WATER AND SANITARY BUILDING SERVICE CONNECTIONS SHALL BE SEPARATED HORIZONTALLY BY A MINIMUM OF TEN FEET.

15.) ALL REQUIRED PERMITS SHALL BE SECURED PRIOR TO COMMENCING WORK, INCLUDING ANY NECESSARY TRENCH PERMITS.

16.) ALL PROPOSED FENCING TO BE INSTALLED ALONG THE PROPERTY LINE UNLESS OTHERWISE DESIGNATED. ALL FENCING ALONG PROPERTY LINES SHALL NOT EXCEED 6 FEET IN HEIGHT

17.) ALL PROPOSED LIGHTING TO BE LESS THAN 20' HIGH & HAVE DOWN-SHADES TO PREVENT LIGHT SPILLOVER. THERE SHALL BE NO MORE THAN ONE-FOOT CANDLE OF SPILLOVER ONTO RESIDENTIAL ABUTTING PROPERTIES.

18.) PROPERTY OWNER SHALL MAINTAIN LANDSCAPING ELEMENTS DURING & AFTER CONSTRUCTION.

19.) ALL PAVING ELEMENTS SHALL BE IN CONFORMANCE WITH THE TOWN OF STURBRIDGE DPW REQUIREMENTS.

20.) EXISTING TREES THAT ARE GREATER THAN 9" CALIBER ARE INDICATED ON THE SITE PLAN SET.

21.) THE OWNER OF THE PROPERTY SHALL BE RESPONSIBLE FOR MAINTAINING THE HEALTH AND VISUAL APPEAL OF ALL LANDSCAPING ELEMENTS AFTER CONSTRUCTION.

22.) EXCESS SNOW SHALL BE TRUCKED OFF OF THE SITE ONCE THE AMOUNT WITHIN THE SNOW STORAGE AREA BEGINS TO IMPEDE ACCESS TO THE REQUIRED PARKING SPACES OR ONCE SIGHT LINE ACCESS IS IMPEDED FROM ANY DIRECTION.

23). NO EXISTING VEGETATION SHALL BE RETAINED UNLESS ITEMIZED ON PLANS. SEE LANDSCAPING PLAN/TABLE FOR GUIDANCE.

PLAN VIEW

GRADE TO

DIRECT FLOW

PROFILE VIEW

FLOW DIRECTION

TO BASIN _

10'X5' +

BASIN

1/2" - 3/4"-

NOTE: LINES OF COMPSOITE SOCK TO BE PERPENDICULAR TO RUNOFF

STONE

2X10 SET LEVEL

TEMPORARY DEWATERING AREA

1"x1"x24" STAKE


COMPOSITE


STAKE DEPTH — 1' MIN.


NOT TO SCALE

LARGE STONES -STAKED HAYBALE

TO HOLD 2X10 / BAFFLE

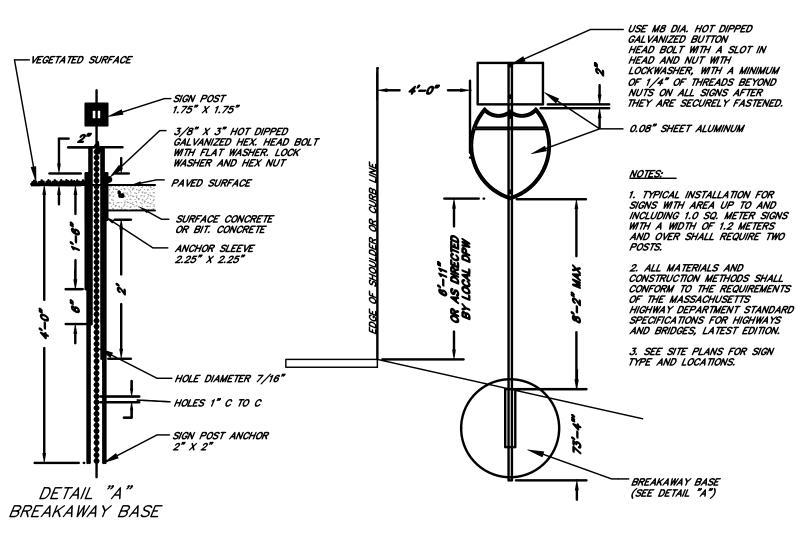

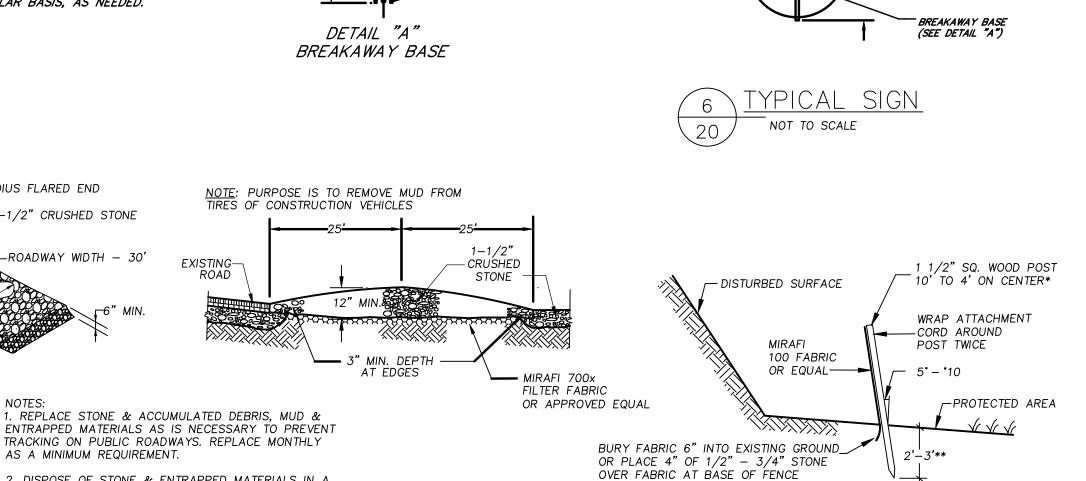


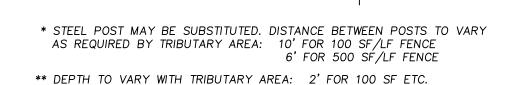

IF POST IS TO BE SET IN PEAT OR UNSTABLE SOILS, THEN 3' OR DEPTH

NECESSARY TO PROVIDE A STABLE POST FOR LOADED FENCE CONDITIONS



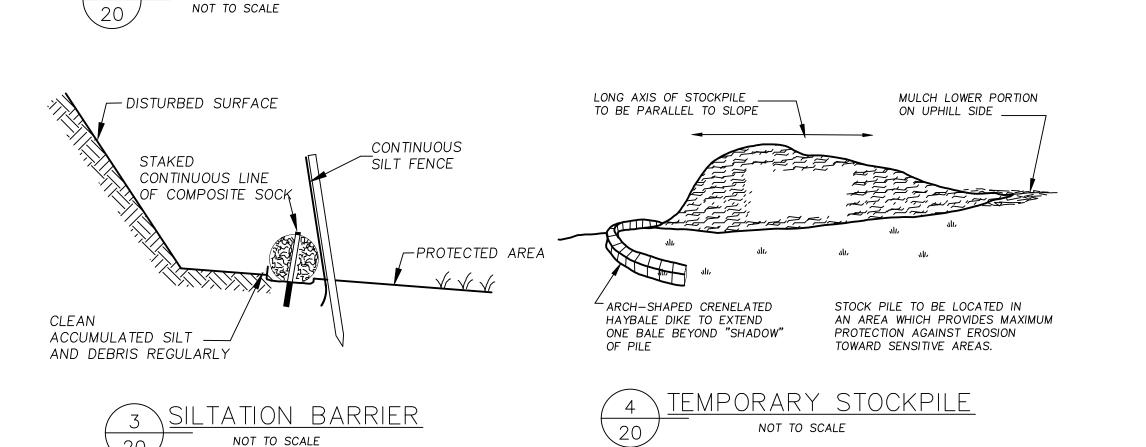






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6 PICKER ROAD STURBRIDGE, MA


CONSTRUCTION **DETAILS**


17/20 - SITE LAYOUT RE-DESIGN

6/1/20 - PER CONSERVATION COMMISSION COMMENTS REVISIONS SCALE: AS SHOWN

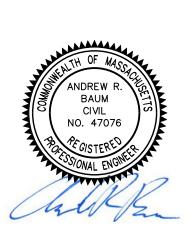MAY 12, 2020 DATE: 20-122 JOB NO: PLAN NO:

20-122 DEFINITIVE SITE PLAN 20 OF 24 SHEET NO:

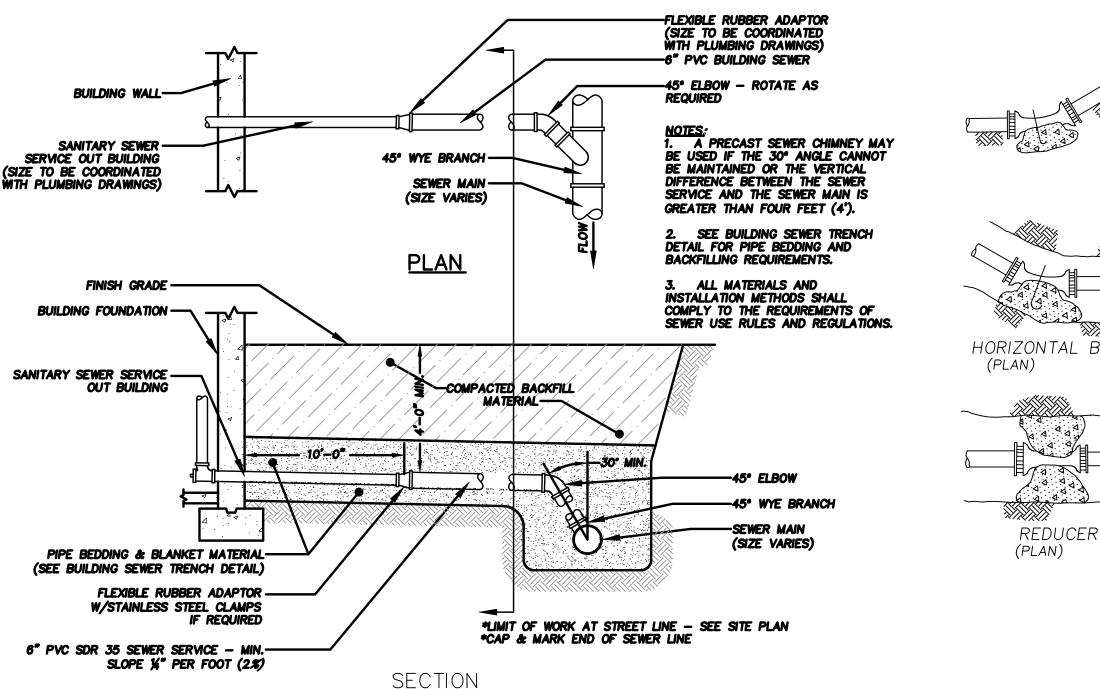

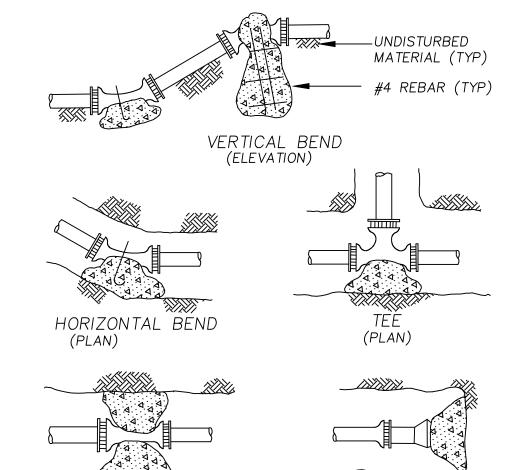

AREA OF BEARING FACE OF CONCRETE THRUST BLOCKS IN SQUARE FEET BASED ON 250 P.S.I. & 1.5 TONS/S.F. ALLOWABLESOILBEARINGCAPACITY				
PIPE SIZE (M)BEND	1/4 BEND	1/8 BEND	1/16 &TEES	PLUG
4 6,8,	6.0	2.9	2.3	4.5
10	9.6	5.2	2.3	6.7
12	13.3	67.	37.	96.
16	24.0	11.8	37.	17.0

_		BEARING AREA — SQ. FT.				
	NORMAL FITTING					
	FITTING DIAMETER	90° BEND	45° BEND	BETWEEN 10°-45°		DEAD END
	6 "	4	2	2	4	4
	8"	7	4	3	5	5

ALL BENDS, TEES, WYES, HYDRANTS AND DEAD ENDS SHALL BE BRACED WITH CONCRETE THRUST BLOCKS 2. BEARING AREA (H X L) IS AREA OF CONE IN CONTACT WITH WALL OF TRENCH 3. HEIGHT (H) & LENGTH (L) AS REQUIRED TO OBTAIN

BEARING AREA IN TABLE 4. BOULDERS ARE NOT TO BE USED AS THRUST BLOCKS.

─1'-6" MIN.**─**


THRUST BLOCK DETAILS NOT TO SCALE

NINNIN.

PLUG

(PLAN)

KENNEDY HYDRANT K81D BY KENNEDY VALVE CO. INC. 5-1/4" VALVE DIAMETER. HYDRANT PAINTED HI-VISIBILTY YELLOW. PENTAGONAL OPERATING NUT SHALL BE 1-5/8" POINT TO FLAT, OPENING RIGHT. 2-2.5" HOSE AND 1-4.5" PUMP NOZZELS, N.S. THREADS

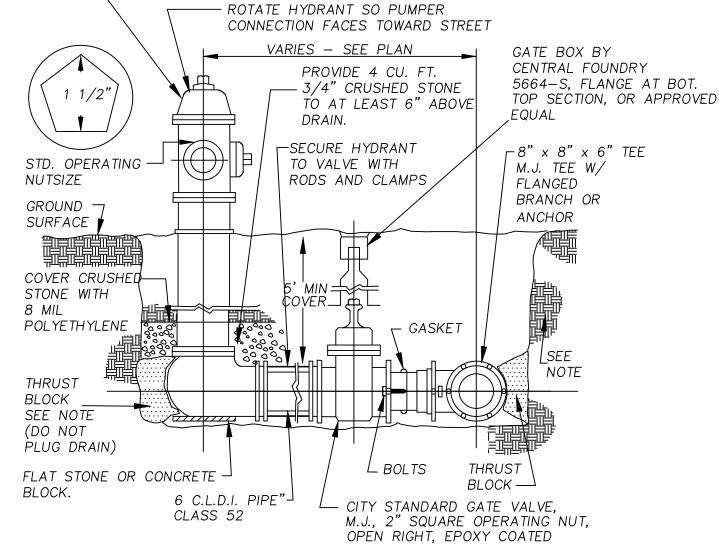

THRUST BLOCK SHALL BE MINIMUM 4,000PSI CONCRETE AT 28 DAYS PLACED AGAINST UNDISTURBED MATERIAL MINIMUM BEARING AREA TO BE 4 SQUARE FEET

HYDRANTS SHALL BE TO THE TOWN OF STURBRIDGE STANDARDS.



COMPACTED

BACKFILL

SHEETING,

COMPACTED SELECTED

∠TOP OF GRAVEL

´STONE CRADLE

IF USED


BACKFILL

LIMIT OF

NORMAL

EXCAVATION



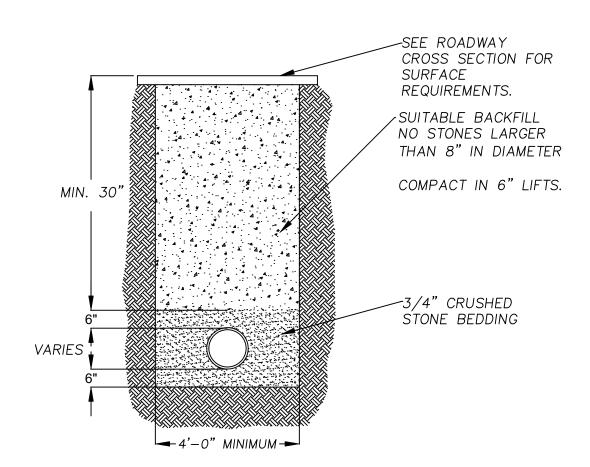



4' DIAMETER

BENCH HEIGHT = 0.75 PIPE DIA.

CONC. BENCH

FRAME & COVER

- PATTERN NO. 1104B

CAMPBELL FOUNDRY CO.

BRICK COURSE TO SUIT

CONCRETE COMPRESSIVE

REINFORCING ASTM A-185

AREA=0.12 IN2/VERTCIAL FT.

ASTM C445/C361 RUBBER ASTM D1056 NEOPRENE

TROWEL COAT OF

BITUMINOUS MATERIAL

__1 1/2" (MIN.) THICKNESS

1. PIPE DIA. NOT TO EXCEED


2. IF H* IS GREATER THEN 24"


USE DROP CONNECTION.


36" DIAMETER.


NON-SHRINK GROUT _ALL-AROUND

STRENGTH 4000 P.S.I.

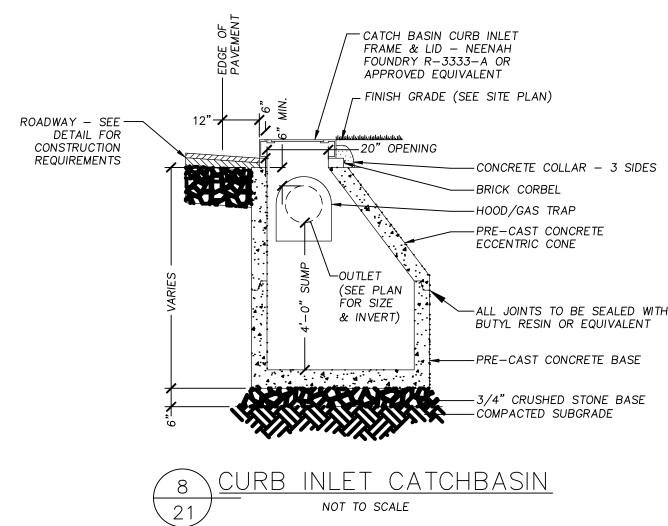


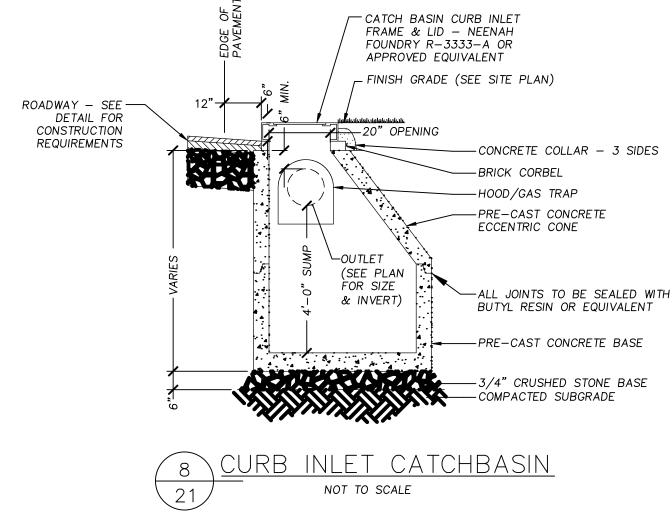

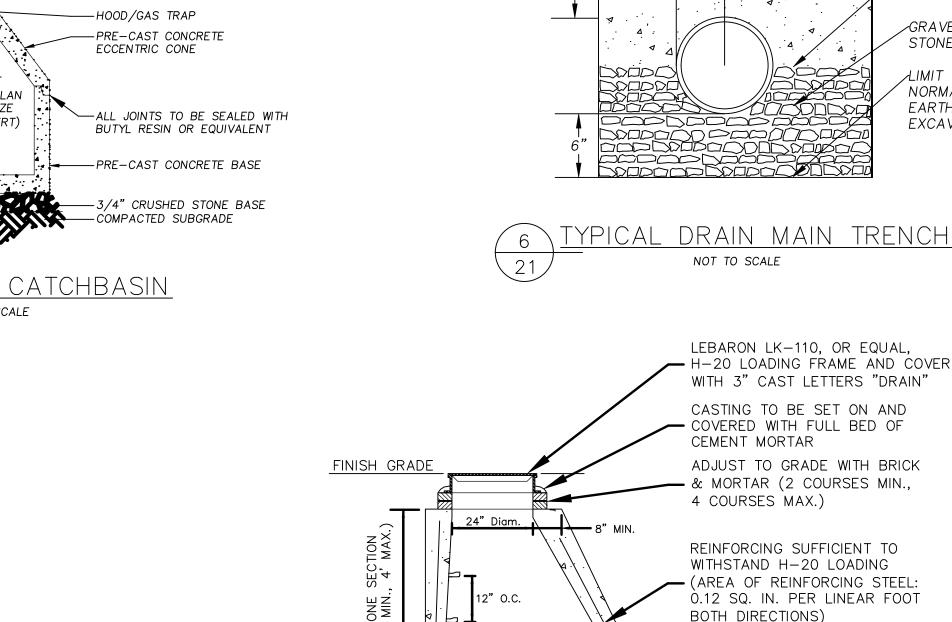

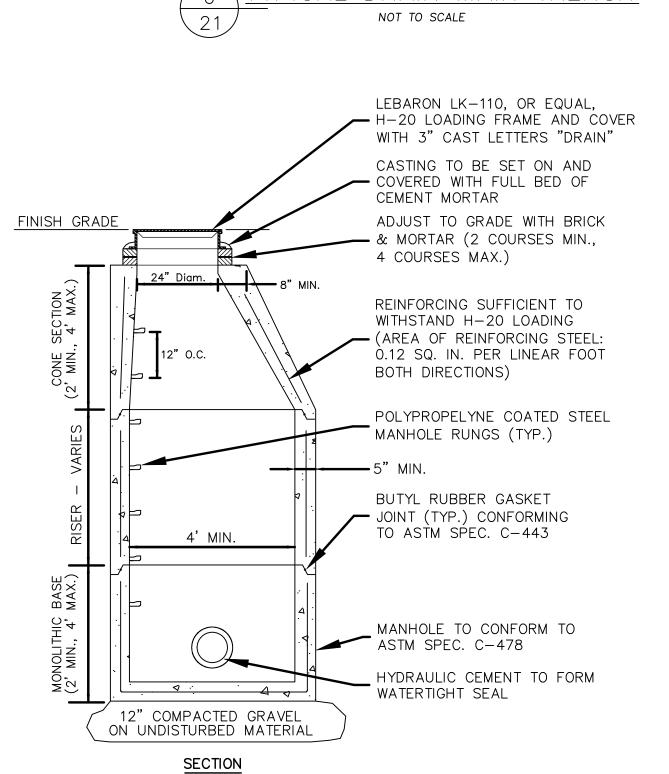



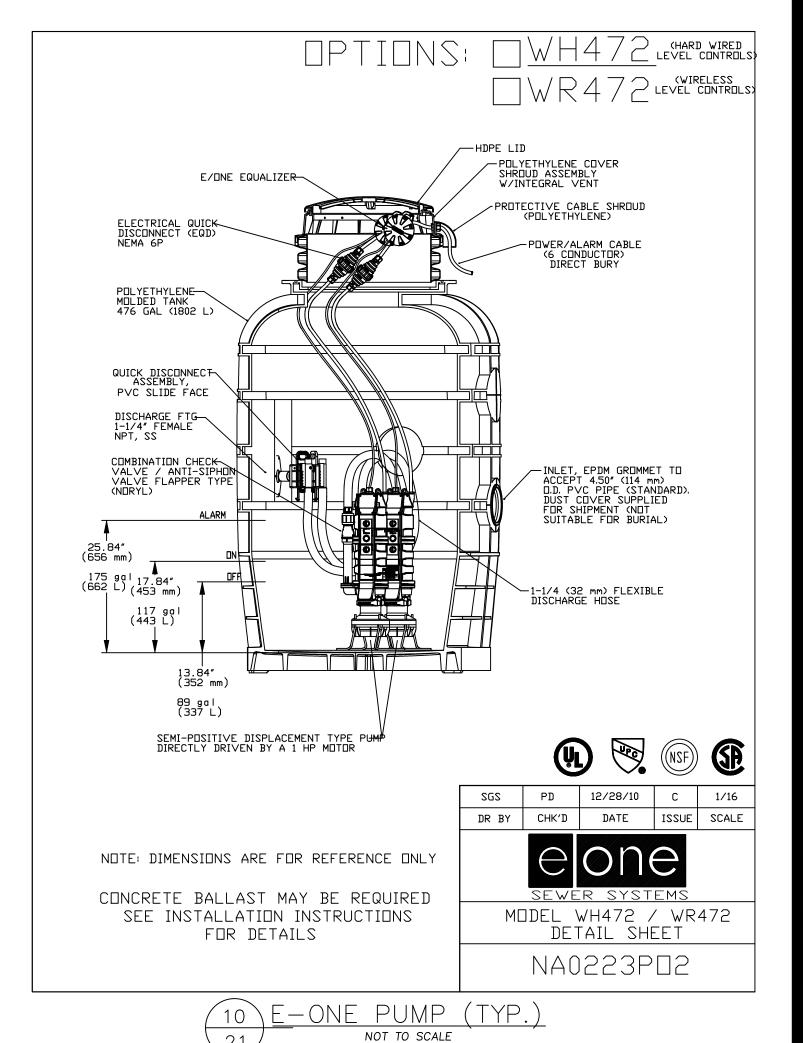

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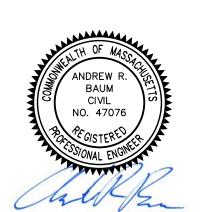


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NEW ENGLAND COLD STORAGE, LLC.

> 6 PICKER ROAD STURBRIDGE, MA

CONSTRUCTION DETAILS

REVISIONS

/17/20 - SITE LAYOUT RE-DESIGN 6/1/20 - PER CONSERVATION COMMISSION COMMENTS

SCALE: DATE: PLAN NO:

AS SHOWN MAY 12, 2020 20-122 20-122 DEFINITIVE SITE PLAN 21 OF 24




NOT TO SCALE


6" - 3/4" STONE

UNDISTURBED


SUBGRADE

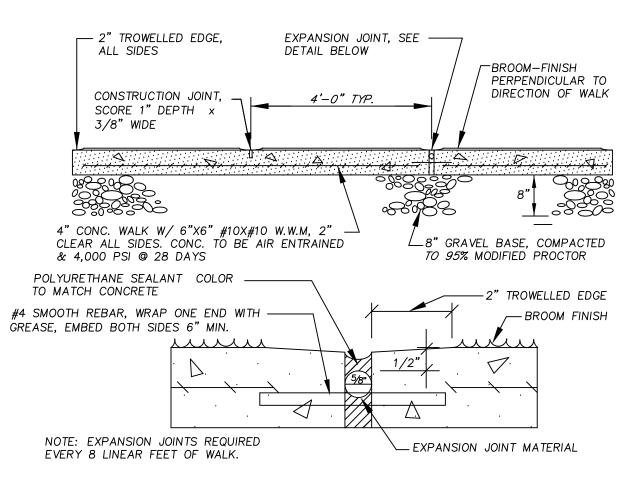




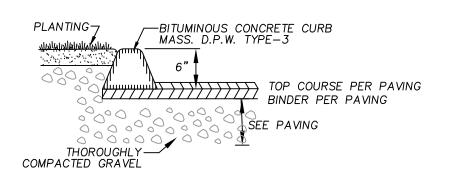


BITUMINOUS CONCRETE CURB NOT TO SCALE

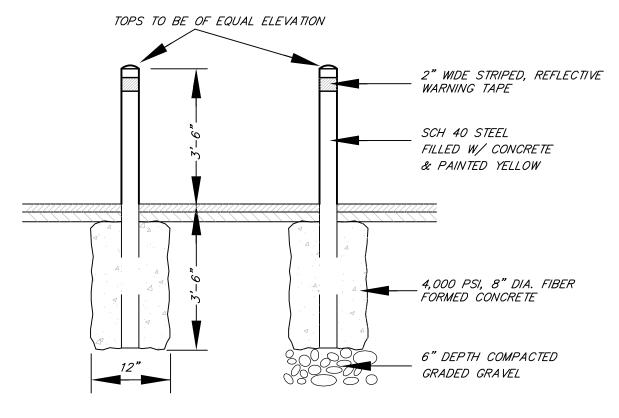



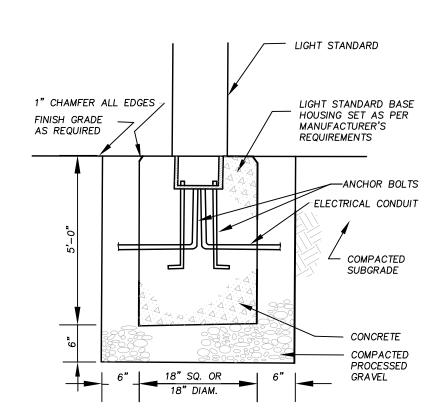

GHT STANDARD BASE NOT TO SCALE

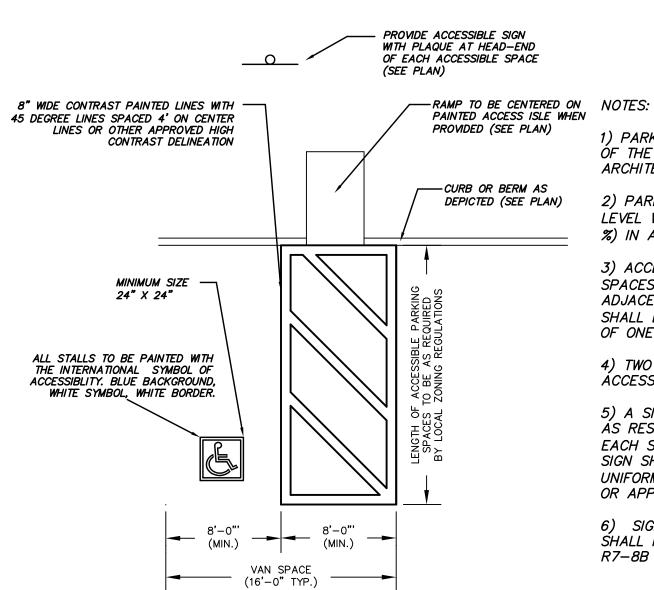

ARCHITECTURAL ACCESS BOARD - 521CMR. 2) PARKING SPACES AND ACCESS ISLES SHALL BE LEVEL WITH SURFACE SLOPES NOT EXCEEDING 1:50 (2 %) IN ALL DIRECTIONS. 3) ACCESS ISLES ADJACENT TO ACCESSIBLE PARKING

SPACES SHALL BE 5'-0" WIDE MINIMUM, EXCEPT ADJACENT VAN ACCESSIBLE SPACES, THE ACCESS ISLE SHALL BE A MINIMUM 8'-0" WIDE MINIMUM. A MINIMUM OF ONE VAN SPACE SHALL BE PROVIDED PER SITE.


1) PARKING SPACES SHALL MEET THE REQUIREMENTS

OF THE CODE OF MASSACHUSETTS REGULATIONS

4) TWO ACCESSIBLE SPACES MAY SHARE A COMMON ACCESS ISLE.

5) A SIGN. IDENTIFYING ACCESSIBLE PARKING SPACES AS RESERVED, SHALL BE LOCATED AT THE HEAD OF EACH SPACE AND NO MORE THAN 10'-0" AWAY. THE SIGN SHALL BE AS SPECIFIED BY THE MANUAL OF UNIFORM TRAFFIC CONTROL DEVICES (MUTCD), R7-8 OR APPROVED EQUAL.

6) SIGNS AT THE HEAD OF VAN ACCESSIBLE SPACES SHALL INCLUDE THE WORDS: VAN ACCESSIBLE, MUTCD

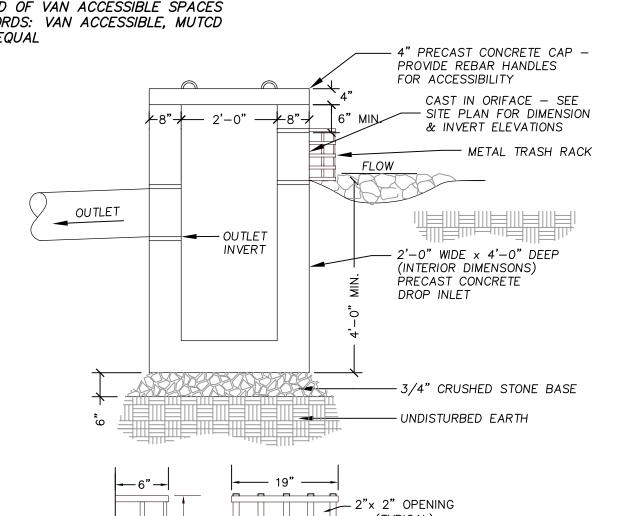

(TYPICAL)

1"x 16" BAR STOCK (TYP)

3" LOAM__ & SEED

LONGITUDINAL SLOPE RANGES FROM


0.005 FT/FT TO 0.100 FT/FT -SEE SITE PLAN.

INSTALL PER MANUFACTURER'S SPECS.

NOT TO SCALE



FRONT VIEW

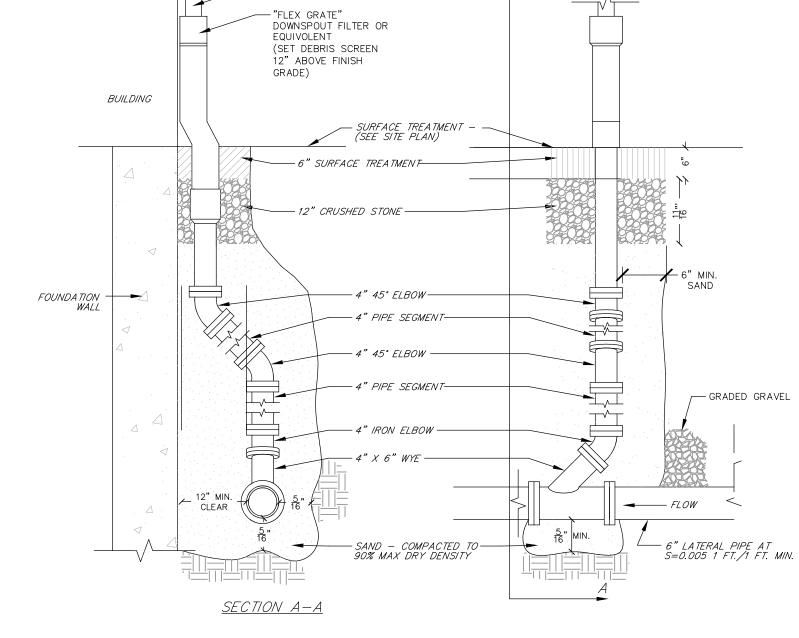

ROOF DRAIN CONNECTION

NOT TO SCALE

RIP-RAP SPECIFICATIONS

100 LB.

60 LB.

25 LB.

2 LB.

% OF TOTAL WEIGHT SMALLER

NOT TO EXCEED 10%

THAN GIVEN SIZE

SEE SITE PLAN

LOAM AND SEED-

18" RIP-RAP MATE

SEE SPECIFICATIONS.

EXTEND RIP-RAP

12" MIN. ABOVE PIPE.

12" COMPACTED

ARED END RIP RAP OUTLET

NOT TO SCALE


NOTE: ALL PIPE & FITTINGS SHALL BE SCH 40 PVC PIPE WITH SOLVENT WELDED BELL & SPIGOT JOINTS

- GUTTER DOWNSPOUT (SEE ARCH. PLANS)


- DRAIN PIPF

— GEOTECHNICAL FABRIC

SEE SITE PLAN

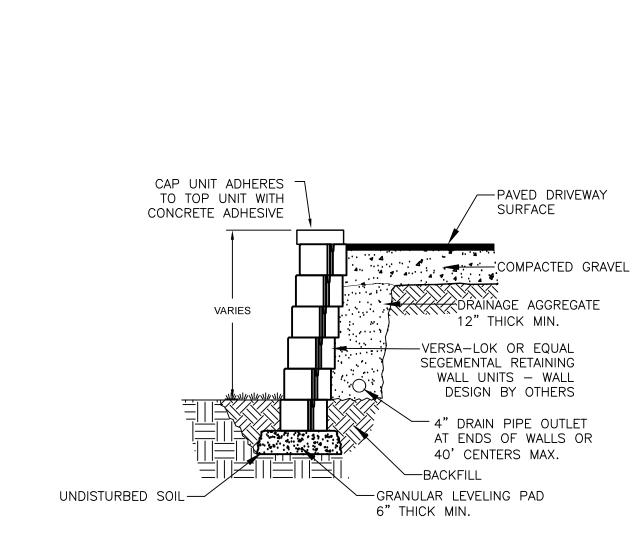



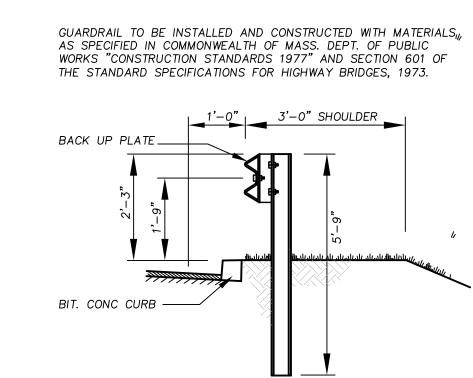



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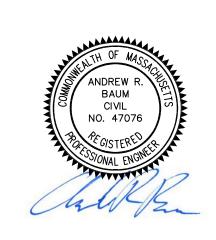


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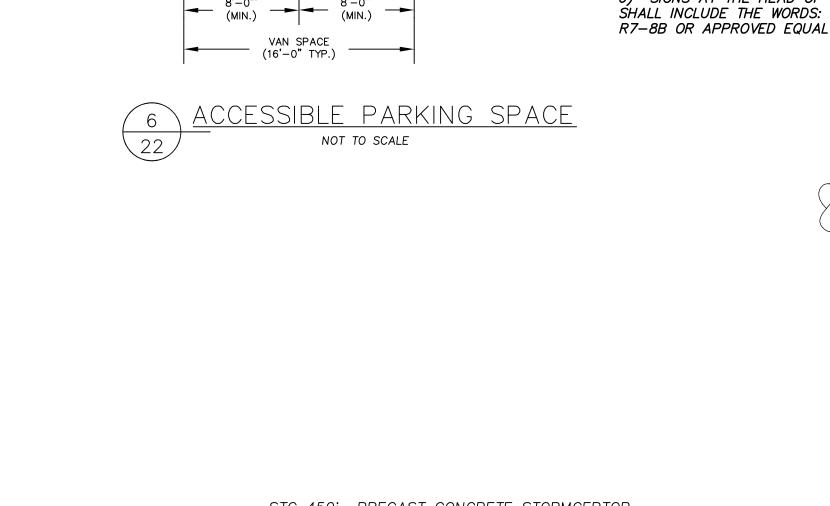
6 PICKER ROAD STURBRIDGE, MA


CONSTRUCTION **DETAILS**

7/17/20 - SITE LAYOUT RE-DESIGN
6/1/20 - PER CONSERVATION COMMISSION COMMENTS
REVISIONS

SCALE: AS SHOWN DATE: 20-122 JOB NO:

MAY 12, 2020 PLAN NO: 20-122 DEFINITIVE SITE PLAN SHEET NO: 22 OF 24



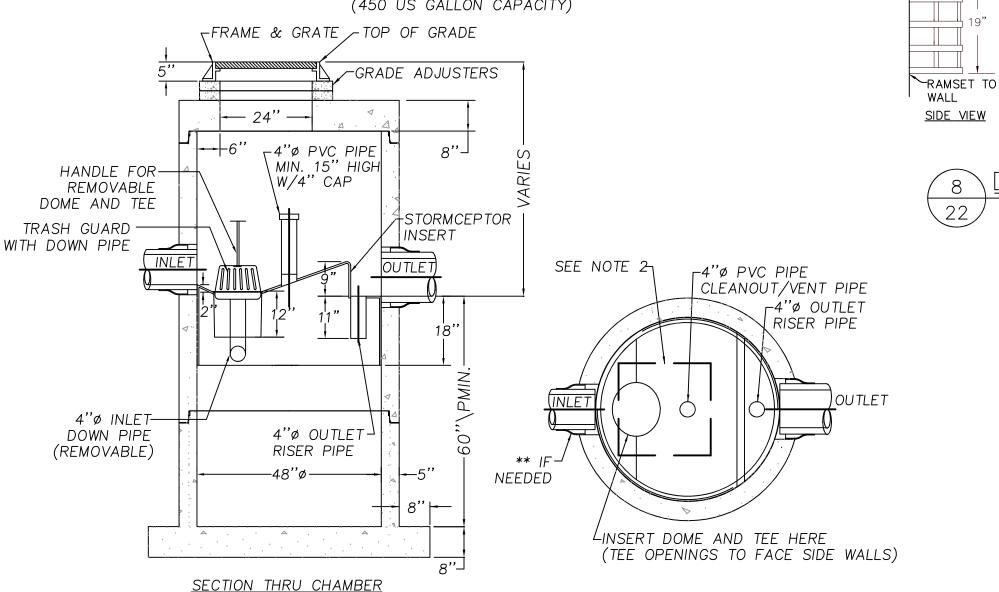


NOTE:


- 1. THE USE OF FLEXIBLE CONNECTIONS IS RECOMMENDED AT THE OUTLET WHERE APPLICABLE.
- 2. THE COVER SHOULD BE POSITIONED OVER THE 4"0 CLEANOUT/VENT PIPE AND THE 4"Ø INLET DOWN PIPE.
- 3. THE STORMCEPTOR SYSTEM IS PROTECTED BY ONE OR MORE OFF THE FOLLOWING U.S. PATENTS: #4985148, #5498331, #5725760, #5753115, #5849181.
- 4. CONTRACTOR TO PROVIDE CRANE TO SET UNIT (HEAVIEST SECTION WEIGHS 5000 LB)


SECTION THRU PLAN VIEW


TORMSCEPTOR — WATER QUALITY SEPARATOR NOT TO SCALE

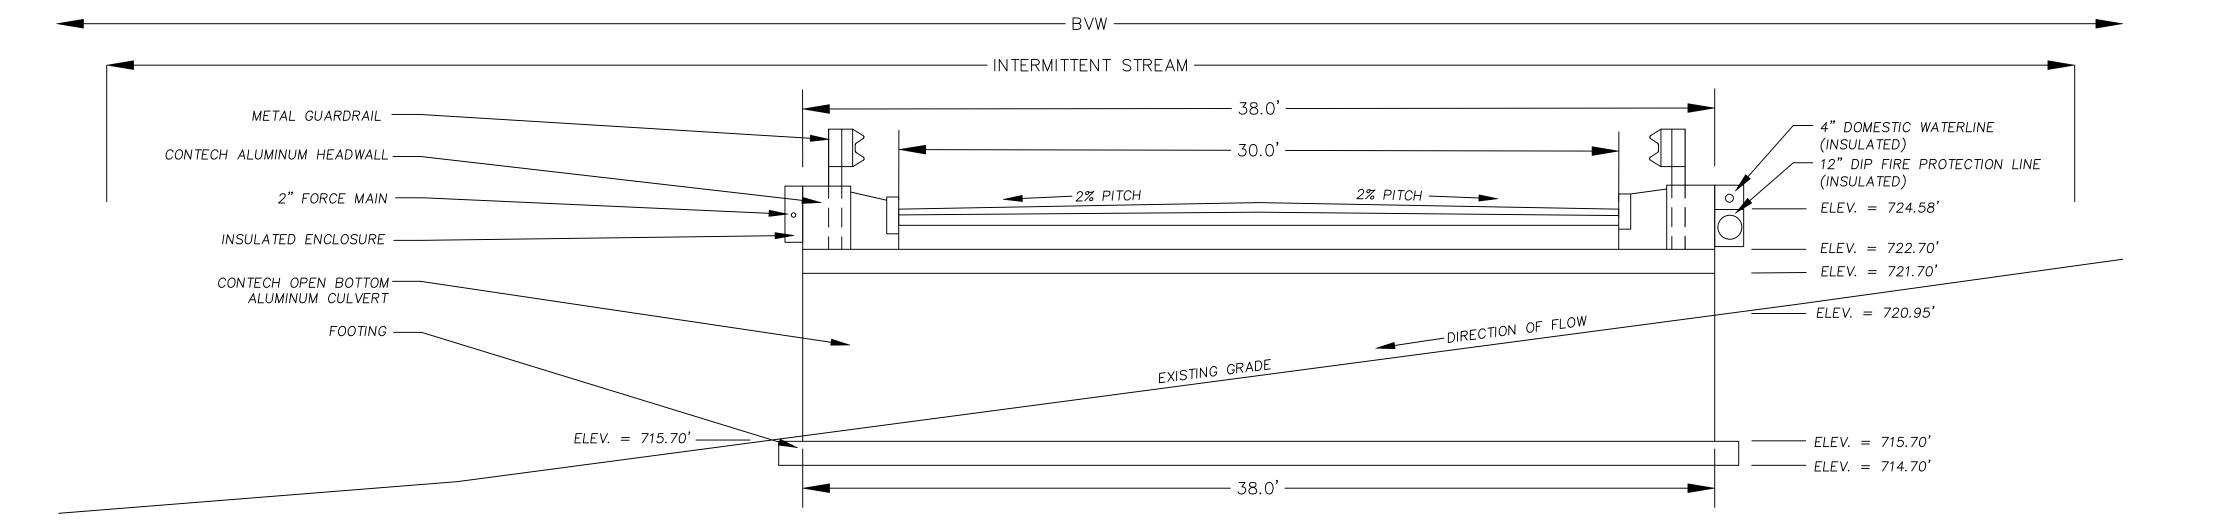

WETLAND CROSSING DETAIL

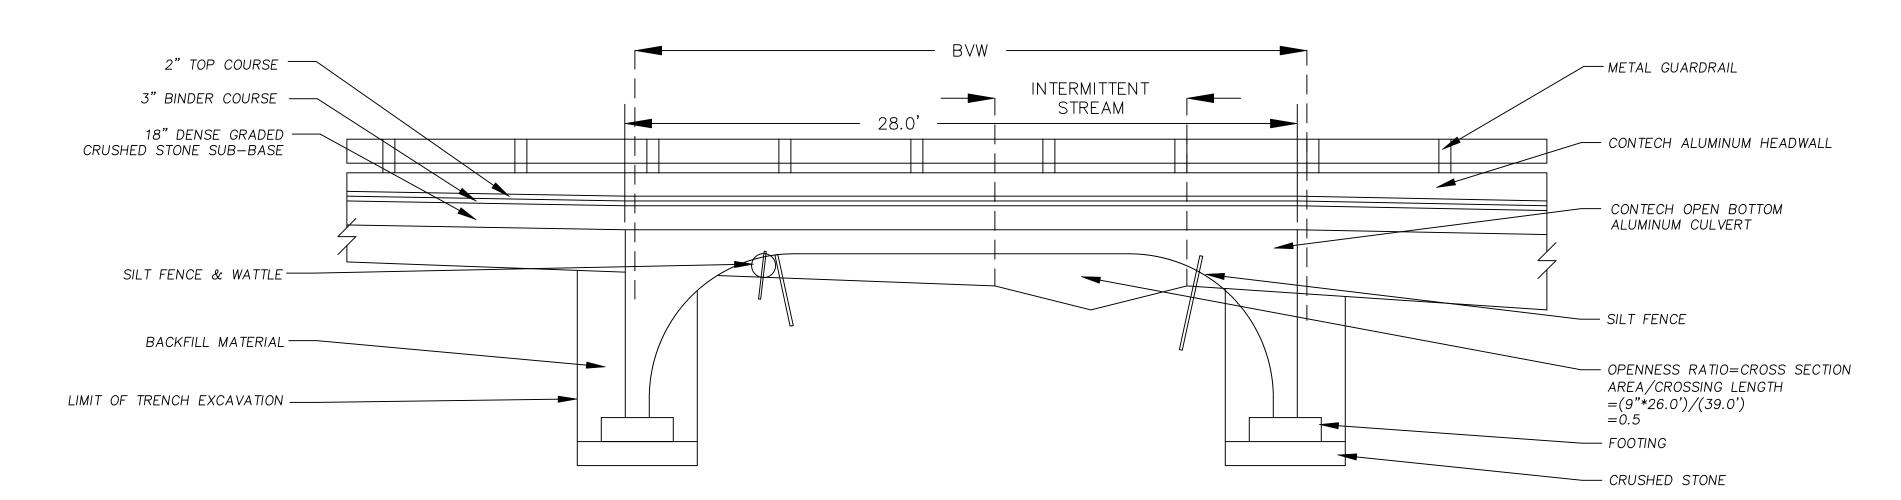

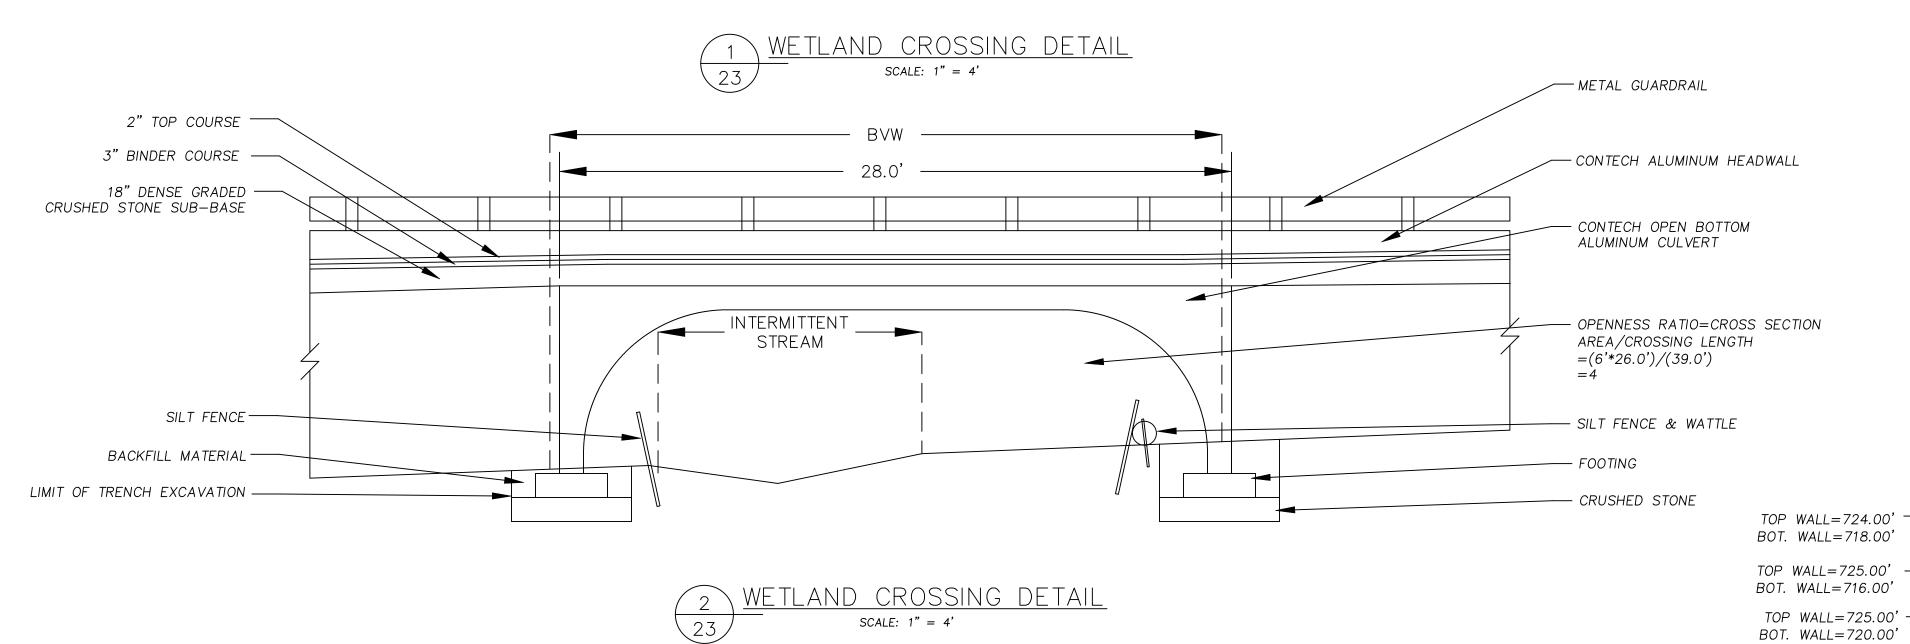

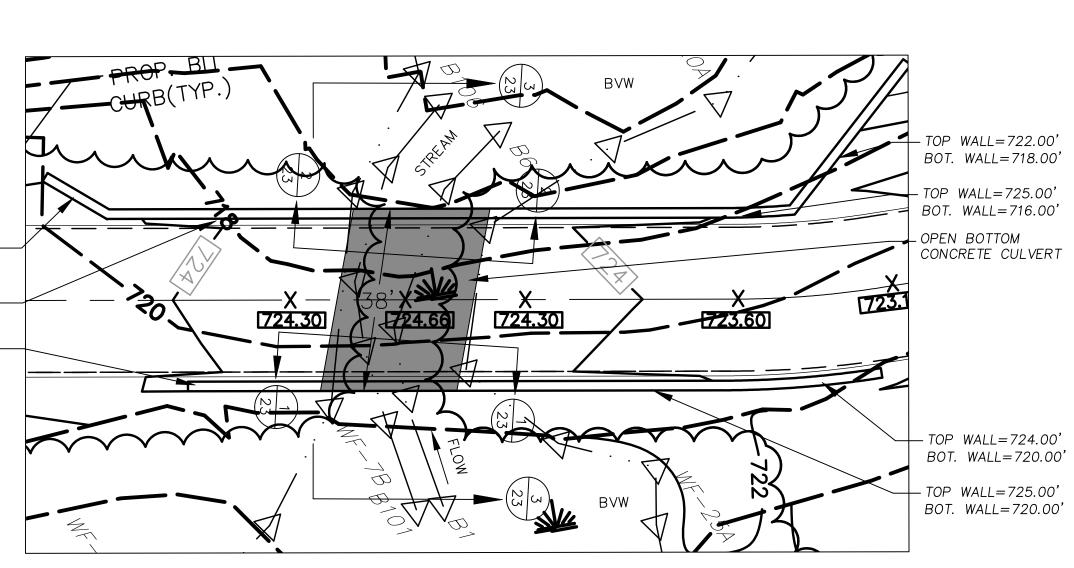

WETLAND CROSSING DETAIL SCALE: 1" = 20'

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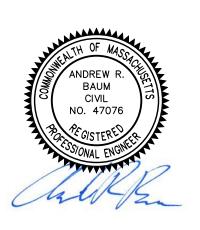


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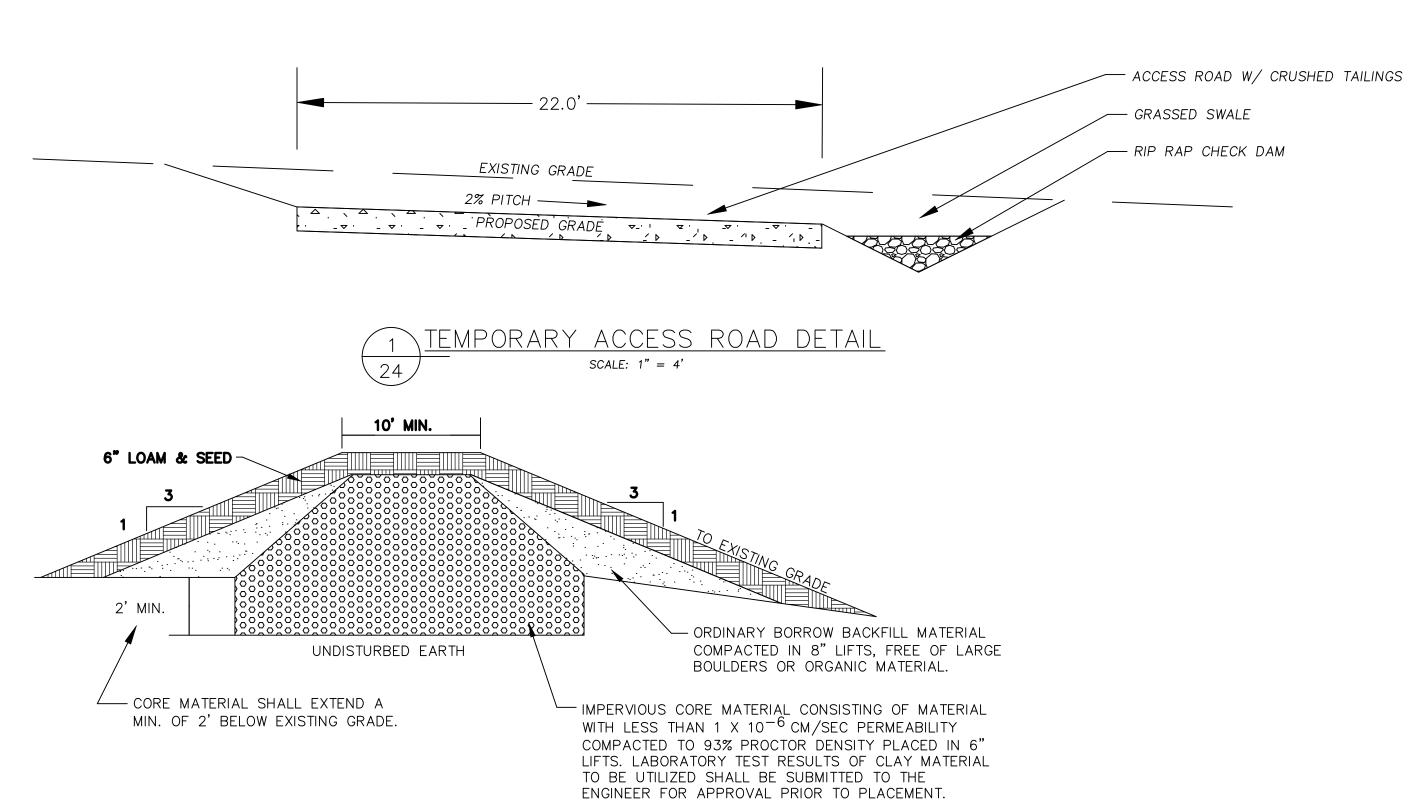
CONSTRUCTION **DETAILS**

7/17/20 - SITE LAYOUT RE-DESIGN

6/1/20 - PER CONSERVATION COMMISSION COMMENTS REVISIONS

SCALE: AS SHOWN MAY 12, 2020 DATE: 20-122 20-122 DEFINITIVE SITE PLAN PLAN NO:

23 OF 24



TOP BERM ELEV.=733.30'

—24" CONC. PIPE

18" HDPE OUTLET

S = 0.010

12" HDPE OUTLET

S = 0.010

-3/4" CRUSHED STONE

COMPACTED SUBGRADE

OUTLET CONTROL STRUCTURE A


NOT TO SCALE


-3/4" CRUSHED STONE

-COMPACTED SUBGRADE

TOP BERM

ELEV.=720.80'

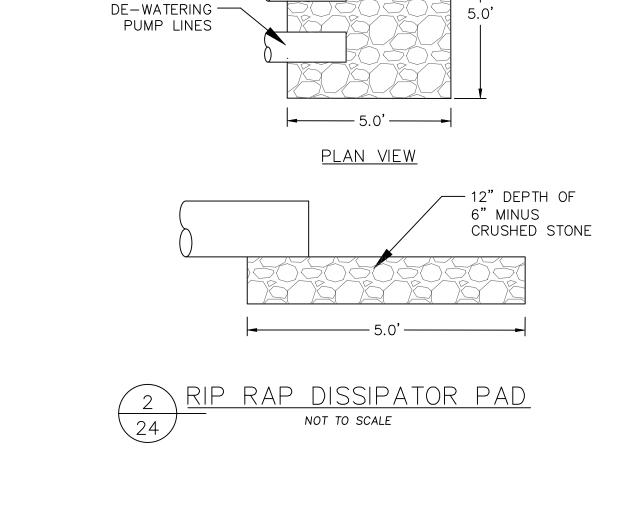

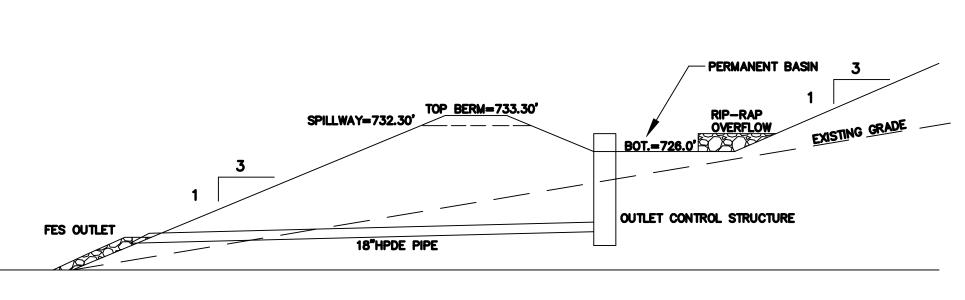


12" DEPTH OF -


CRUSHED STONE

6" MINUS




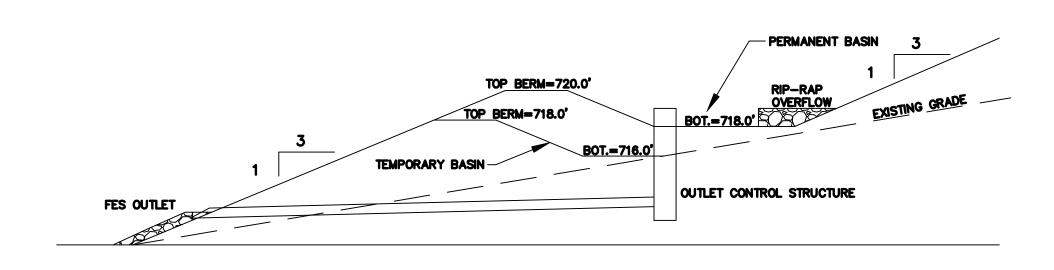





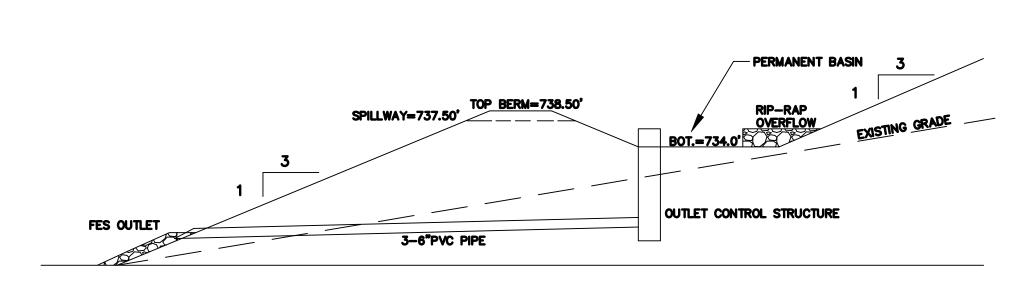



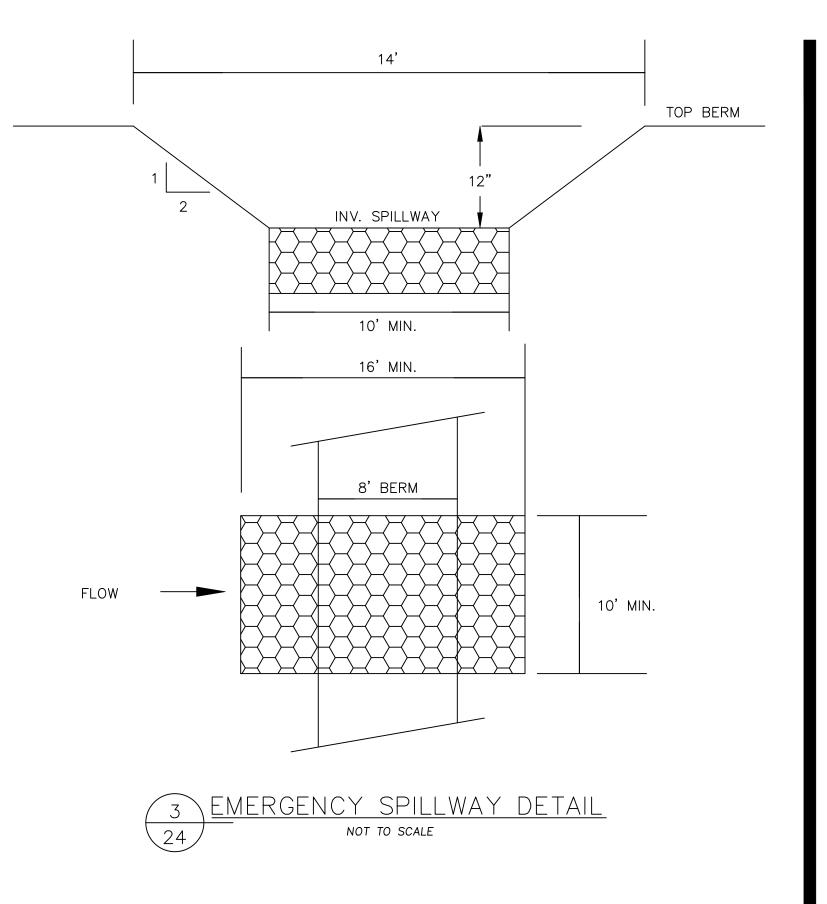

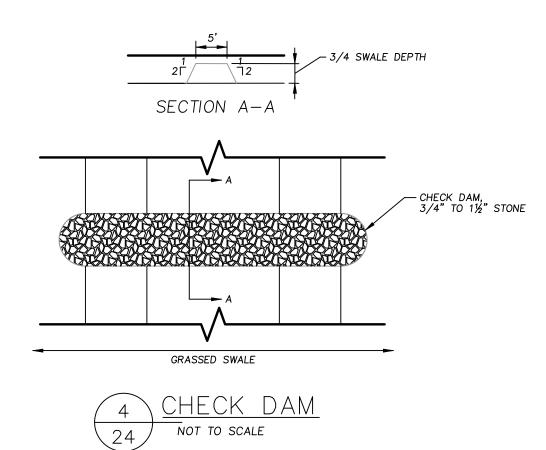

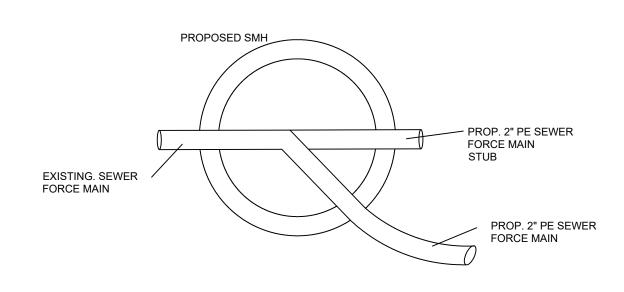



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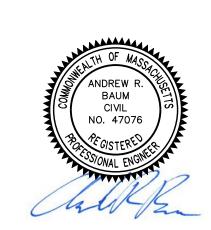


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NEW ENGLAND COLD STORAGE, LLC.

> 6 PICKER ROAD STURBRIDGE, MA

CONSTRUCTION DETAILS

7/17/20 - SITE LAYOUT RE-DESIGN 6/1/20 - PER CONSERVATION COMMISSION COMMENTS

REVISIONS

SCALE: AS SHOWN

SCALE: AS SHOWN

DATE: MAY 12, 2020

JOB NO: 20-122

PLAN NO: 20-122 DEFINITIVE SITE PLAN

24 OF 24

8 ROUND OUTLET CONTROL STRUCTURE B
NOT TO SCALE

0

INVERT OUTLET— ELEVATION=715.22

DETENTION BASIN DETAIL

INVERT OUTLET— ELEVATION=724.70'

24" METAL GRATE -

(1) 10" ORIFICES ELEV. = 730.30'-

(1) 10" ORIFICES ELEV. = 729.00'—

(1) 6" ORIFICE ELEV. = 726.50'

TOP GRATE -ELEV.=732.25'

BOTTOM OF BASIN ELEV. = 726.00'

24" METAL GRATE -

TOP GRATE

ELEV.=720.80'

(1) 3" ORIFICES ELEV. = 718.50' ----

BOTTOM OF BASIN ELEV. = 718.00'

(1) 6" ORIFICES ELEV. = 719.50' (1) 4" ORIFICES ELEV. = 719.00'

11 [