CIM GROUP

2020 PAVING IMPROVEMENTS PLANS
FOR

THE CENTER AT HOBBS BROOK

100 CHARLTON ROAD STURBRIDGE, MA 01566

PROJECT RESOURCE LIST:


VEREIT MT STURBRIDGE MA, LLC 2398 EAST CAMELBACK ROAD, 4TH FLOOR PHOENIX, ARIZONA 85016 TEL: (602) 778-8700 FAX: (602) 801-2736

CONTACT: MARK KROEGER
PROPERTY MANAGER
TEL: (602) 778-6301
EMAIL: MKROEGER@CIMGROUP.COM

ENGINEER

KIMLEY-HORN AND ASSOCIATES, INC. 1001 WARRENVILLE ROAD, SUITE 350 LISLE, IL 60532 TEL: (630) 487-5550

CONTACT: JAKE H. PANTER
PROJECT MANAGER
TEL: (630) 487-3432
EMAIL: JAKE.PANTER@KIMLEY-HORN.COM

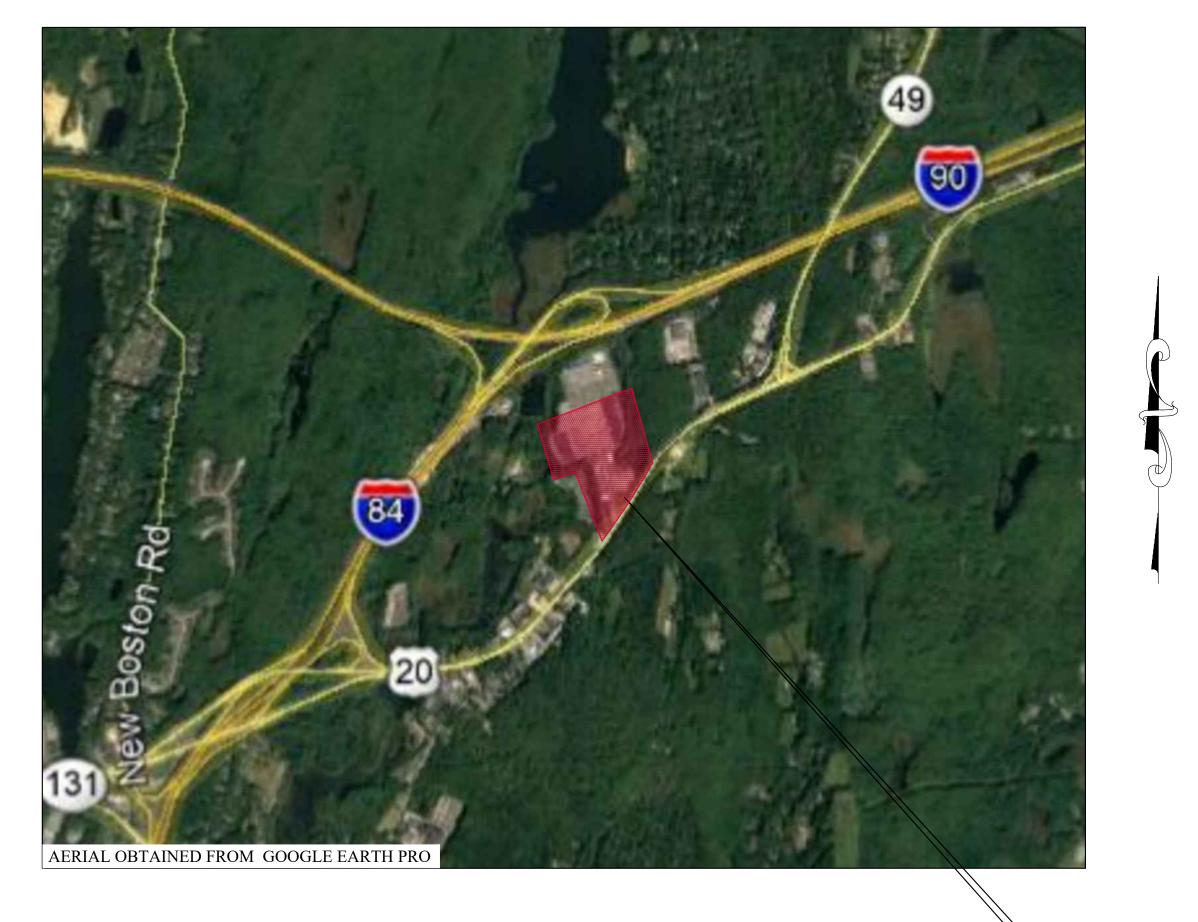



Know what's below.
Call before you dig.

NOTE:
THE EXACT LOCATION OF UTILITIES SHOWN IN THIS PLAN SET ARE UNKNOWN.
THE CONTRACTOR SHALL FIELD VERIFY ALL LOCATIONS AND DEPTHS OF
EXISTING UTILITIES (IN CONFLICT WITH PROPOSED IMPROVEMENTS) BY CALLING
811 AT LEAST 3 WORKING DAYS PRIOR TO STARTING ANY EXCAVATION.

PROJECT

SITE

		SHEET INDEX
	SHEET NO:	DESCRIPTION:
	C0-00	COVER SHEET
	C1-00	SITE IMPROVEMENTS
	C1-01	SITE IMPROVEMENTS
	C1-02	ADA IMPROVEMENTS
	C1-03	ADA IMPROVEMENTS
•	C1-04	ADA IMPROVEMENTS
	C1-05	EROSION CONTROL PLAN
	C2-00	EROSION CONTROL DETAILS
	C2-00	CONSTRUCTION DETAILS
	C2-02	CONSTRUCTION DETAILS
	C2-03	CONSTRUCTION DETAILS
	C2-04	PAVEMENT CORING INFORMATION
	C3-00	GENERAL NOTES

GENERAL PROJECT NOTES:

- 1. CONTRACTOR TO COMPLETE WORK IN A MANNER TO MINIMIZE DISRUPTION TO CUSTOMER PARKING AND ACCESS.
- 2. CONTRACTOR TO FULLY INFORM THE OWNER PRIOR TO COMMENCING WORK. CONTRACTOR WILL BE RESPONSIBLE TO PROVIDE CONSTRUCTION STATUS UPDATES AND SUBMIT CLOSURE SCHEDULES TO OWNER.
- 3. CONTRACTOR TO PROVIDE BARRICADES AND PROPER TRAFFIC CONTROL AT ALL TIMES DURING CONSTRUCTION TO ENSURE THE SAFETY OF ALL INDIVIDUALS PRESENT ON SITE.
- CONTRACTOR IS RESPONSIBLE TO MEET THE ADA GRADING AS SHOWN IN THE CONTRACT DOCUMENTS. THIS INCLUDES ALL MEANS AND METHODS AND AT THE CONTRACTOR'S DISCRETION, THE NEED TO OBTAIN A SURVEYOR FOR CONSTRUCTION STAKING. CONTRACTOR, SHALL BID THIS PROJECT WITH ALL NECESSARY MEANS INCORPORATED TO ENSURE ADA COMPLIANT SLOPES ARE MET. AFTER REVIEWING THE ADA SLOPE TRANSITION DETAIL ON THE DRAWINGS SHOULD THE CONTRACTOR DETERMINE THAT CONSTRUCTION STAKING, OR ANY OTHER ACTIVITIES ARE STILL REQUIRED FOR THE ADA INSTALLATION, THESE SHOULD BE INCLUDED/BUILT IN TO THE UNIT COSTS ON THE CONTRACTORS BID FORM. NO EXTRAS WILL BE GIVEN TO THE CONTRACTOR FOR CONSTRUCTION STAKING SERVICES. ADDITIONALLY, ANY REWORK REQUIRED DUE TO THE WORK NOT MEETING THE ADA DESIGN AS SHOWN IN THESE CONSTRUCTION DRAWINGS WILL BE AT THE SOLE EXPENSE OF THE CONTRACTOR UNTIL THE ADA DESIGN HAS BEEN ADEQUATELY CONSTRUCTED.



1001 WARRENVILLE ROAD, SUITE 39

TEL. NO. (630) 487-555

10.	DATE	REVISIONS	BY	
1	07/07/20	EROSION CONTROL	WAD	
				KHA PROJECT 168719048
				DATE
				04/04/2020
				SHEET NUMBER
				C0-00

NOTE: INCIDENTAL CONSTRUCTION TO BE INCLUDED IN PAVING IMPROVEMENT LUMP SUM PRICES SHALL INCLUDE SOIL EROSION & SEDIMENTATION CONTROL, LANDSCAPING RESTORATION, TEMPORARILY REMOVING AND RESETTING CONCRETE BLOCKS OR OTHER PORTABLE DEVICES, REPLACEMENT OF PAVEMENT STRIPING AND PAVEMENT MARKINGS, STRUCTURE ADJUSTMENTS, PERMITS, AND PROVIDING BARRIER—FREE DOCUMENTATION OF COMPLETED WORK.

APPROXIMATE LOCATIONS OF INCIDENTAL CONSTRUCTION ARE SHOWN WHERE APPLICABLE. QUANTITY MAY

INCREASE OR DECREASE WHERE FOUND NECESSARY

UPON SITE REVIEW WITH DESIGN CONSULTANT OR

THIS PLAN SET IS BASED ON AUTOCAD FILES OBTAINED BY KIMLEY—HORN AND ASSOCIATES, INC.

FROM CIM GROUP

DRAWING RECEIVED ON: JULY 27, 2016
THE CONTRACTOR IS SPECIFICALLY CAUTIONED THAT
THE EXISTING INFORMATION SHOWN ON THESE PLANS
IS NOT TO BE RELIED ON AS BEING EXACT OR
COMPLETE. THE CONTRACTOR WILL BE RESPONSIBLE
FOR FIELD VERIFYING EXISTING SITE CONDITIONS
BEFORE COMMENCING CONSTRUCTION. THE
CONTRACTOR MUST ALSO CALL 811 AT LEAST 72
HOURS BEFORE ANY EXCAVATION TO REQUEST

EXACT FIELD LOCATION OF UTILITIES.

PAVEMENT BASE BID 1TOTAL ESTIMATED QUANTITIES		
ASPHALT IMPROVEMENTS		
CRACK SEAL	1	LS
2.0" MILL AND OVERLAY	6,452	SY
1.0" INCREMENTAL MILL AND REPLACE (ALLOWANCE)	650	SY
CUT AND PATCH	150	SY
CONCRETE IMPROVEMENTS		
INSTALL CONCRETE COLLAR	2	EA
MISCELLANEOUS IMPROVEMENTS		
RESTRIPE/SITE PAINT (DISTURBED AREAS ONLY)	1	LS
LICENSED MATERIALS TESTING AGENCY	1	LS
ALTERNATE 1A		
2.5" REMOVE AND REPLACE	652	SY
ALTERNATE 1B		
2.5" REMOVE AND REPLACE	380	SY
ALTERNATE 1C		
3.5" REMOVE AND REPLACE	538	SY
ALTERNATE 1D	4	1.0
CRACK SEAL	1	LS
NOTE: QUANTITIES PROVIDED ABOVE ARE FOR REFERENCE ONLY TO ASSIST THE CONTRACTOR KIMLEY—HORN AND ASSOCIATES, INC. PROVIDES NO GUARANTEE TO THE ACCURACY OF THE E QUANTITIES LISTED. IT WILL BE THE RESPONSIBILITY OF THE CONTRACTOR TO FIELD VERIFY WILL IMPROVEMENTS SHOWN AND COMPLETE THE ENTIRE SCOPE OF WORK AT NO INCREASE IN LUM	STIMATED ORK AREAS AN	

SPHALT IMPROVEMENTS		
EMOVE, REGRADE, AND REPLACE	342	
CONCRETE IMPROVEMENTS		
EMOVE, REGRADE, AND REPLACE INTEGRAL CURB AND SIDEWALK (INCLUDES CONSTRUCTION F 1 CURB RAMP)	104	
EMOVE AND REPLACE VERTICAL CURB	68	
IISCELLANEOUS IMPROVEMENTS		
EMOVE AND REPLACE ADA SIGN AND POST WITH BOLLARD	2	
EGRADE AND RESTORE LANDSCAPING	32	
ESTRIPE/SITE PAINT (DISTURBED AREAS ONLY)	1	
LTERNATE 2A		
EMOVE, REGRADE, AND REPLACE	570	
EMOVE, REGRADE, AND REPLACE INTEGRAL CURB AND SIDEWALK (INCLUDES CONSTRUCTION F 1 CURB RAMP)	179	
EMOVE AND REPLACE VERTICAL CURB	27	
EMOVE AND REPLACE ADA SIGN AND POST WITH BOLLARD	3	
EGRADE AND RESTORE LANDSCAPING	10	
LTERNATE 2B		
EMOVE, REGRADE, AND REPLACE	227	
EMOVE, REGRADE, AND REPLACE INTEGRAL CURB AND SIDEWALK (INCLUDES CONSTRUCTION	157	
F 1 CURB RAMP)	14	

IMPROVEMENTS SHOWN AND COMPLETE THE ENTIRE SCOPE OF WORK AT NO INCREASE IN LUMP SUM PRICE.

GENERAL NOTES

- INSTALL SILTSACK OR APPROVED EQUAL INLET FILTER AT STORM SEWER INLET (TYP.) FOR ALL INLETS WITHIN OR DOWNSTREAM OF PAVEMENT REPAIR AREAS. SEE DETAIL.
- CONTRACTOR SHALL PHASE WORK SO THAT CUSTOMER ACCESS TO BUILDING ENTRANCES REMAIN OPEN AT ALL TIMES.
- 3. CONTRACTOR TO LOCATE ALL PRIVATE AND PUBLIC UTILITIES ON SITE WITHIN WORK AREAS. CONTRACTOR TO TAKE EXTRA CAUTION TO AVOID DAMAGE TO ELECTRICAL, TELEPHONE, IRRIGATION, AND OTHER CONDUITS TYPICALLY FOUND IN THE UPPER FEW FEET OF GROUND. CONTRACTOR SHALL REPLACE ANY DAMAGED OR DESTROYED UTILITIES AT NO ADDITIONAL COST TO THE OWNER.
- 4. CONTRACTOR TO REMOVE TREE ROOTS AS NECESSARY TO PERFORM REPAIRS INDICATED. WHEN ROOT CUTTING IS UNAVOIDABLE, A CLEAN SHARP CUT SHALL BE MADE TO AVOID SHREDDING OR SMASHING. ROOT CUTS SHOULD BE MADE BACK TO A LATERAL ROOT. WHENEVER POSSIBLE, TREE ROOTS SHOULD BE CUT BETWEEN LATE FALL AND BUD OPENING, WHEN ROOT ENERGY SUPPLIES ARE HIGH AND CONDITIONS ARE LEAST FAVORABLE FOR DISEASE CAUSING AGENTS. EXPOSED ROOTS SHALL BE COVERED IMMEDIATELY TO PREVENT DEHYDRATION. ROOTS SHALL BE COVERED WITH SOIL OR BURLAP AND KEPT MOIST.
- 5. PAVEMENT CORES HAVE BEEN OBTAINED FOR THE ENGINEER'S AND OWNER'S USE AND ARE AVAILABLE TO THE CONTRACTOR TO USE TO THE EXTENT THEY FEEL ARE SUFFICIENT. THE CONTRACTOR IS CAUTIONED THAT PAVEMENT AND OTHER MATERIAL THICKNESS MAY VARY BETWEEN ACTUAL CORE LOCATIONS. THE CONTRACTOR IS ENCOURAGED TO PERFORM THEIR OWN INVESTIGATION PRIOR TO BIDDING IN ORDER TO MEET THE INTENT OF THE PLANS AND SPECIFICATIONS. THERE WILL BE NO EXTRAS FOR VARIANCE BETWEEN CORES MADE AVAILABLE TO THE
- 6. ALL PAVEMENT REPLACED ON MILLED SURFACES SHALL STAGGER/OFFSET THE EXISTING JOINTS A MINIMUM OF 3 FEET WHERE POSSIBLE, TYP.
- 7. IN 2.5 AND 3.5" REMOVE AND REPLACE AREAS, CONTRACTOR TO REMOVE THE UPPER 2.5 AND 3.5" OF MATERIAL (PAVEMENT AND/OR AGGREGATE BASE) TO OVERLAY WITH 2.5 AND 3.5" OF NEW ASPHALT PAVEMENT. CONTRACTOR TO NOTE THAT PAVEMENT CORES SHOW SEVERAL AREAS WITH LESS THAN 2.5 AND 3.5" OF ASPHALT EXISTING. CONTRACTOR TO REMOVE BASE AS NECESSARY SO THAT NEW 2.5 AND 3.5" ASPHALT SECTION MATCHES EXISTING ELEVATIONS. CONTRACTOR SHALL ENSURE POSITIVE DRAINAGE.
- 8. CUT AND PATCH AREAS SHOWN ON PLANS ARE APPROXIMATE IN SIZE AND LOCATION AND MAY BE ADJUSTED AT THE TIME OF CONSTRUCTION.

PAVEMENT MARKING NOTES

- 1. CONTRACTOR SHALL TAKE FIELD MEASUREMENTS OR OTHERWISE ESTABLISH A SURVEY OF THE EXISTING STRIPING IN ALL WORK AREAS IN ORDER TO ESTABLISH ALL EXISTING PAVEMENT MARKINGS WITH FULL COORDINATION OF NEW MARKINGS PROPOSED ON THIS PLAN.
- 2. UNLESS OTHERWISE INDICATED ON THE PLANS, THE CONTRACTOR SHALL ESTABLISH PAVEMENT MARKINGS FOR ALL FIRE LANES, DIRECTIONAL ARROWS, STOP BARS, CURBS, SIDEWALK, LIGHT POLE BASES, SIGN BASES AND PARKING STALLS TO MATCH THE EXISTING SITE WITHIN THE REPAIR LIMITS
- 3. CONTRACTOR TO USE APPROPRIATE PAINT COLORS TO MATCH THE EXISTING FEATURES. ADA BARRIER FREE AREAS TO COMPLY WITH ALL LOCAL AND FEDERAL ADA STANDARDS. PAVEMENT MARKINGS SHALL BE A HIGH QUALITY PAINT RECOMMENDED BY THE PAINT MANUFACTURER. PAINT COLORS SHALL CLOSELY MATCH THE FEDERAL STANDARD 595B COLOR NUMBER AS FOLLOWS: BLUE—COLOR 15180, WHITE—COLOR 37925 AND YELLOW—COLOR 33538.

1 EROSION CONTROL 07

KIMLEY-HORN AND ASSOCIATES, INC.
ENVILLE ROAD, SUITE 350, LISLE, IL 60532
PHONE: 630-487-5550
www.kimley-horn.com

168719048
DATE
04/04/2020
SCALE AS SHOWN
DESIGNED BY ATO
DRAWN BY ATO

IMPROVEMENTS


SITE


THE CENTER AT HOBBS BROOK TURBRIDGE, MA

Know what's below.
Call before you dig.

THE CENT

SHEET NUMBER
C1-00

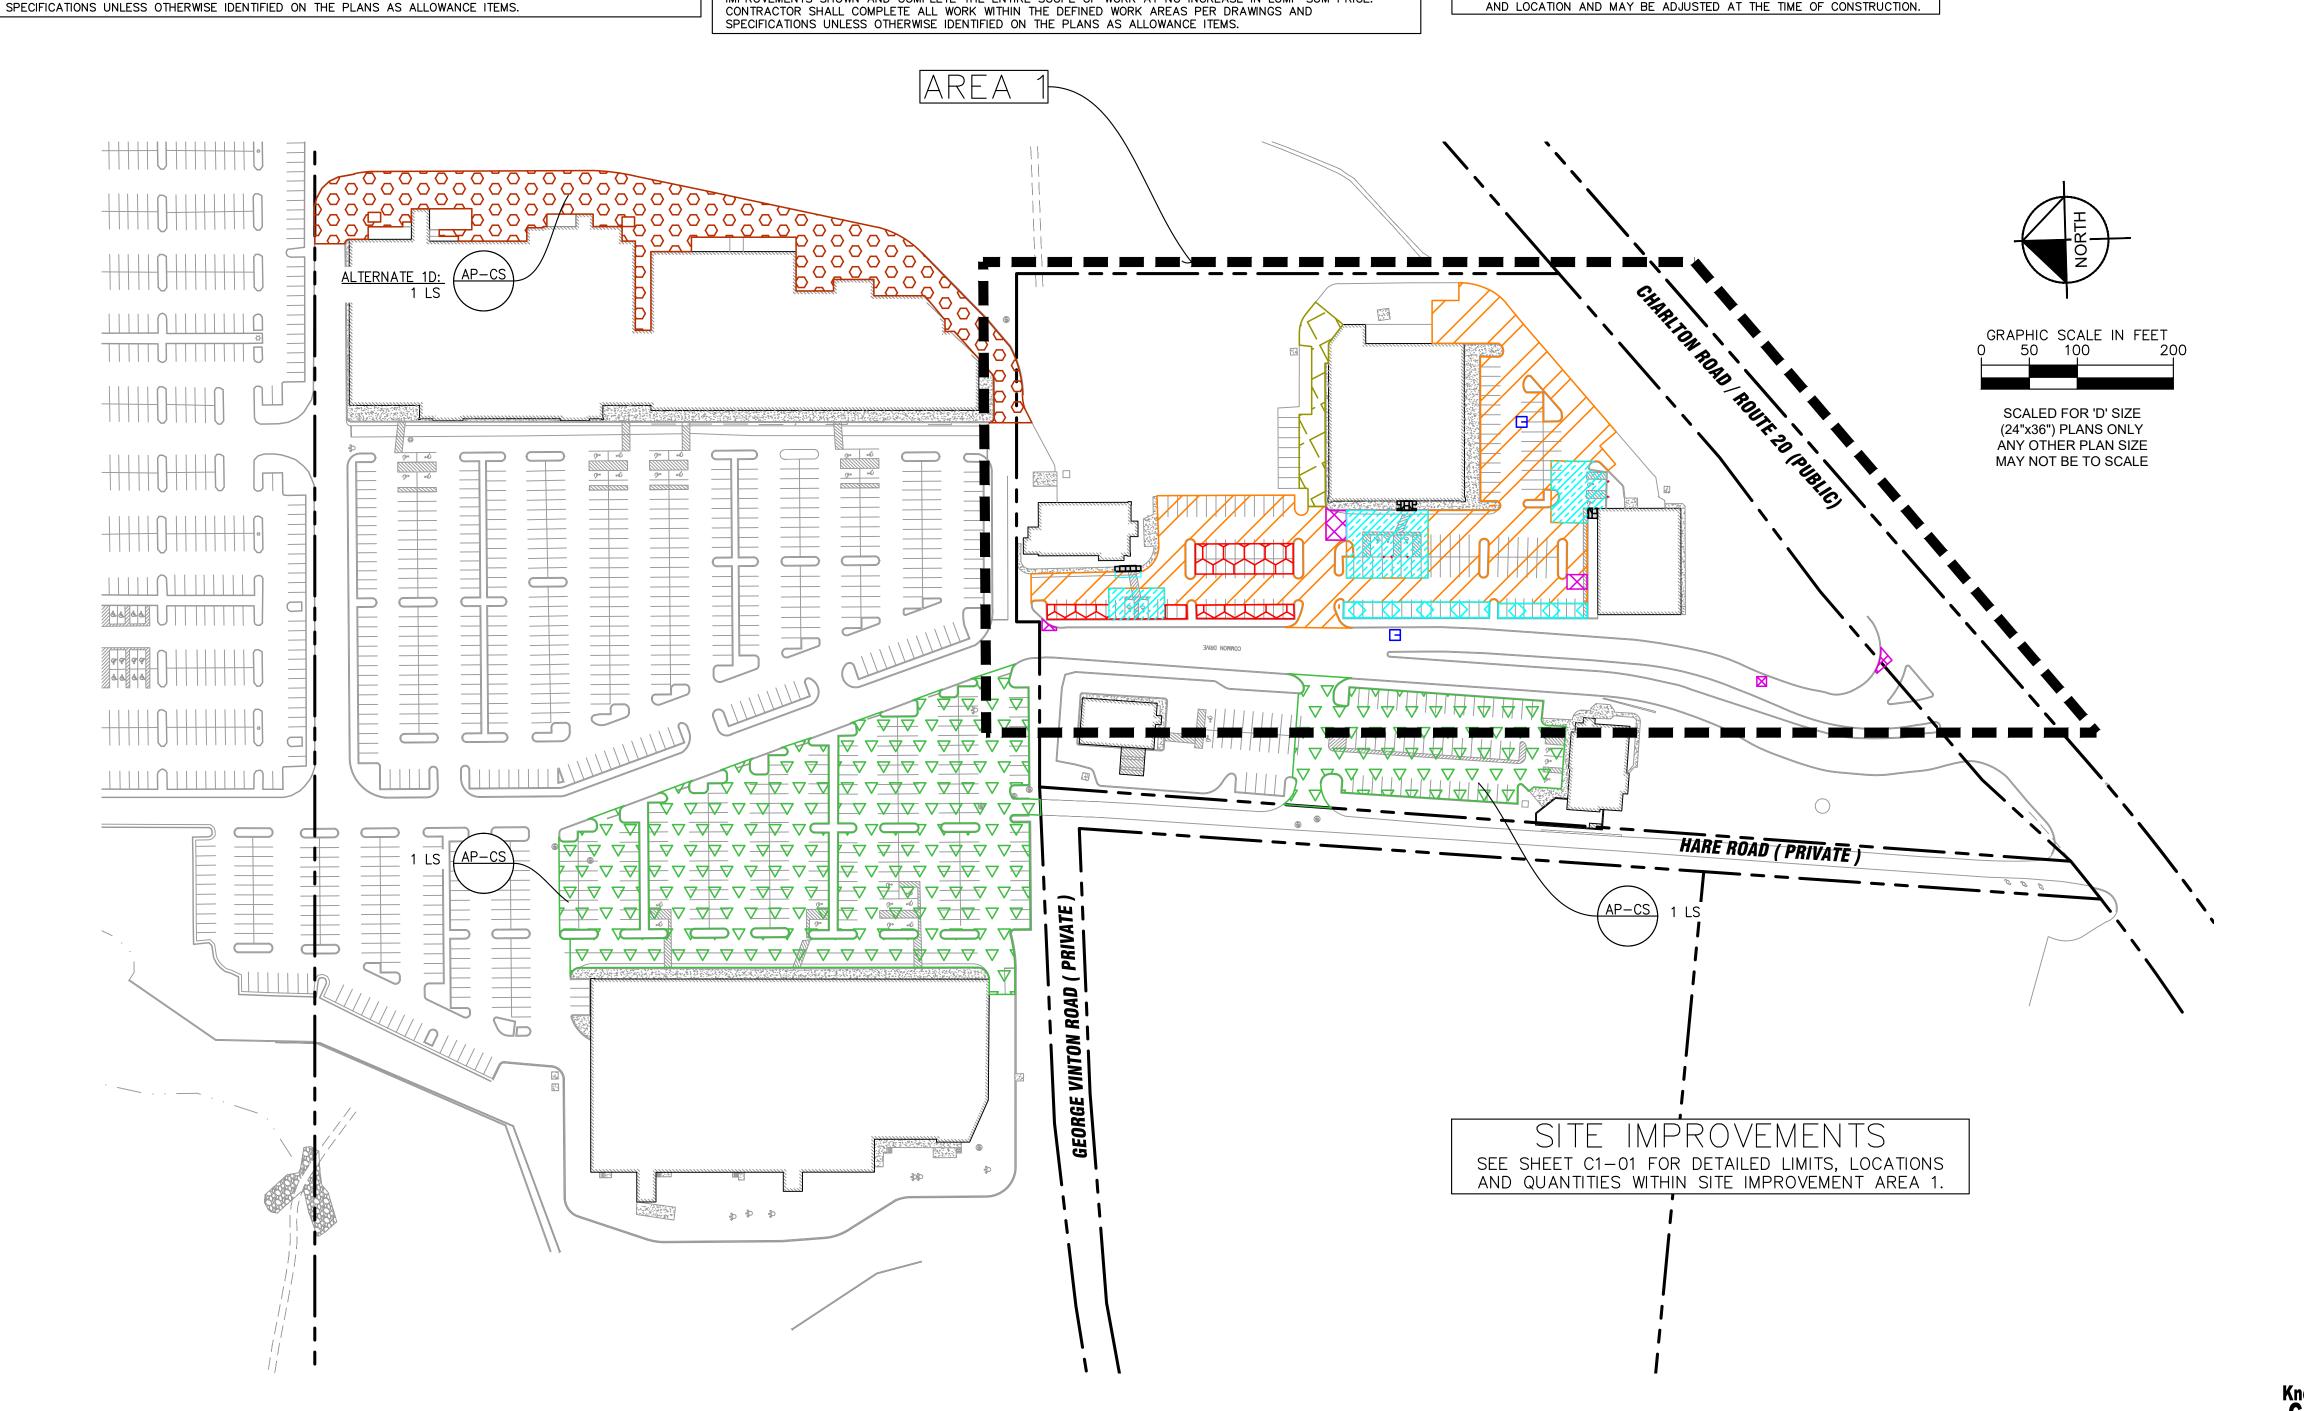

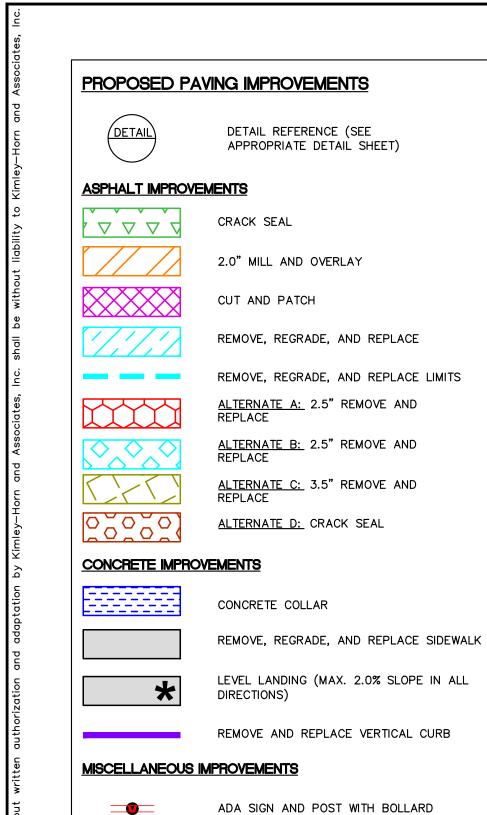

REVISED STRIPING

* * * * * *

ADA SYMBOL WITH BACKGROUND

REGRADE AND RESTORE LANDSCAPING


NOTE: INCIDENTAL CONSTRUCTION TO BE INCLUDED IN PAVING IMPROVEMENT LUMP SUM PRICES SHALL INCLUDE SOIL EROSION & SEDIMENTATION CONTROL, LANDSCAPING RESTORATION, TEMPORARILY REMOVING AND RESETTING CONCRETE BLOCKS OR OTHER PORTABLE DEVICES, REPLACEMENT OF PAVEMENT STRIPING AND PAVEMENT MARKINGS, STRUCTURE ADJUSTMENTS, PERMITS, AND PROVIDING BARRIER-FREE DOCUMENTATION OF COMPLETED WORK. APPROXIMATE LOCATIONS OF INCIDENTAL CONSTRUCTION ARE SHOWN WHERE APPLICABLE. QUANTITY MAY INCREASE OR DECREASE WHERE FOUND NECESSARY UPON SITE REVIEW WITH DESIGN CONSULTANT OR

OWNER.

THIS PLAN SET IS BASED ON AUTOCAD FILES OBTAINED BY KIMLEY—HORN AND ASSOCIATES, INC. FROM CIM GROUP

DRAWING RECEIVED ON: JULY 27, 2016
THE CONTRACTOR IS SPECIFICALLY CAUTIONED THAT THE EXISTING INFORMATION SHOWN ON THESE PLANS IS NOT TO BE RELIED ON AS BEING EXACT OR COMPLETE. THE CONTRACTOR WILL BE RESPONSIBLE FOR FIELD VERIFYING EXISTING SITE CONDITIONS BEFORE COMMENCING CONSTRUCTION. THE CONTRACTOR MUST ALSO CALL 811 AT LEAST 72 HOURS BEFORE ANY EXCAVATION TO REQUEST

EXACT FIELD LOCATION OF UTILITIES.

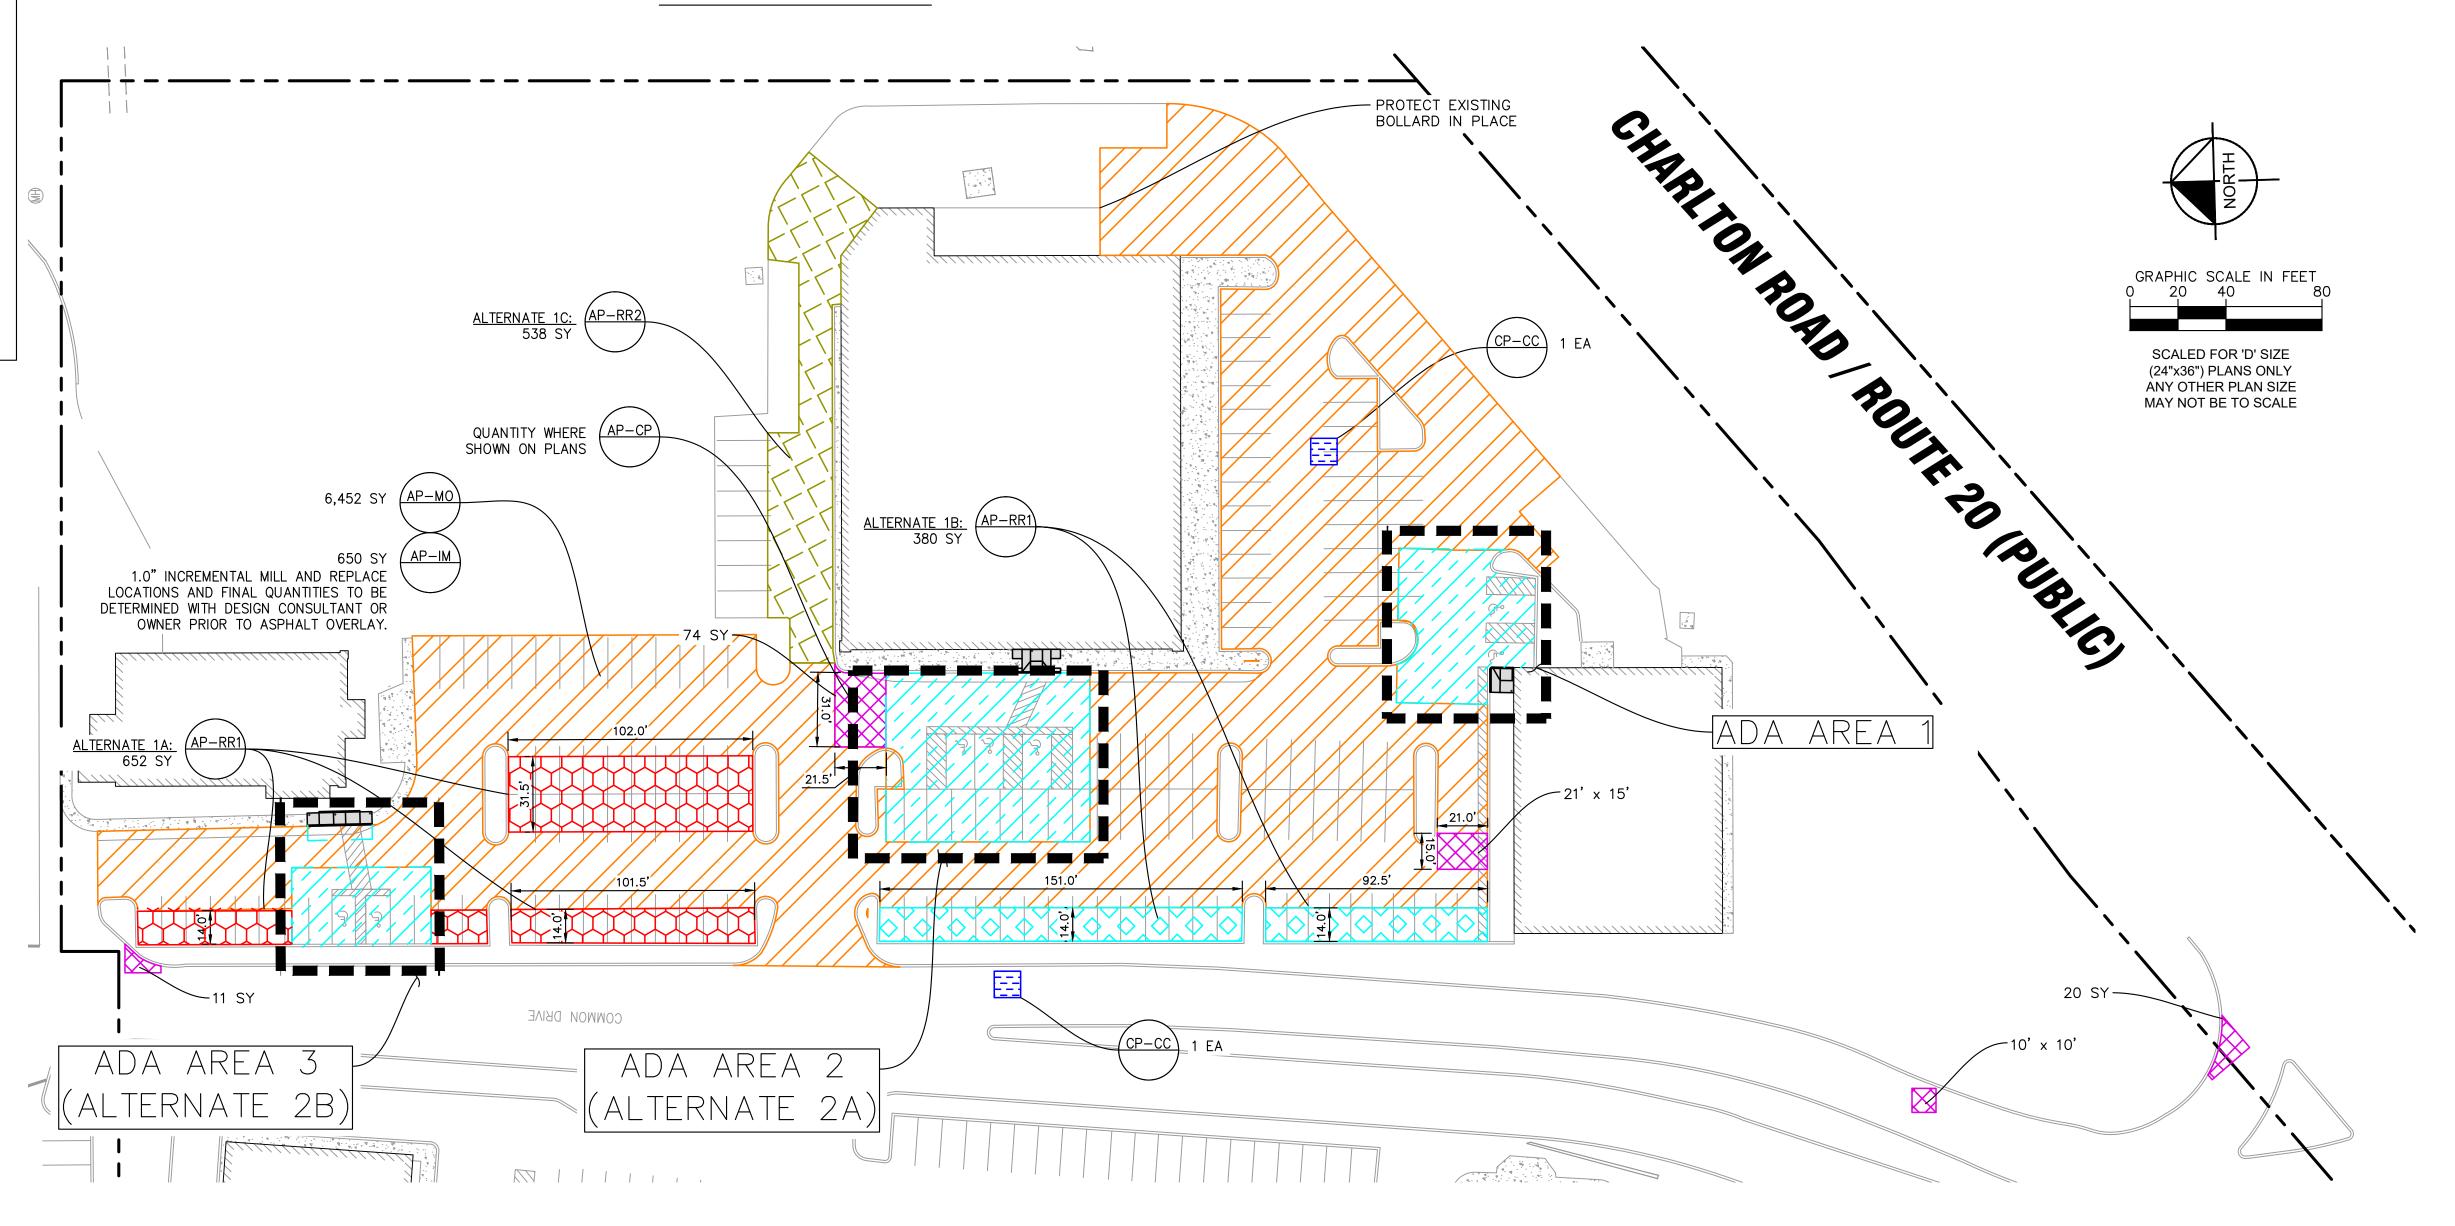




AT OK MA THE CENTER / HOBBS BROC STURBRIDGE, I

IMPROVEMENTS

SITE

SHEET NUMBER C1-00

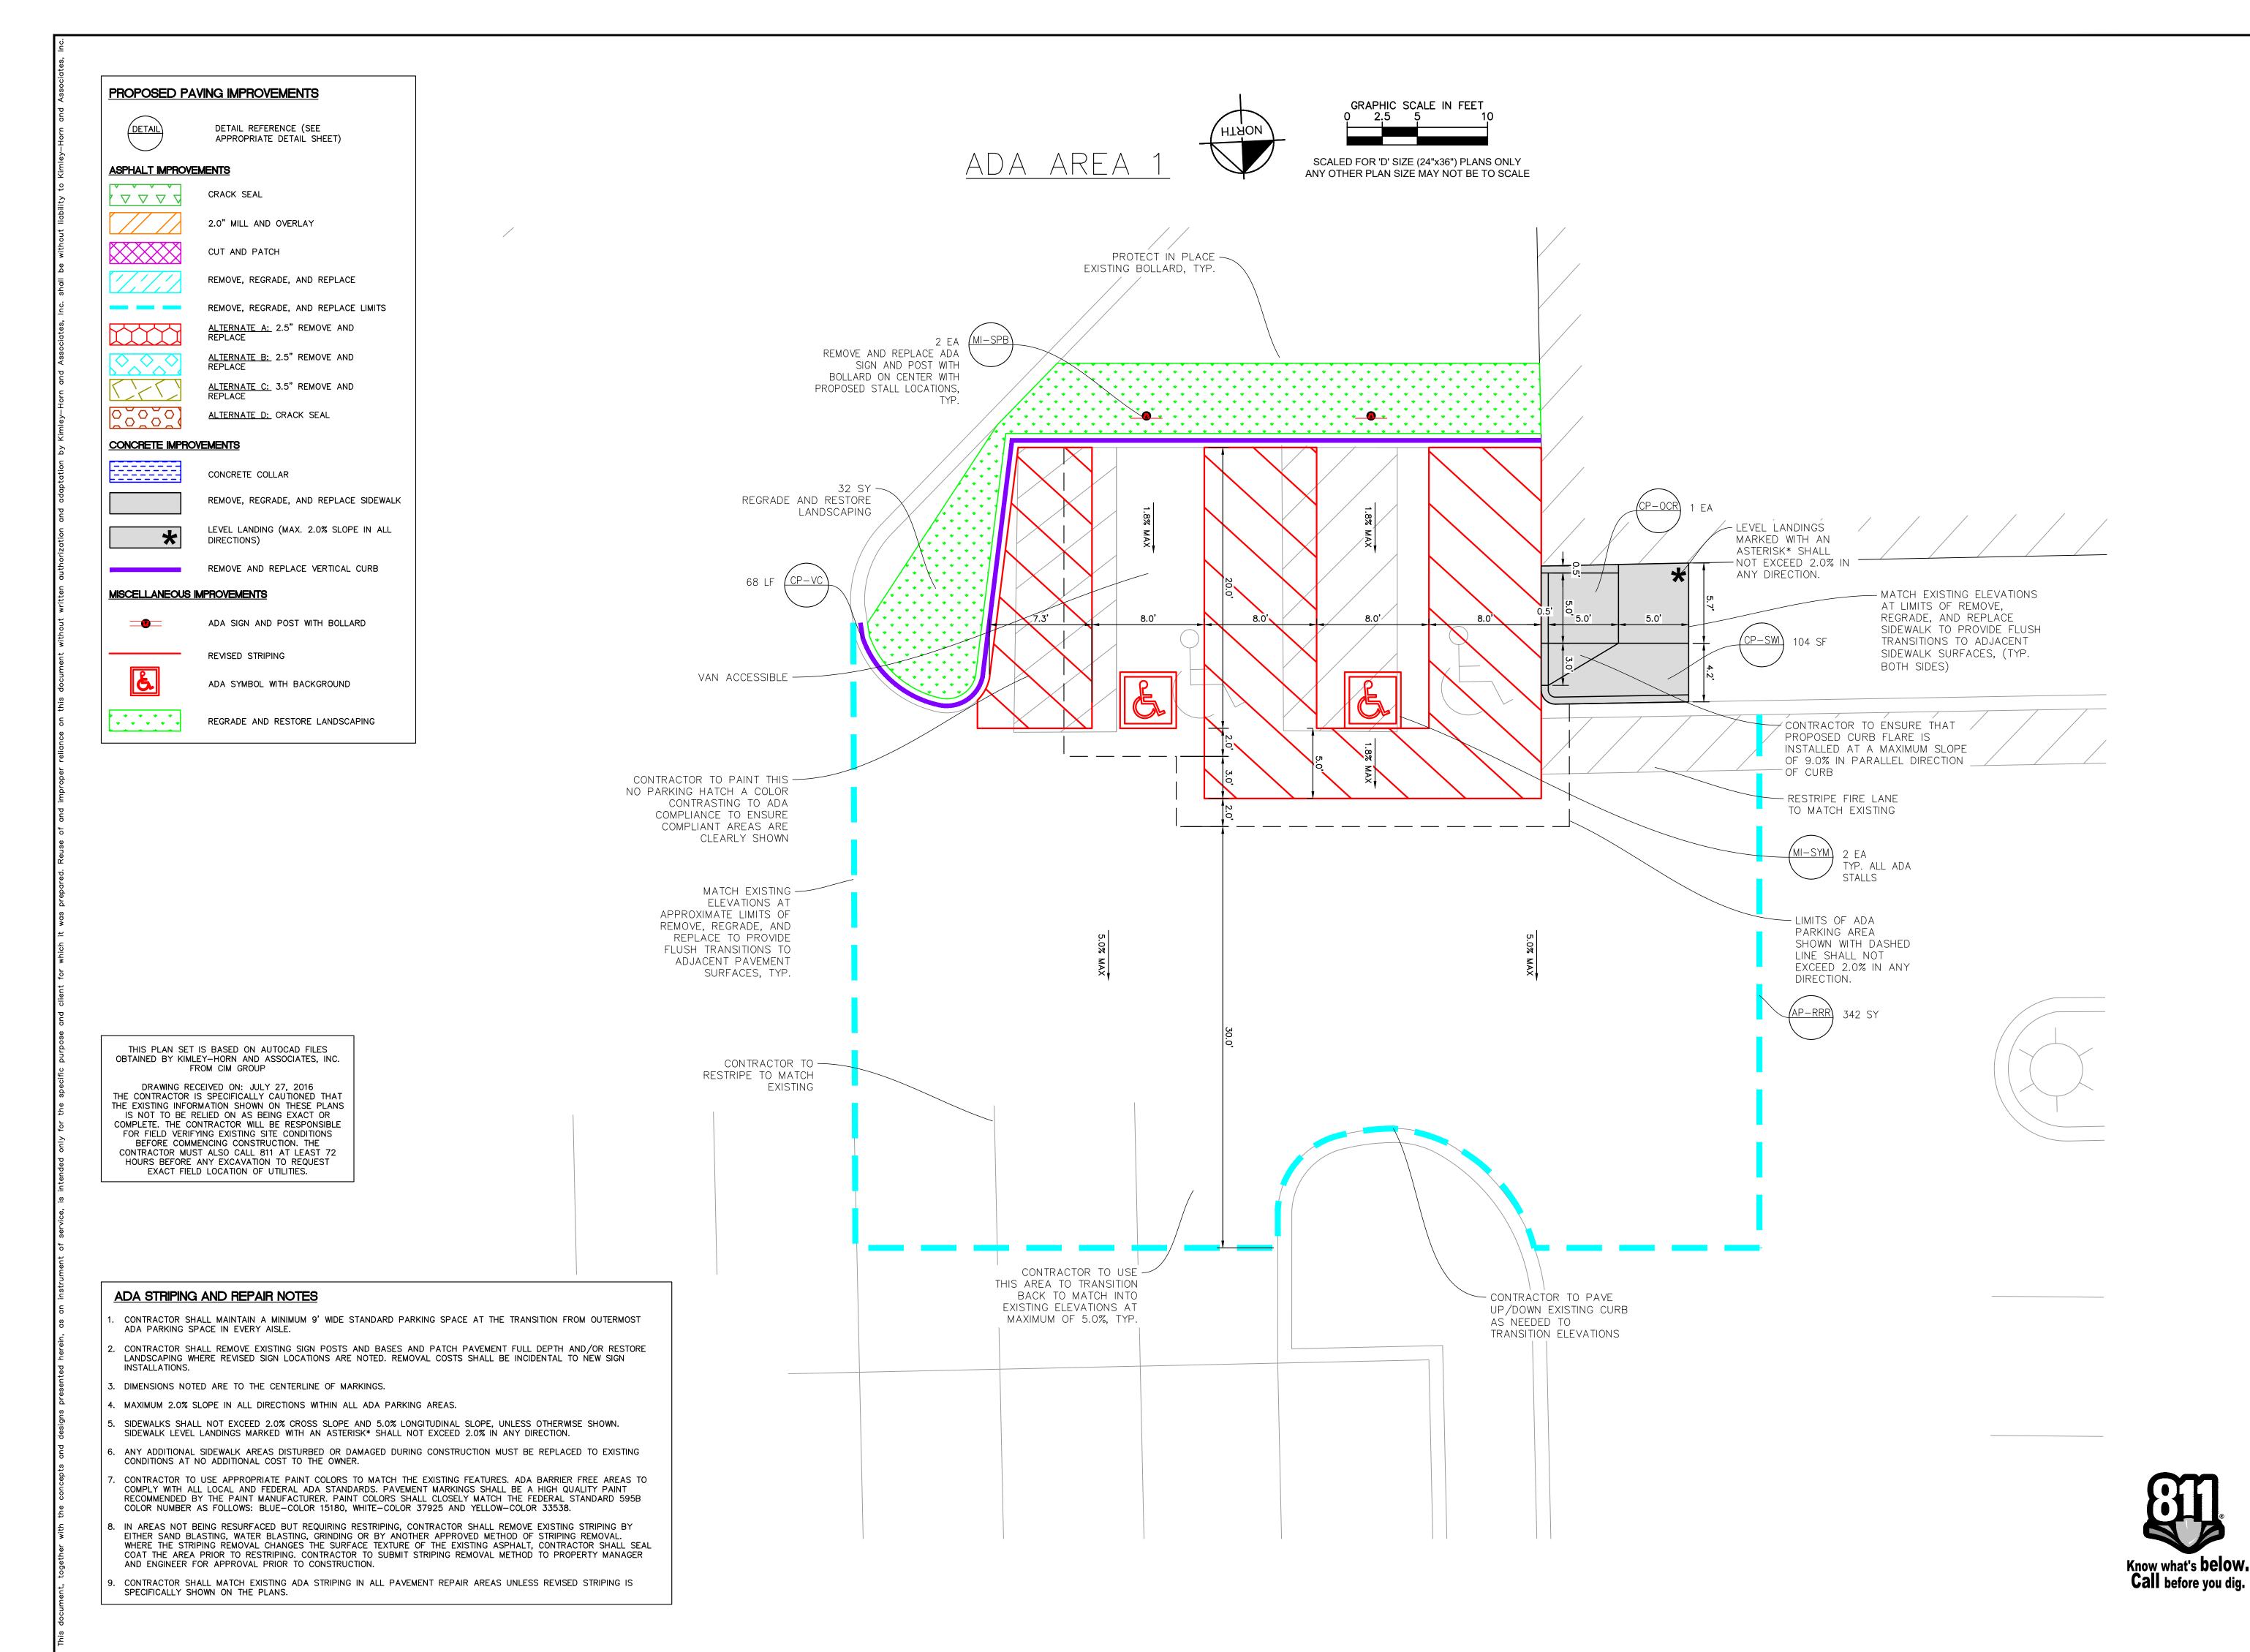

AND ASSOCIATES, INC.
UITE 350, LISLE, IL 60532
-487-5550
-HORN.COM

© 2020 KIMLEY-HORN
1001 WARRENVILLE ROAD, \$


DAIE
04/04/2020
SCALE AS SHOWN
DESIGNED BY ATO
DRAWN BY ATO

DA IMPROVEMENTS


THE CENTER AT HOBBS BROOK STURBRIDGE, MA

SHEET NUMBER

C1-02

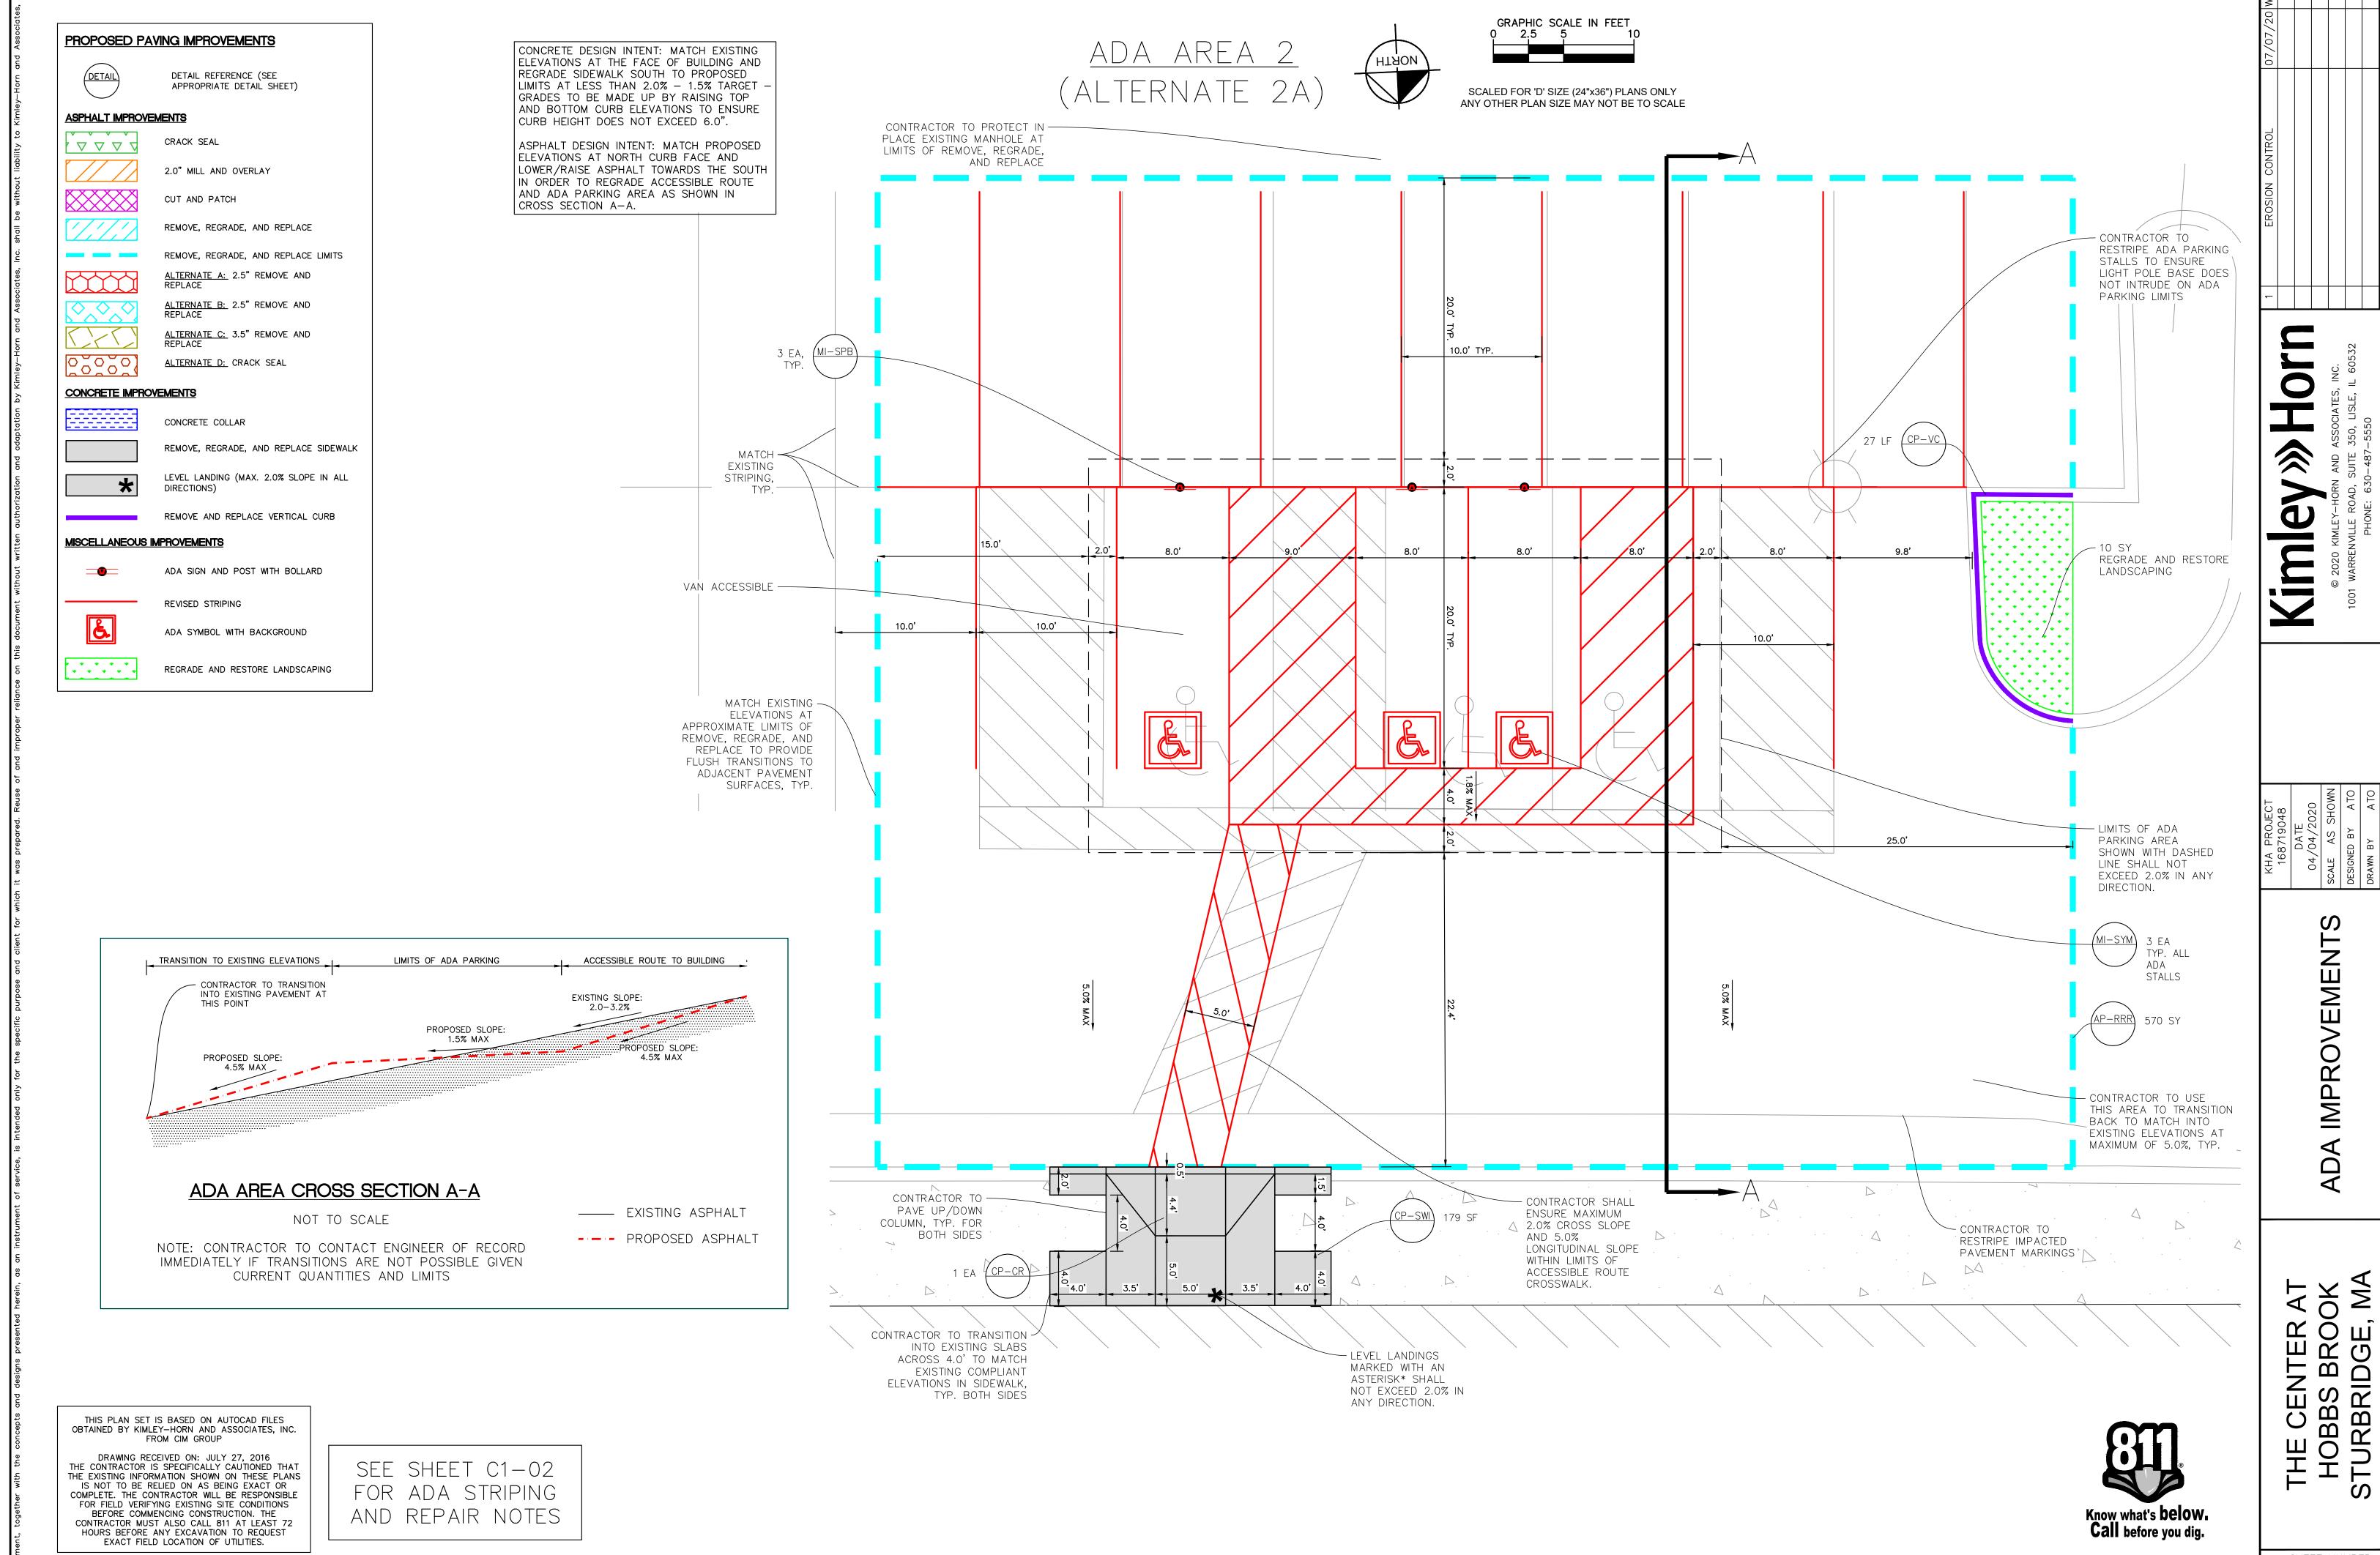

C1-03

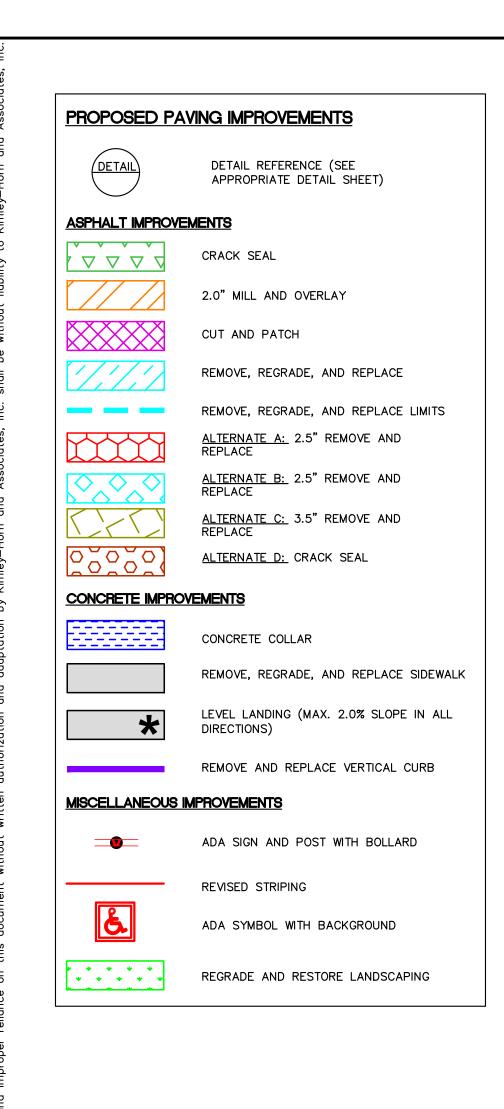

INSTALLATIONS.

THIS PLAN SET IS BASED ON AUTOCAD FILES

OBTAINED BY KIMLEY-HORN AND ASSOCIATES, INC.

FROM CIM GROUP

DRAWING RECEIVED ON: JULY 27, 2016 THE CONTRACTOR IS SPECIFICALLY CAUTIONED THAT

THE EXISTING INFORMATION SHOWN ON THESE PLANS

IS NOT TO BE RELIED ON AS BEING EXACT OR

FOR FIELD VERIFYING EXISTING SITE CONDITIONS

BEFORE COMMENCING CONSTRUCTION. THE CONTRACTOR MUST ALSO CALL 811 AT LEAST 72 HOURS BEFORE ANY EXCAVATION TO REQUEST

EXACT FIELD LOCATION OF UTILITIES.

COMPLETE. THE CONTRACTOR WILL BE RESPONSIBLE

CONDITIONS AT NO ADDITIONAL COST TO THE OWNER.

AND ENGINEER FOR APPROVAL PRIOR TO CONSTRUCTION.

SPECIFICALLY SHOWN ON THE PLANS.

ANY ADDITIONAL SIDEWALK AREAS DISTURBED OR DAMAGED DURING CONSTRUCTION MUST BE REPLACED TO EXISTING

COMPLY WITH ALL LOCAL AND FEDERAL ADA STANDARDS. PAVEMENT MARKINGS SHALL BE A HIGH QUALITY PAINT

IN AREAS NOT BEING RESURFACED BUT REQUIRING RESTRIPING, CONTRACTOR SHALL REMOVE EXISTING STRIPING BY

CONTRACTOR SHALL MATCH EXISTING ADA STRIPING IN ALL PAVEMENT REPAIR AREAS UNLESS REVISED STRIPING IS

EITHER SAND BLASTING, WATER BLASTING, GRINDING OR BY ANOTHER APPROVED METHOD OF STRIPING REMOVAL.


COLOR NUMBER AS FOLLOWS: BLUE-COLOR 15180, WHITE-COLOR 37925 AND YELLOW-COLOR 33538.


CONTRACTOR TO USE APPROPRIATE PAINT COLORS TO MATCH THE EXISTING FEATURES. ADA BARRIER FREE AREAS TO

RECOMMENDED BY THE PAINT MANUFACTURER. PAINT COLORS SHALL CLOSELY MATCH THE FEDERAL STANDARD 595B

WHERE THE STRIPING REMOVAL CHANGES THE SURFACE TEXTURE OF THE EXISTING ASPHALT, CONTRACTOR SHALL SEAL

COAT THE AREA PRIOR TO RESTRIPING. CONTRACTOR TO SUBMIT STRIPING REMOVAL METHOD TO PROPERTY MANAGER

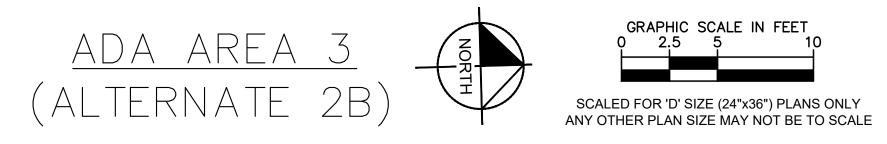

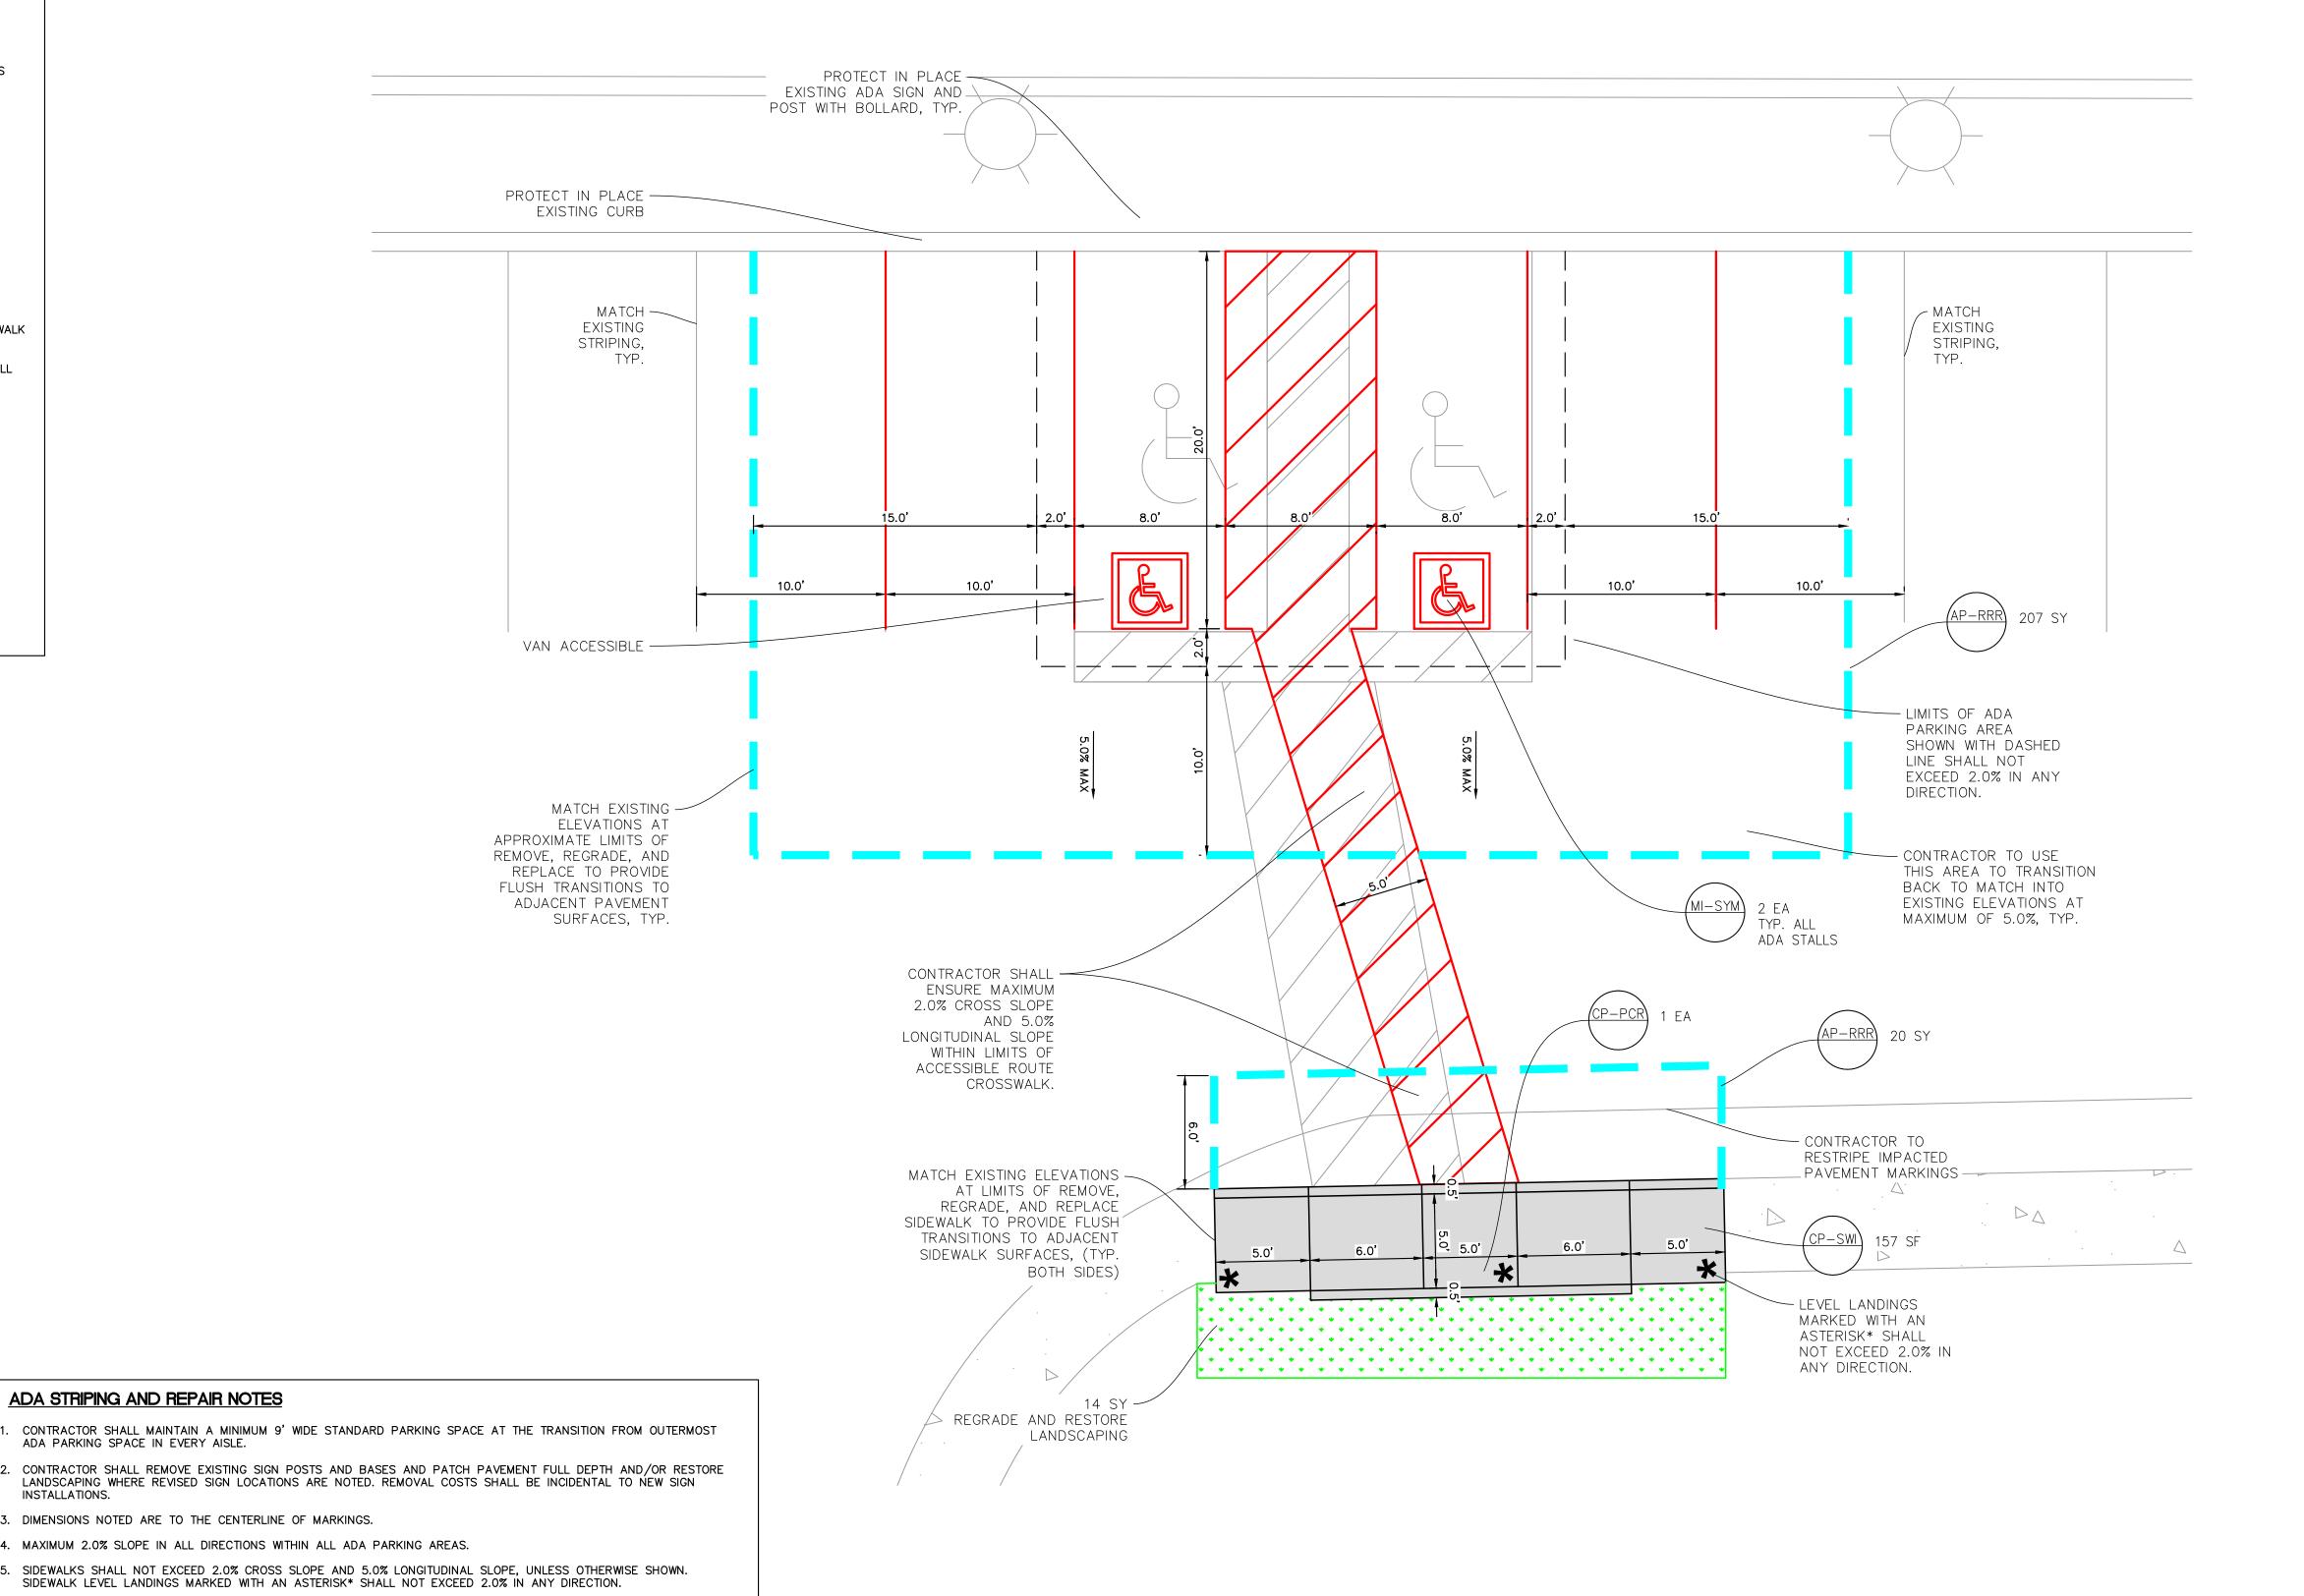



 $A \ge 1$

Ощ

HOBBS BI


ШÃ Ū


 $\mathbf{\Omega}$

里

SHEET NUMBER C1-04

IMPROVEMEN

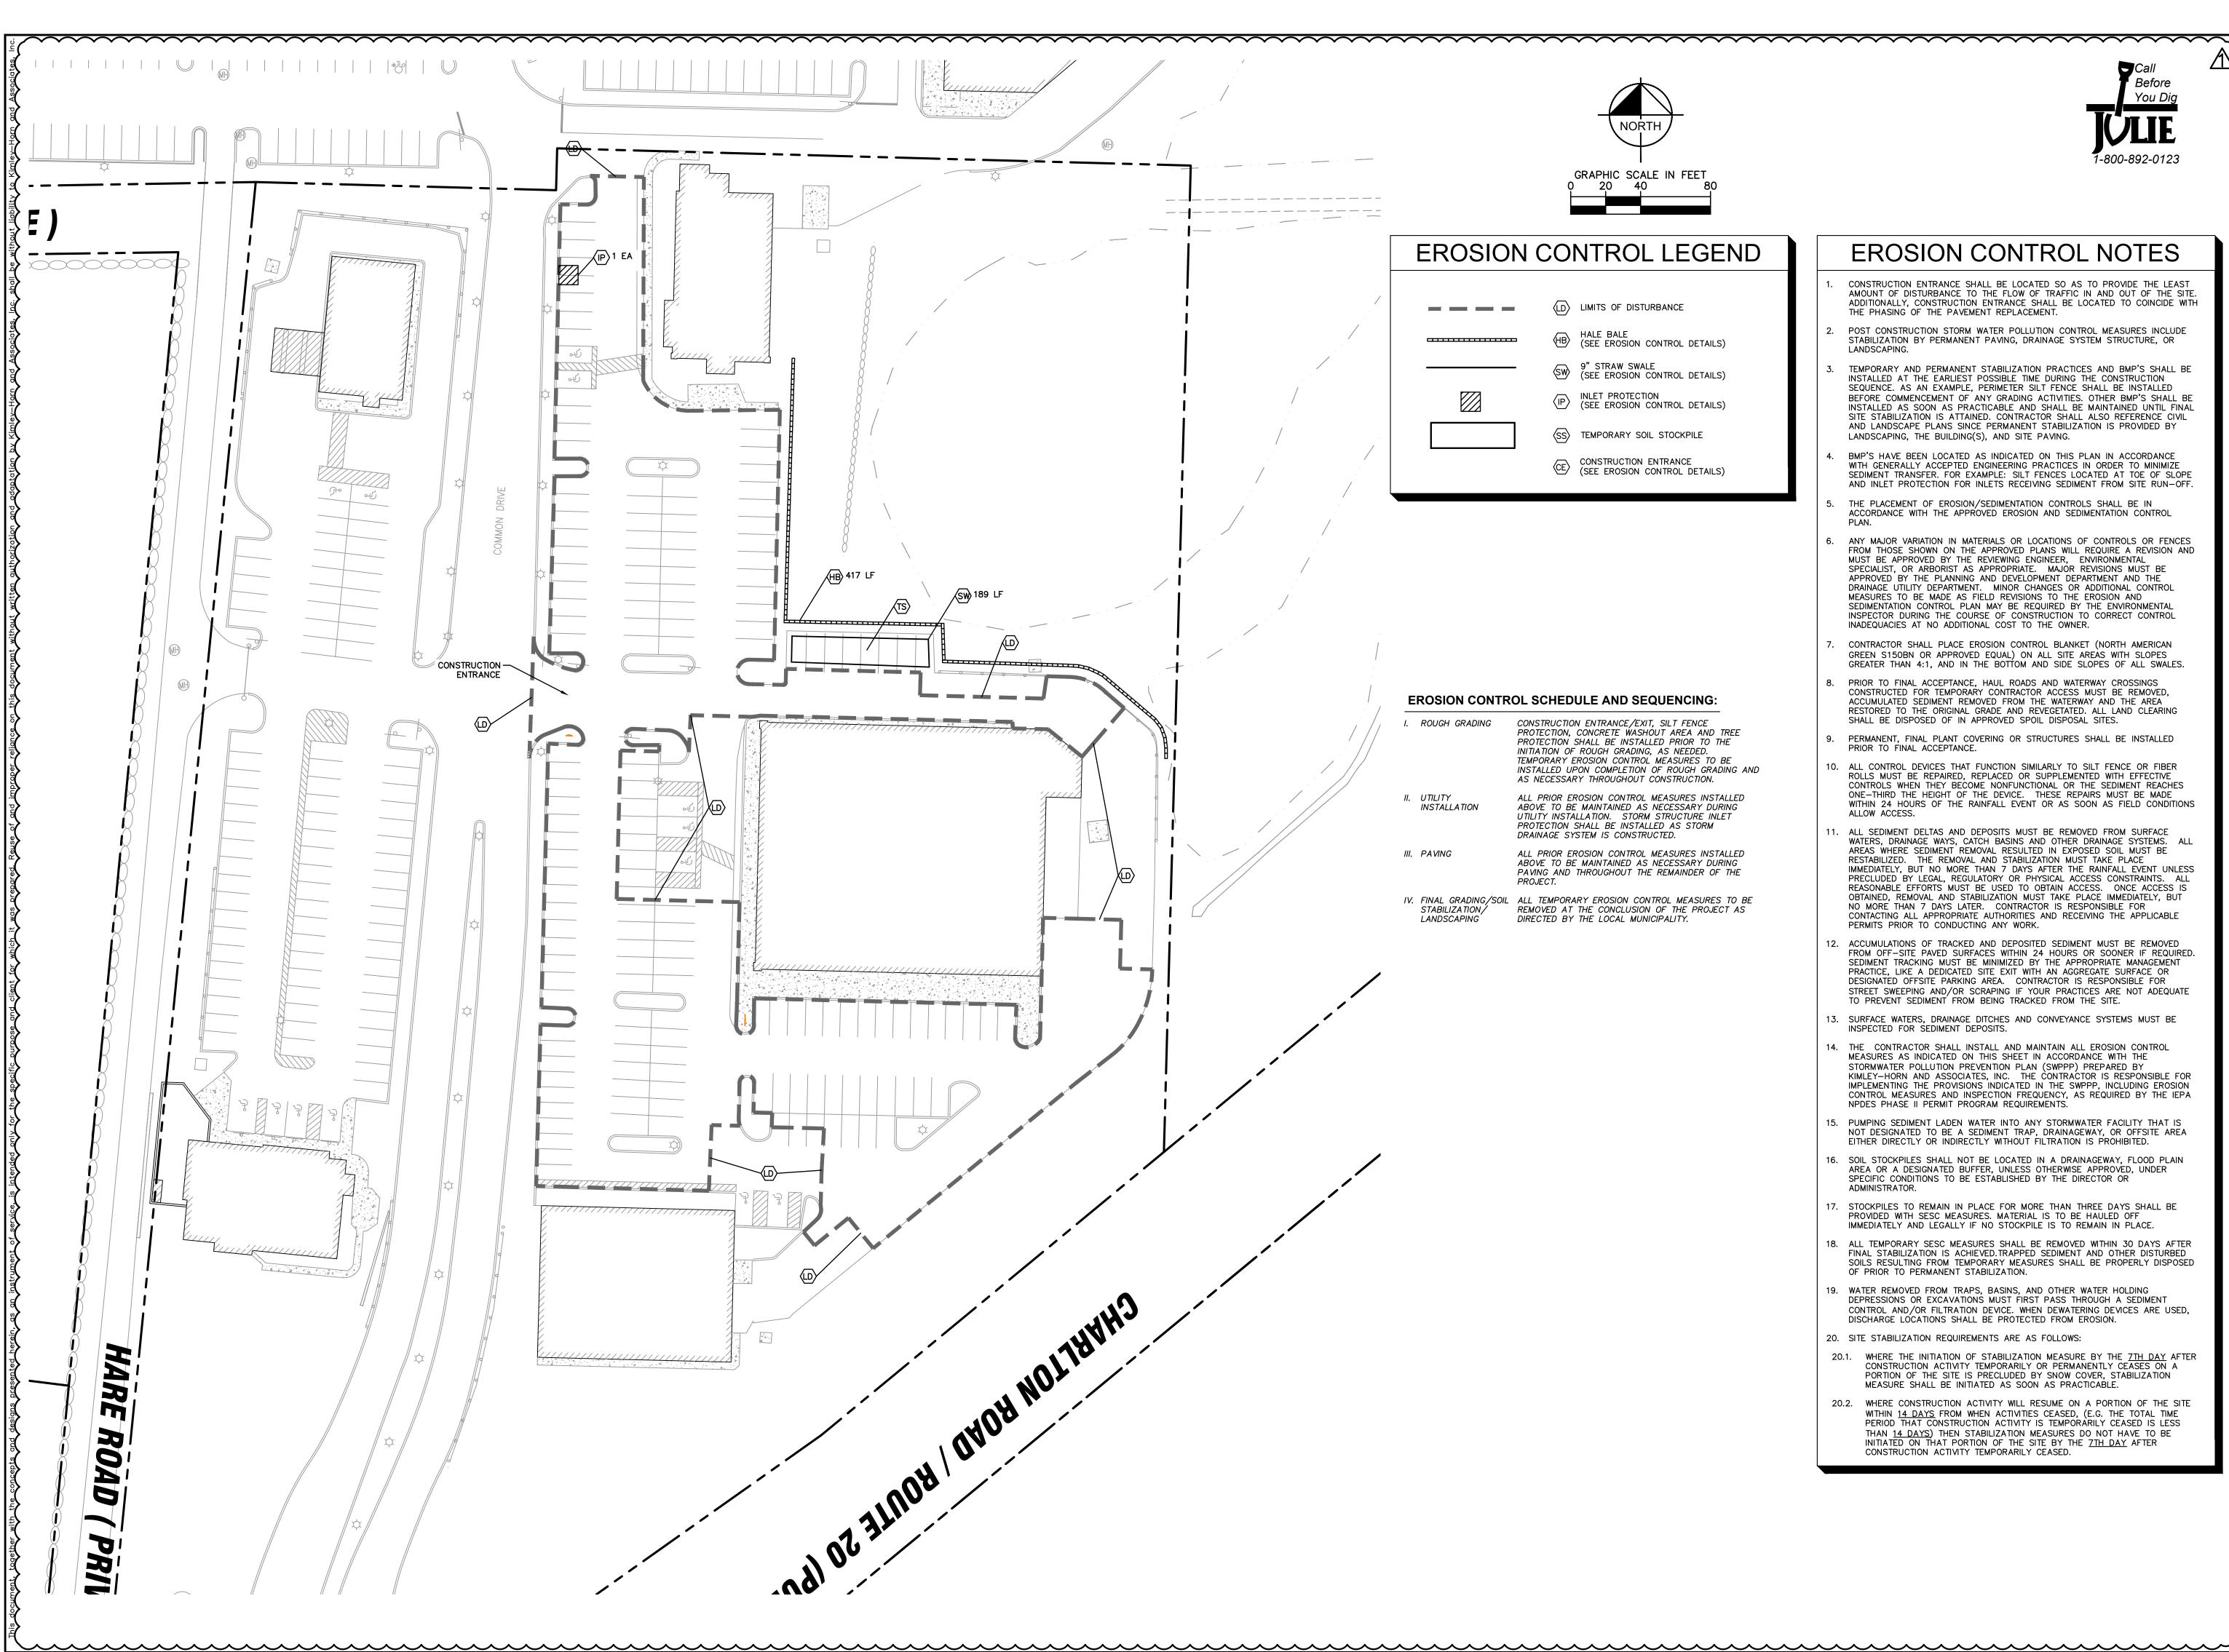

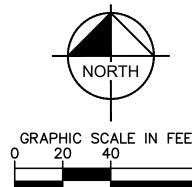

THROUGHOUT THE REMAINDER OF THE



CONSTRUCTION ENTRANCE SHALL BE LOCATED SO AS TO PROVIDE THE LEAST AMOUNT OF DISTURBANCE TO THE FLOW OF TRAFFIC IN AND OUT OF THE SITE. ADDITIONALLY, CONSTRUCTION ENTRANCE SHALL BE LOCATED TO COINCIDE WITH

- POST CONSTRUCTION STORM WATER POLLUTION CONTROL MEASURES INCLUDE STABILIZATION BY PERMANENT PAVING, DRAINAGE SYSTEM STRUCTURE, OR
- INSTALLED AT THE EARLIEST POSSIBLE TIME DURING THE CONSTRUCTION SEQUENCE. AS AN EXAMPLE, PERIMETER SILT FENCE SHALL BE INSTALLED BEFORE COMMENCEMENT OF ANY GRADING ACTIVITIES. OTHER BMP'S SHALL BE INSTALLED AS SOON AS PRACTICABLE AND SHALL BE MAINTAINED UNTIL FINAL SITE STABILIZATION IS ATTAINED. CONTRACTOR SHALL ALSO REFERENCE CIVIL AND LANDSCAPE PLANS SINCE PERMANENT STABILIZATION IS PROVIDED BY
- WITH GENERALLY ACCEPTED ENGINEERING PRACTICES IN ORDER TO MINIMIZE SEDIMENT TRANSFER. FOR EXAMPLE: SILT FENCES LOCATED AT TOE OF SLOPE AND INLET PROTECTION FOR INLETS RECEIVING SEDIMENT FROM SITE RUN-OFF
- THE PLACEMENT OF EROSION/SEDIMENTATION CONTROLS SHALL BE IN ACCORDANCE WITH THE APPROVED EROSION AND SEDIMENTATION CONTROL
- ANY MAJOR VARIATION IN MATERIALS OR LOCATIONS OF CONTROLS OR FENCES FROM THOSE SHOWN ON THE APPROVED PLANS WILL REQUIRE A REVISION AND MUST BE APPROVED BY THE REVIEWING ENGINEER, ENVIRONMENTAL SPECIALIST. OR ARBORIST AS APPROPRIATE. MAJOR REVISIONS MUST BE APPROVED BY THE PLANNING AND DEVELOPMENT DEPARTMENT AND THE DRAINAGE UTILITY DEPARTMENT. MINOR CHANGES OR ADDITIONAL CONTROL MEASURES TO BE MADE AS FIELD REVISIONS TO THE EROSION AND SEDIMENTATION CONTROL PLAN MAY BE REQUIRED BY THE ENVIRONMENTAL
- GREEN S150BN OR APPROVED EQUAL) ON ALL SITE AREAS WITH SLOPES
- PRIOR TO FINAL ACCEPTANCE, HAUL ROADS AND WATERWAY CROSSINGS CONSTRUCTED FOR TEMPORARY CONTRACTOR ACCESS MUST BE REMOVED, ACCUMULATED SEDIMENT REMOVED FROM THE WATERWAY AND THE AREA RESTORED TO THE ORIGINAL GRADE AND REVEGETATED. ALL LAND CLEARING
- PERMANENT, FINAL PLANT COVERING OR STRUCTURES SHALL BE INSTALLED PRIOR TO FINAL ACCEPTANCE.
- ROLLS MUST BE REPAIRED, REPLACED OR SUPPLEMENTED WITH EFFECTIVE CONTROLS WHEN THEY BECOME NONFUNCTIONAL OR THE SEDIMENT REACHES ONE-THIRD THE HEIGHT OF THE DEVICE. THESE REPAIRS MUST BE MADE WITHIN 24 HOURS OF THE RAINFALL EVENT OR AS SOON AS FIELD CONDITIONS
- ALL SEDIMENT DELTAS AND DEPOSITS MUST BE REMOVED FROM SURFACE WATERS, DRAINAGE WAYS, CATCH BASINS AND OTHER DRAINAGE SYSTEMS. ALL AREAS WHERE SEDIMENT REMOVAL RESULTED IN EXPOSED SOIL MUST BE RESTABILIZED. THE REMOVAL AND STABILIZATION MUST TAKE PLACE IMMEDIATELY, BUT NO MORE THAN 7 DAYS AFTER THE RAINFALL EVENT UNLESS PRECLUDED BY LEGAL, REGULATORY OR PHYSICAL ACCESS CONSTRAINTS. ALL REASONABLE EFFORTS MUST BE USED TO OBTAIN ACCESS. ONCE ACCESS IS OBTAINED, REMOVAL AND STABILIZATION MUST TAKE PLACE IMMEDIATELY, BUT NO MORE THAN 7 DAYS LATER. CONTRACTOR IS RESPONSIBLE FOR CONTACTING ALL APPROPRIATE AUTHORITIES AND RECEIVING THE APPLICABLE PERMITS PRIOR TO CONDUCTING ANY WORK.
- FROM OFF-SITE PAVED SURFACES WITHIN 24 HOURS OR SOONER IF REQUIRED. SEDIMENT TRACKING MUST BE MINIMIZED BY THE APPROPRIATE MANAGEMENT PRACTICE, LIKE A DEDICATED SITE EXIT WITH AN AGGREGATE SURFACE OR DESIGNATED OFFSITE PARKING AREA. CONTRACTOR IS RESPONSIBLE FOR STREET SWEEPING AND/OR SCRAPING IF YOUR PRACTICES ARE NOT ADEQUATE
- 13. SURFACE WATERS, DRAINAGE DITCHES AND CONVEYANCE SYSTEMS MUST BE INSPECTED FOR SEDIMENT DEPOSITS.
- 14. THE CONTRACTOR SHALL INSTALL AND MAINTAIN ALL EROSION CONTROL MEASURES AS INDICATED ON THIS SHEET IN ACCORDANCE WITH THE STORMWATER POLLUTION PREVENTION PLAN (SWPPP) PREPARED BY KIMLEY-HORN AND ASSOCIATES, INC. THE CONTRACTOR IS RESPONSIBLE FOR IMPLEMENTING THE PROVISIONS INDICATED IN THE SWPPP, INCLUDING EROSION CONTROL MEASURES AND INSPECTION FREQUENCY, AS REQUIRED BY THE IEPA NPDES PHASE II PERMIT PROGRAM REQUIREMENTS.
- SPECIFIC CONDITIONS TO BE ESTABLISHED BY THE DIRECTOR OR
- DEPRESSIONS OR EXCAVATIONS MUST FIRST PASS THROUGH A SEDIMENT CONTROL AND/OR FILTRATION DEVICE. WHEN DEWATERING DEVICES ARE USED, DISCHARGE LOCATIONS SHALL BE PROTECTED FROM EROSION.
- CONSTRUCTION ACTIVITY TEMPORARILY OR PERMANENTLY CEASES ON A PORTION OF THE SITE IS PRECLUDED BY SNOW COVER, STABILIZATION MEASURE SHALL BE INITIATED AS SOON AS PRACTICABLE.
- 20.2. WHERE CONSTRUCTION ACTIVITY WILL RESUME ON A PORTION OF THE SITE WITHIN 14 DAYS FROM WHEN ACTIVITIES CEASED, (E.G. THE TOTAL TIME PERIOD THAT CONSTRUCTION ACTIVITY IS TEMPORARILY CEASED IS LESS THAN <u>14 DAYS</u>) THEN STABILIZATION MEASURES DO NOT HAVE TO BE INITIATED ON THAT PORTION OF THE SITE BY THE <u>7TH DAY</u> AFTER CONSTRUCTION ACTIVITY TEMPORARILY CEASED.

EROSION CONTROL NOTES

THE PHASING OF THE PAVEMENT REPLACEMENT.

TEMPORARY AND PERMANENT STABILIZATION PRACTICES AND BMP'S SHALL BE

LANDSCAPING, THE BUILDING(S), AND SITE PAVING.

BMP'S HAVE BEEN LOCATED AS INDICATED ON THIS PLAN IN ACCORDANCE

INSPECTOR DURING THE COURSE OF CONSTRUCTION TO CORRECT CONTROL INADEQUACIES AT NO ADDITIONAL COST TO THE OWNER.

CONTRACTOR SHALL PLACE EROSION CONTROL BLANKET (NORTH AMERICAN GREATER THAN 4:1, AND IN THE BOTTOM AND SIDE SLOPES OF ALL SWALES.

SHALL BE DISPOSED OF IN APPROVED SPOIL DISPOSAL SITES.

10. ALL CONTROL DEVICES THAT FUNCTION SIMILARLY TO SILT FENCE OR FIBER

12. ACCUMULATIONS OF TRACKED AND DEPOSITED SEDIMENT MUST BE REMOVED TO PREVENT SEDIMENT FROM BEING TRACKED FROM THE SITE.


- 15. PUMPING SEDIMENT LADEN WATER INTO ANY STORMWATER FACILITY THAT IS NOT DESIGNATED TO BE A SEDIMENT TRAP, DRAINAGEWAY, OR OFFSITE AREA EITHER DIRECTLY OR INDIRECTLY WITHOUT FILTRATION IS PROHIBITED.
- 16. SOIL STOCKPILES SHALL NOT BE LOCATED IN A DRAINAGEWAY, FLOOD PLAIN AREA OR A DESIGNATED BUFFER, UNLESS OTHERWISE APPROVED, UNDER
- 17. STOCKPILES TO REMAIN IN PLACE FOR MORE THAN THREE DAYS SHALL BE PROVIDED WITH SESC MEASURES. MATERIAL IS TO BE HAULED OFF IMMEDIATELY AND LEGALLY IF NO STOCKPILE IS TO REMAIN IN PLACE.
- 18. ALL TEMPORARY SESC MEASURES SHALL BE REMOVED WITHIN 30 DAYS AFTER FINAL STABILIZATION IS ACHIEVED.TRAPPED SEDIMENT AND OTHER DISTURBED SOILS RESULTING FROM TEMPORARY MEASURES SHALL BE PROPERLY DISPOSED OF PRIOR TO PERMANENT STABILIZATION.
- 19. WATER REMOVED FROM TRAPS, BASINS, AND OTHER WATER HOLDING
- 20. SITE STABILIZATION REQUIREMENTS ARE AS FOLLOWS:
- 20.1. WHERE THE INITIATION OF STABILIZATION MEASURE BY THE 7TH DAY AFTER

Ощ \Box

SHEET NUMBER

SILTSACK


PROTECT CATCH BASINS FROM SEDIMENT & TRASH

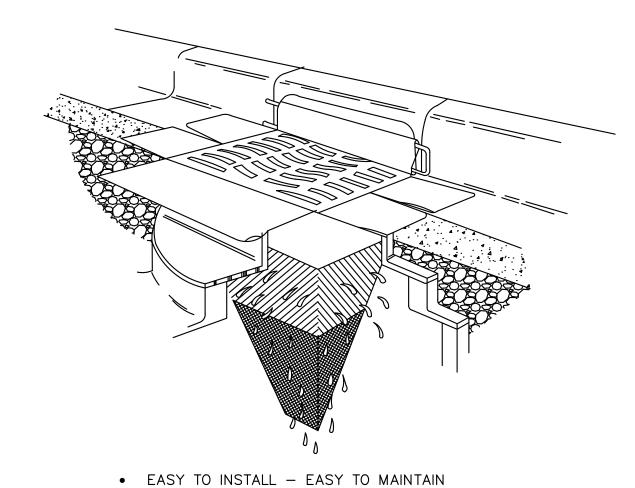


FABRICATED TO FIT ANY SIZE OR SHAPE PERMEABILITY OF 200 GPM/SF [HI—FLOW STYLE] REPLACES ALL ROCK OR GEOTEXTILES REUSABLE DETAIL

SILT SACK (OR APPROVED EQUAL)

ECONOMICAL

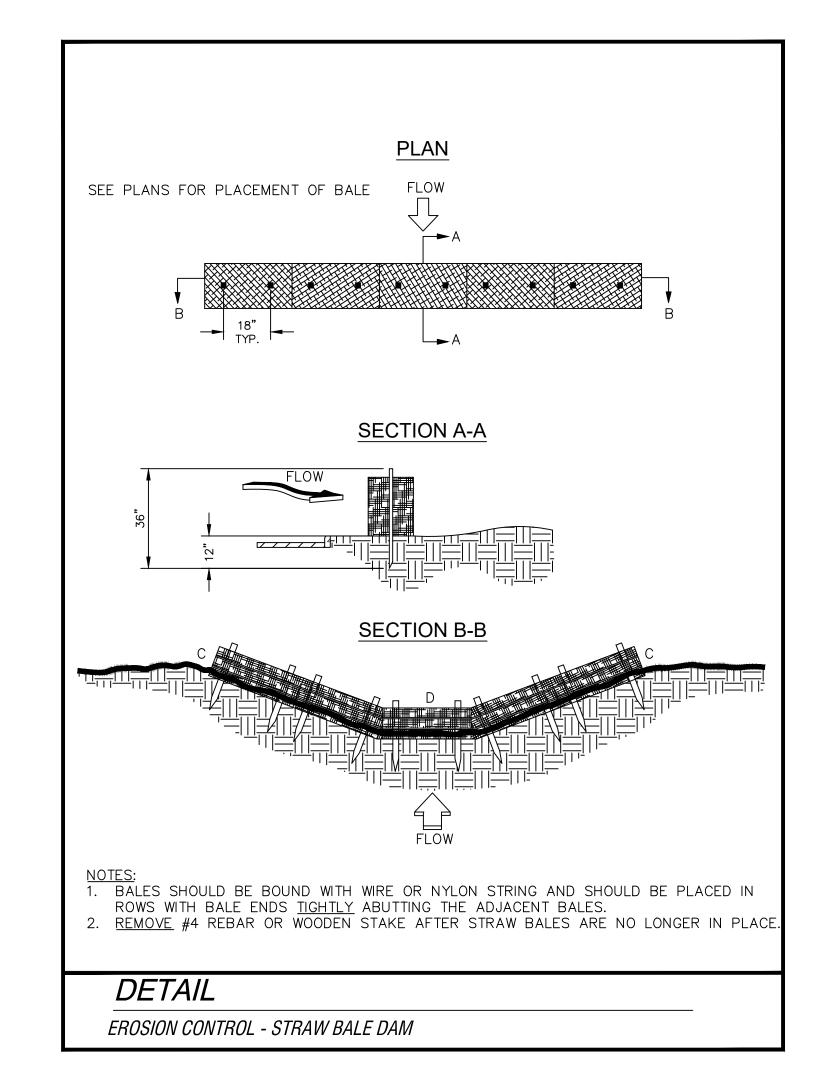

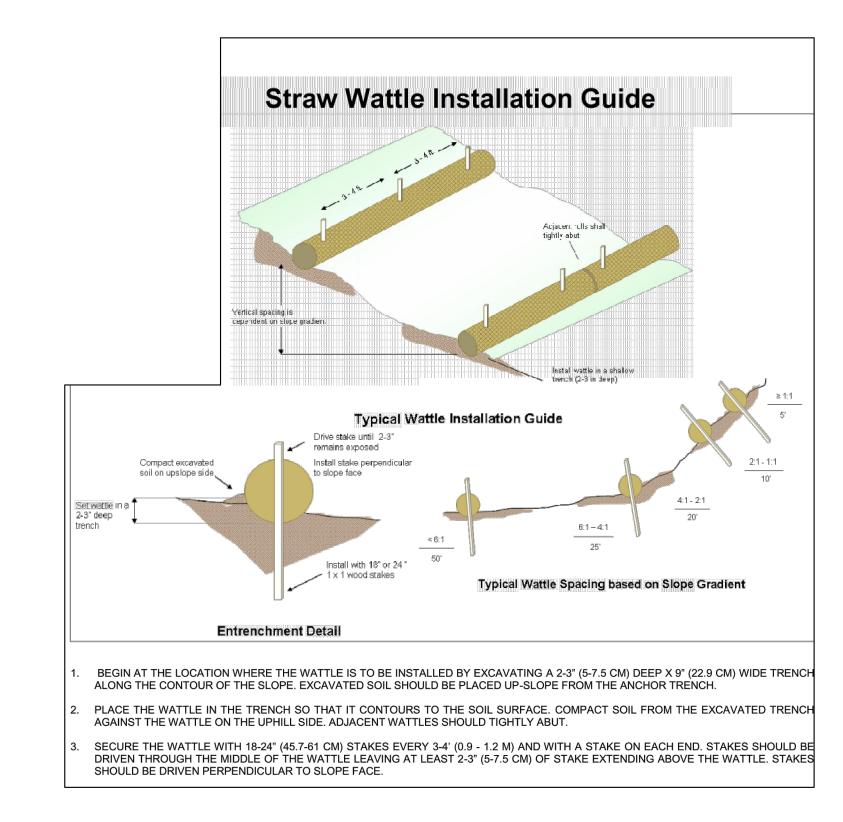


DETAIL

EROSION CONTROL - 9" DIAMETER WATTLE

SHEET NUMBER

SILTSACK


PROTECT CATCH BASINS FROM SEDIMENT & TRASH

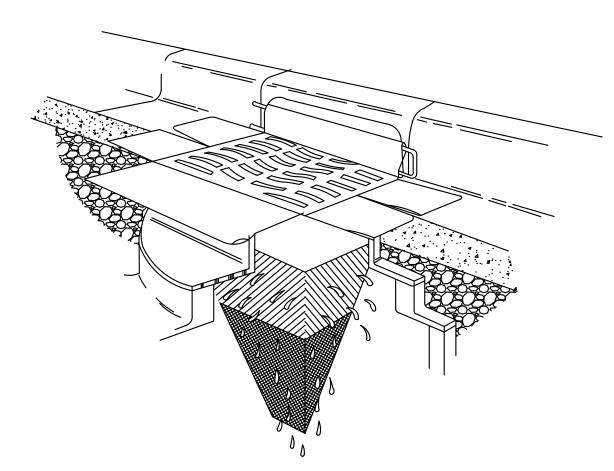

- EASY TO INSTALL EASY TO MAINTAIN
- ECONOMICAL FABRICATED TO FIT ANY SIZE OR SHAPE
- PERMEABILITY OF 200 GPM/SF [HI-FLOW STYLE] REPLACES ALL ROCK OR GÉOTEXTILES
- REUSABLE

DETAIL


SILT SACK (OR APPROVED EQUAL)

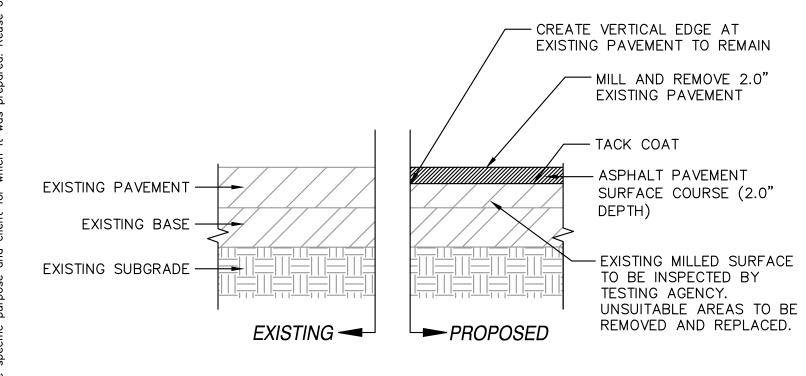

1. SURFACE COURSE TO BE INSTALLED AT SAME TIME AS ADJACENT ASPHALT REPAIRS SURFACE COURSE.

DETAIL


ASPHALT PAVEMENT - 2.0" MILL AND OVERLAY

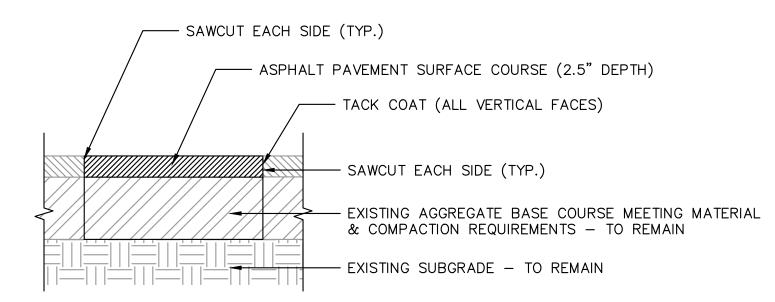


- 1. CUT AND PATCH AREAS SHOWN ON THE PLANS ARE APPROXIMATE IN SIZE AND LOCATION AND MAY BE ADJUSTED AT THE TIME OF CONSTRUCTION.
- 2. SURFACE COURSE SHALL BE INSTALLED AT THE SAME TIME AS ADJACENT PAVEMENT REPAIR SURFACE COURSES.
- 2. IF AGGREGATE BASE COURSE IS NOT PRESENT CONTRACTOR TO NOTIFY ENGINEER OF
- 3. THE AGGREGATE BASE COURSE SHALL BE INSPECTED BY THE TESTING AGENCY, OWNER, OR DESIGN CONSULTANT AFTER ASPHALT REMOVAL AND BASE PREPARATION, PRIOR TO ASPHALT REPLACEMENT.

DETAIL

ASPHALT PAVEMENT - CUT AND PATCH

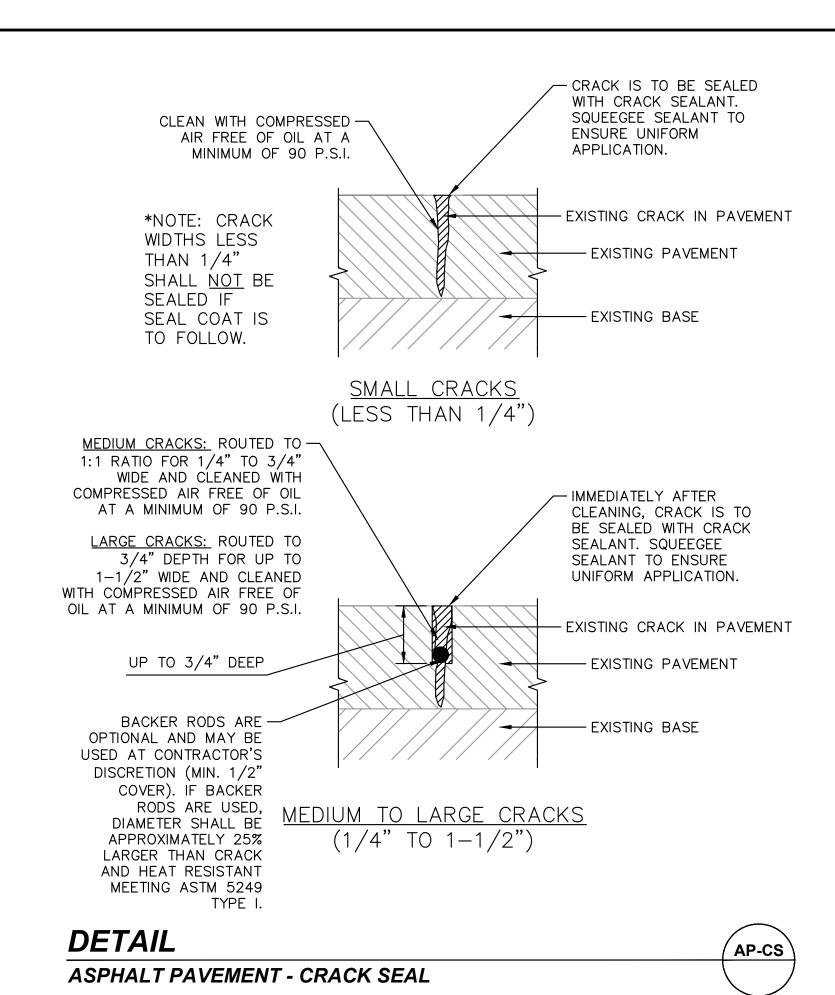

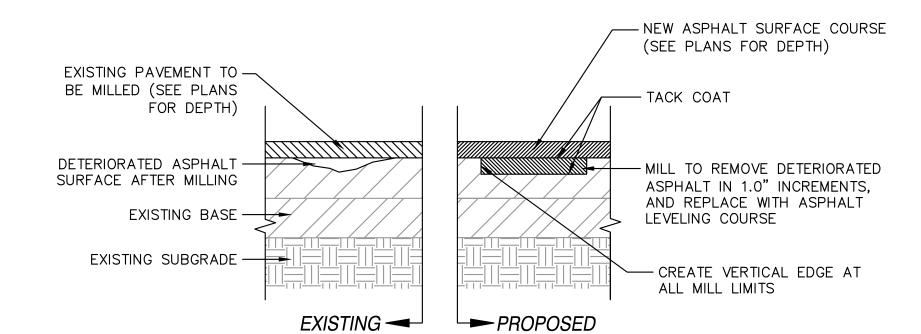


1. ALL INCREMENTAL MILLING AND REPLACEMENT AREAS SHALL BE DETERMINED AND VERIFIED WITH THE OWNER OR DESIGN CONSULTANT PRIOR TO COMPLETION. ITEM SHALL BE PAID ACCORDING TO ESTABLISHED UNIT PRICE (\$/S.Y./INCH)

2. AFTER AREAS HAVE BEEN PREPARED TO THE SATISFACTION OF THE OWNER OR DESIGN CONSULTANT APPLY TACK COAT AT THE RATE OF 0.20 GAL/S.Y. PRIOR TO ASPHALT REPLACEMENT.

DETAIL

AP-MO


ASPHALT PAVEMENT - 1.0" INCREMENTAL MILL AND REPLACE

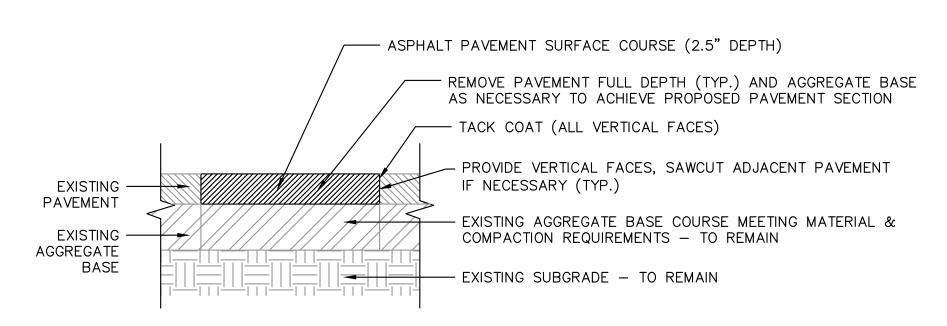

SURFACE COURSE SHALL BE INSTALLED AT SAME TIME AS ADJACENT PAVEMENT REPAIR SURFACE COURSE. IF AGGREGATE BASE COURSE IS NOT PRESENT CONTRACTOR TO NOTIFY ENGINEER OF RECORD IMMEDIATELY. AGGREGATE BASE COURSE SHALL BE INSPECTED BY THE TESTING AGENCY, OWNER, OR DESIGN CONSULTANT AFTER ASPHALT REMOVAL AND BASE PREPARATION, PRIOR TO ASPHALT REPLACEMENT

DETAIL

ASPHALT PAVEMENT - 2.5" REMOVE AND REPLACE

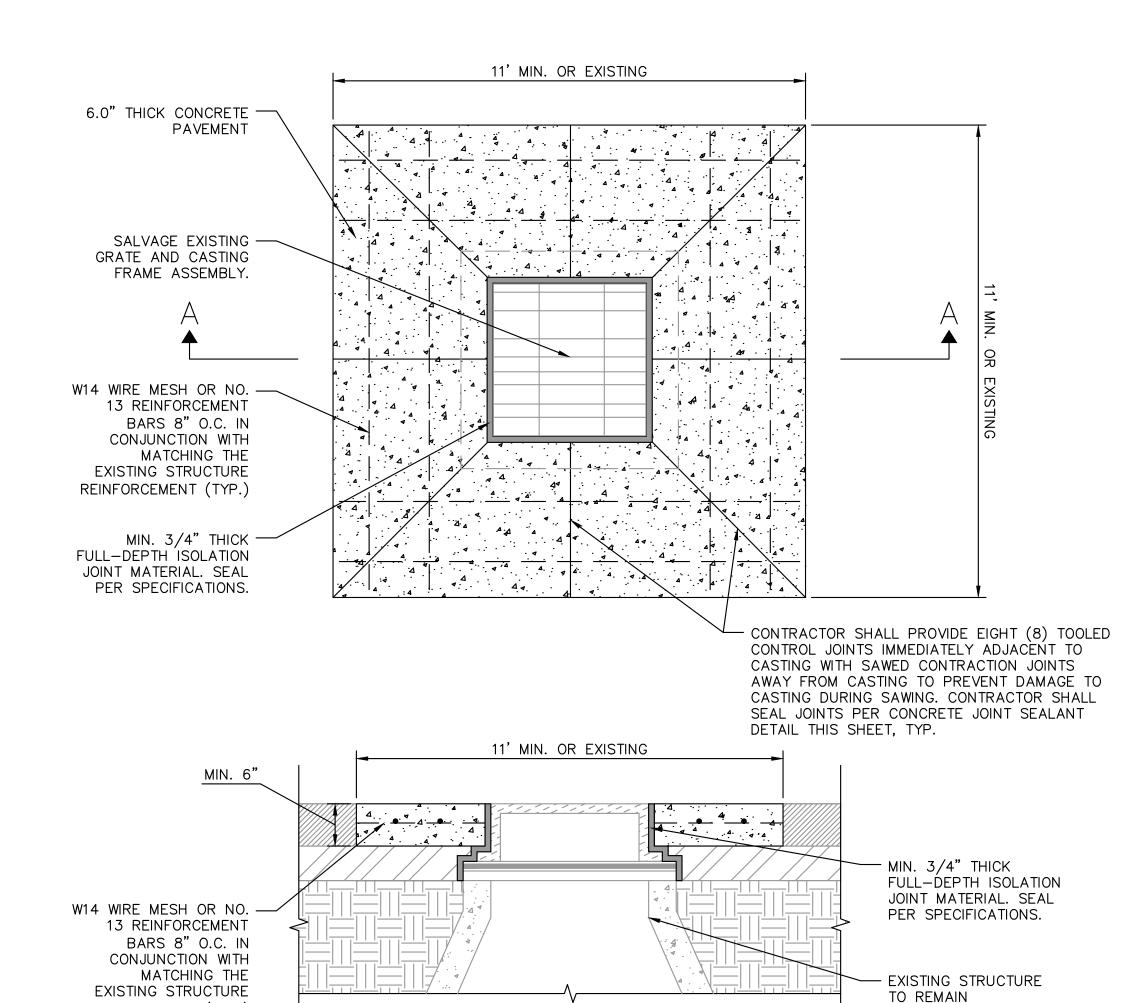

REINFORCEMENT (TYP.)

1. PRIOR TO CONSTRUCTION, CONTRACTOR SHALL VERIFY STRUCTURAL CONDITION OF EXISTING MANHOLE IS SUFFICIENT FOR THE PROPOSED REHABILITATION. IF CONDITIONS IN THE FIELD ARE SUCH THAT PROPOSED REHABILITATION WILL NOT BE POSSIBLE, CONTRACTOR SHALL CONTACT THE ENGINEER/OWNER IMMEDIATELY FOR AN ALTERNATE DESIGN.

SECTION A-A

2. CONCRETE COLLAR DIMENSIONS MAY VARY. REFERENCE PLAN SHEETS FOR SPECIFIC COLLAR DIMENSIONS. REINFORCEMENT SHALL BE ADJUSTED ACCORDINGLY IF DIMENSIONS DIFFER FROM DETAIL.

3. SAWCUT AND REMOVE EXISTING PAVEMENT FULL-DEPTH WITHIN REPAIR AREA AND EXCAVATE THE AGGREGATE SURROUNDING STRUCTURE TO ACCOMMODATE PROPOSED CROSS SECTIONS.

4. TAKE CARE TO REMOVE EXISTING CONCRETE STRUCTURE COVER AND SALVAGE EXISTING GRATE AND CASTING ASSEMBLY.

5. PRIOR TO CONSTRUCTION, CONTRACTOR SHALL SET CASTING AND ENSURE THAT ANY REVISED PAVEMENT SLOPES RESULTING FROM ADJUSTMENT OF STRUCTURE WITHIN REPAIR AREAS MAINTAIN POSITIVE DRAINAGE.


6. COMPACTED AGGREGATE BACKFILL AROUND STRUCTURE PRIOR TO PLACEMENT OF CONCRETE PER SPECIFICATIONS. 7. TUCK POINT INTERIOR OF STRUCTURE WITH MORTAR UP TO 3' BELOW CASTING

DETAIL

AP-IM

AP-RR1

CONCRETE PAVEMENT - REMOVE AND REPLACE CONCRETE COLLAR

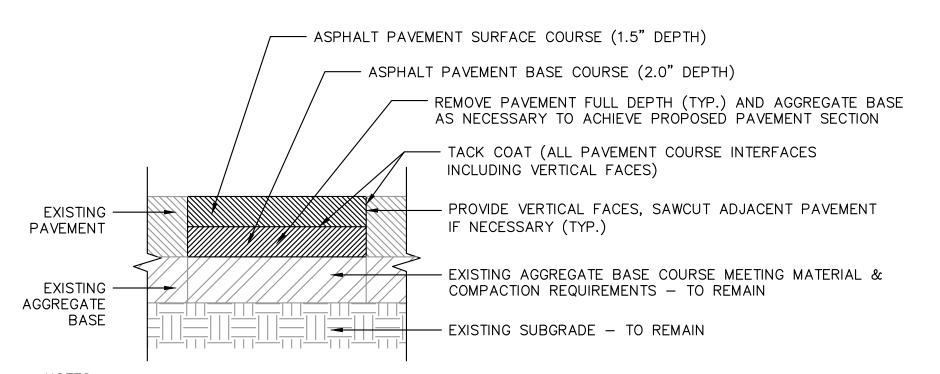

1. SURFACE COURSE SHALL BE INSTALLED AT SAME TIME AS ADJACENT PAVEMENT REPAIR SURFACE COURSE. 2. IF AGGREGATE BASE COURSE IS NOT PRESENT CONTRACTOR TO NOTIFY ENGINEER OF RECORD IMMEDIATELY. 3. AGGREGATE BASE COURSE SHALL BE INSPECTED BY THE TESTING AGENCY, OWNER, OR DESIGN CONSULTANT AFTER ASPHALT REMOVAL AND BASE PREPARATION, PRIOR TO ASPHALT REPLACEMENT.

DETAIL

ASPHALT PAVEMENT - 3.5" REMOVE AND REPLACE

CP-CC

SHEET NUMBER

UST DET

 $A \ge 0$


 $\mathcal{L} \circ \Pi$


Ш Ř Ū

 \Box

Ш


HOBBS TURBRII

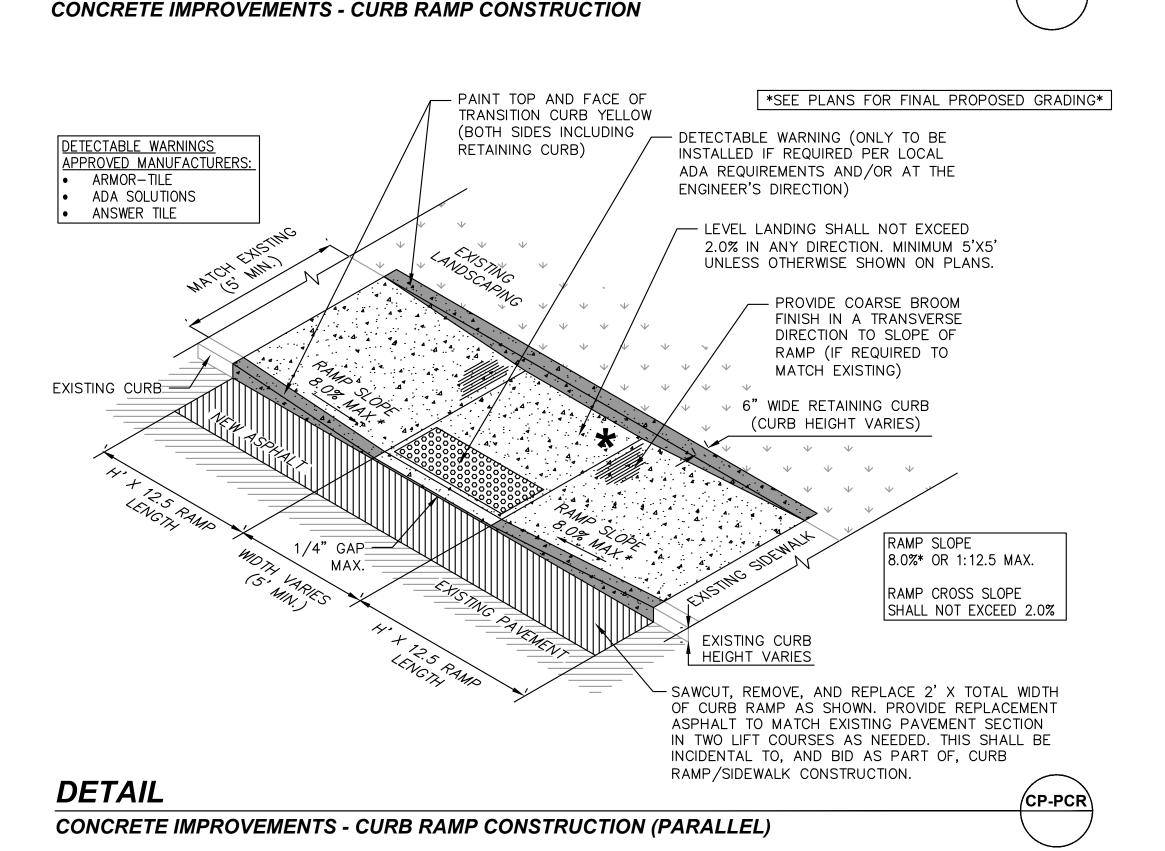


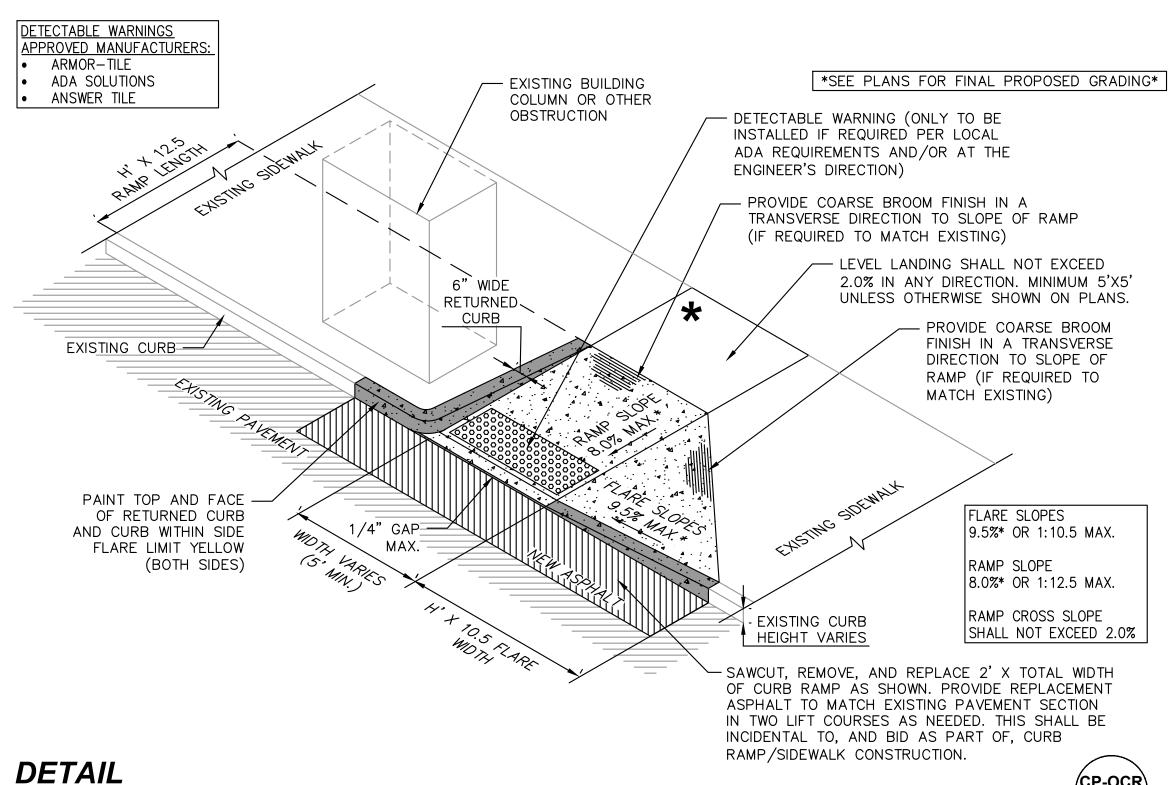

NOTES - FOR ALL RAMPS:

- 1. SAWCUT AND REMOVE EXISTING SIDEWALK AS REQUIRED TO CONSTRUCT CURB RAMP.
- 2. THE CURB RAMP SHALL HAVE A MINIMUM CONCRETE THICKNESS OF 4 INCHES.
- 3. ELEVATION DIFFERENCE BETWEEN TOP AND BOTTOM OF CURB RAMP SHALL NOT EXCEED 6". IF ELEVATION IS GREATER THAN 6", A HAND RAIL SHALL BE PROVIDED.
- 4. TRANSITION FROM RAMP AND LANDING TO WALK, GUTTER OR STREET SHALL BE FLUSH AND FREE OF ABRUPT CHANGES.
- 5. CONTRACTOR IS ENCOURAGED TO CONSTRUCT PROPOSED REMEDIATION MEASURES BELOW THE STATED MAXIMUMS IN ORDER TO ALLOW FOR CONSTRUCTION TOLERANCES. ANY REQUIRED RECONSTRUCTION EXCEEDING THE ADA MAXIMUMS WILL BE THE CONTRACTOR'S SOLE RESPONSIBILITY.
- 6. PROVIDE LEVEL LANDINGS WITH MAXIMUM SLOPE OF 2.0% IN ALL DIRECTIONS AT THE TOP AND BOTTOM OF THE RAMP.
- 7. HIGH EARLY STRENGTH CONCRETE SHALL BE USED ON ALL RAMP CONSTRUCTION PROJECTS AT MAIN STORE ENTRANCES OR AT LOCATIONS WHERE SET TIMES NEED TO BE MINIMIZED TO REDUCE IMPACTS TO TRAFFIC.
- 8. ANY HANDRAILS CALLED OUT TO BE INSTALLED WITH A CURB RAMP SHALL BE INCIDENTAL TO THE COST OF THE CONCRETE/CURB RAMP CONSTRUCTION.

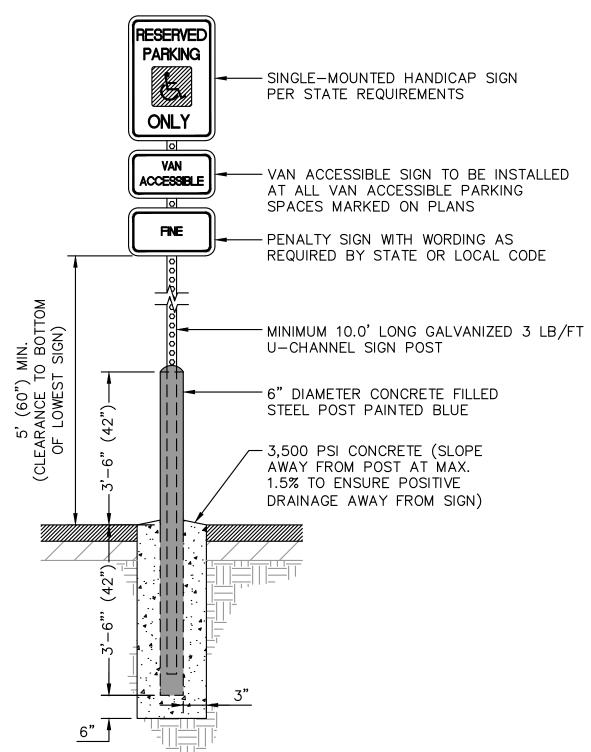

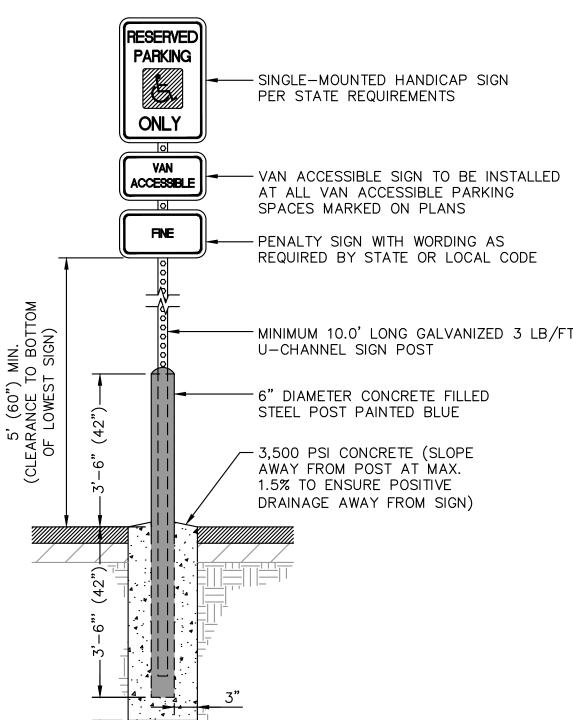

CONCRETE IMPROVEMENTS - CURB RAMP CONSTRUCTION (OBSTRUCTION)

1. ONE REQUIRED CENTERED AT EACH ACCESSIBLE SPACE.


2. TOP OF ALL HANDICAP SIGNS TO BE SET AT UNIFORM HEIGHT REGARDLESS OF PENALTY FINE OR VAN ACCESSIBLE SIGN INCLUSION. 3. SIGNS SHALL BE MOUNTED TO POST WITH GALVANIZED OR CADMIUM

PLANTED 5/16" DIAMETER STEEL BOLTS, NUTS AND WASHERS.


DETAIL

CP-CR

MISCELLANEOUS IMPROVEMENTS - ADA SIGN AND POST WITH BOLLARD

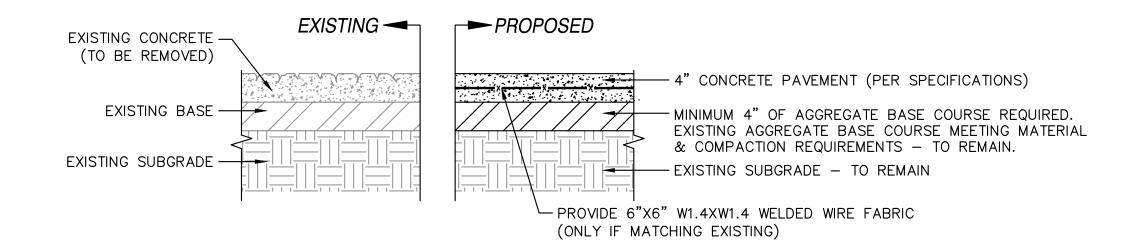

(CP-OCR)

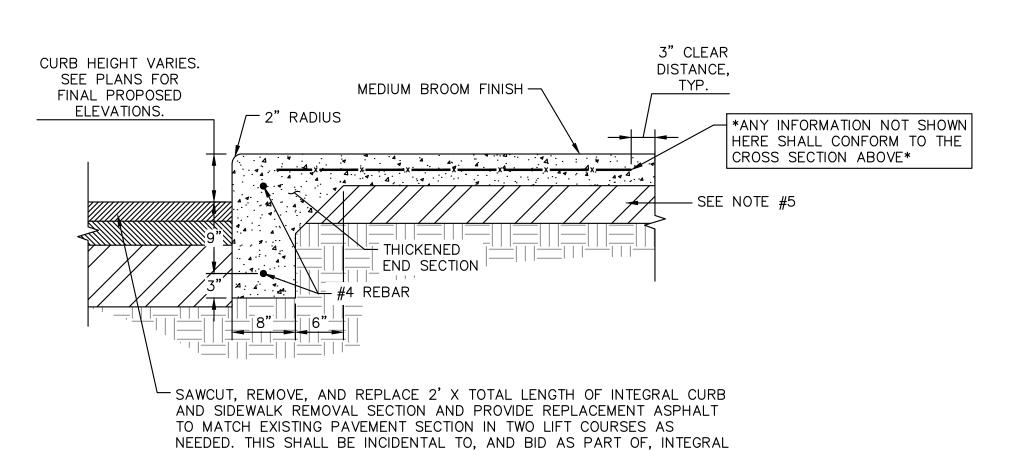

CURB AND SIDEWALK CONSTRUCTION.

- DETAIL SHOWN FOR REFERENCE ONLY. FIELD CONSTRUCTION SHALL MATCH EXISTING CURB AND TYPE, INCLUDING DIMENSIONS AND REINFORCEMENT, AS WELL AS ELEVATION. HOWEVER, IN ALL CASES, THE THICKENED CONCRETE END SECTION SHALL BE CONSTRUCTED PER THIS DETAIL.
- VERTICAL SAWCUT SHALL BE MADE AT ALL LIMITS OF REMOVAL TO CREATE A CLEAN EDGE. 3. MATCH EXISTING CONTROL AND EXPANSION JOINTS, UNLESS WHERE REQUIRING MODIFICATION OF JOINTING TO ALLOW FOR LEVEL LANDINGS AND TRANSITION ZONES.
- 4. ALL SIDEWALKS CONSTRUCTED WITHIN ADA ROUTES SHALL NOT EXCEED 2.0% CROSS SLOPE AND 5.0% LONGITUDINAL SLOPE (IN THE DIRECTION OF TRAVEL), UNLESS OTHERWISE SPECIFICALLY SHOWN ON PLANS. LEVEL LANDINGS IN FRONT OF DOORS AND AT TOP OF RAMPS SHALL NOT EXCEED 2.0% IN ANY DIRECTION.
- 5. CONTRACTOR SHALL NOTIFY ENGINEER IF EXISTING BASE MATERIAL DOES NOT MEET REQUIREMENTS PER SPECIFICATIONS OR IS NOT PRESENT.

DETAIL

/MI-SPB

CONCRETE PAVEMENT - REMOVE, REGRADE, AND REPLACE INTEGRAL CURB AND SIDEWALK



SHEET NUMBER

ST DE


Şĕ

 $\mathcal{L} \circ \Pi$ 回水河

 \Box

Ш

HOBBS TURBRII

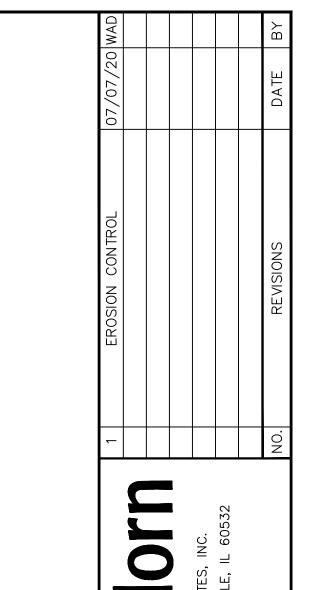


STI DEI

A≥ TER RO GE, CENT HOBBS BI TURBRID \Box

AP-RRR

EXPANSION JOINTS (TYPE B SILICONE)

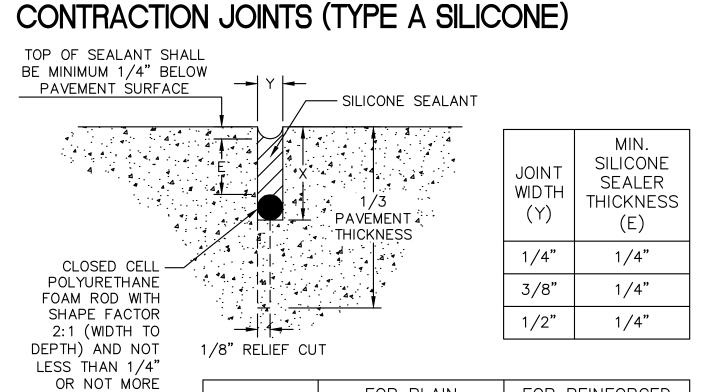

THAN 1/2".

DETAIL

CONCRETE JOINT SEALANT

FOR REINFORCED FOR PLAIN CONCRETE SLAB CONCRETE SLAB DIMENSION SEALANT TYPES SEALANT TYPES 1 ¾ OR 2" ₹" OR 1" ₹" OR 1"

NOTES:

3. TYPES OF JOINT MATERIAL ARE TO BE IN ACCORDANCE WITH THE SPECIFICATIONS. 4. ALL CONTRACTION JOINTS TO BE SAWED IN CONFORMANCE WITH THE DETAILS, EXCEP THAT WHERE GRAVEL AGGREGATE IS USED IN THE CONCRETE, THE JOINT MAY BE PREPARED BY FORMING 1/4" OR LESS OF THE WIDTH, FOR THE DEPTH SHOWN WITH WITH NON-METALLIC OR REMOVABLE MATERIAL, FOLLOWED BY SAWING TO COMPLETE THE JOINT TO THE REQUIRED WIDTH AND DEPTH

BE MINIMUM 1/4" BELOW PAVEMENT SURFACE — SILICONE SEALANT SILICONE JOINT SEALER WIDTH THICKNESS (Y) PAVEMENT 3/4" 3/8" CLOSED CELL POLYURETHANE 1/2" FOAM ROD WITH SHAPE FACTOR 2:1 (WIDTH TO DEPTH) AND NOT 1/8" RELIEF CUT LESS THAN 1/4"

OR NOT MORE

THAN 1/2".

TOP OF SEALANT SHALL

1. THESE DETAILS SHALL BE USED FOR ALL NEWLY CONSTRUCTED OR SAWN JOINTS. 2. SILICONE SEALANTS SHALL BE USED TO SEAL ALL JOINTS.

DETAIL

REAR/END OF -

PARKING SPACE

MISCELLANEOUS IMPROVEMENTS - ADA SYMBOL WITH BACKGROUND

> DISTANCE VARIES (SEE PLANS)

2. CONTRACTOR SHALL ONLY PAINT IN SYMBOL OF ACCESSIBILITY IN

PARKING SPACES DESIGNATED WITH ADA PARKING SIGNS.

1. PAVEMENT MARKING STROKE WIDTH = 2" MINIMUM

/MI-SYM\

— PARKING STRIPING

- WHITE SYMBOL OF

BACKGROUND (OR

— 4" MIN. BORDER

SYMBOL TO BE CENTERED AND

PLACED AT REAR/END OF EACH

ACCESSIBLE PARKING SPACE


COLORS PER STATE)

(COLOR PER STATE)

ACCESSIBILITY ON BLUE

SEE PLANS FOR PROPOSED GRADING

LIMITS OF ADA PARKING AREA DISTANCE VARIES (SEE PLANS)

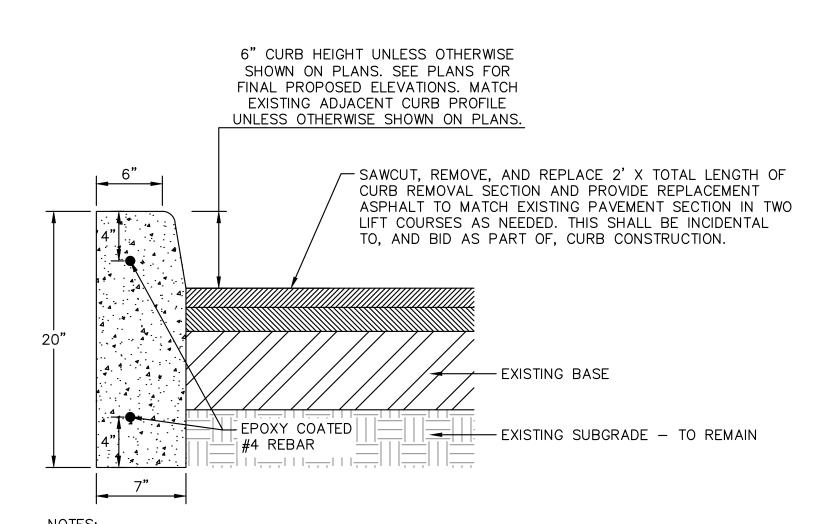


- 1. DETAIL SHOWN FOR REFERENCE ONLY. FIELD CONSTRUCTION SHALL MATCH EXISTING CURB TYPE, INCLUDING DIMENSIONS AND REINFORCEMENT, AS WELL AS ELEVATION, UNLESS OTHERWISE SPECIFICALLY SHOWN ON PLANS.
- 2. VERTICAL SAWCUT SHALL BE MADE AT ALL LIMITS OF REMOVAL TO CREATE A
- 3. GRADING, ADDITIONAL AGGREGATE/CONCRETE REQUIRED TO MATCH EXISTING CROSS SECTION GRADES, AND SEEDING OF ADJACENT LANDSCAPE AREA SHALL BE INCIDENTAL TO, AND BID AS PART OF, CURB CONSTRUCTION.

DETAIL

CONCRETE PAVEMENT - REMOVE AND REPLACE VERTICAL CURB



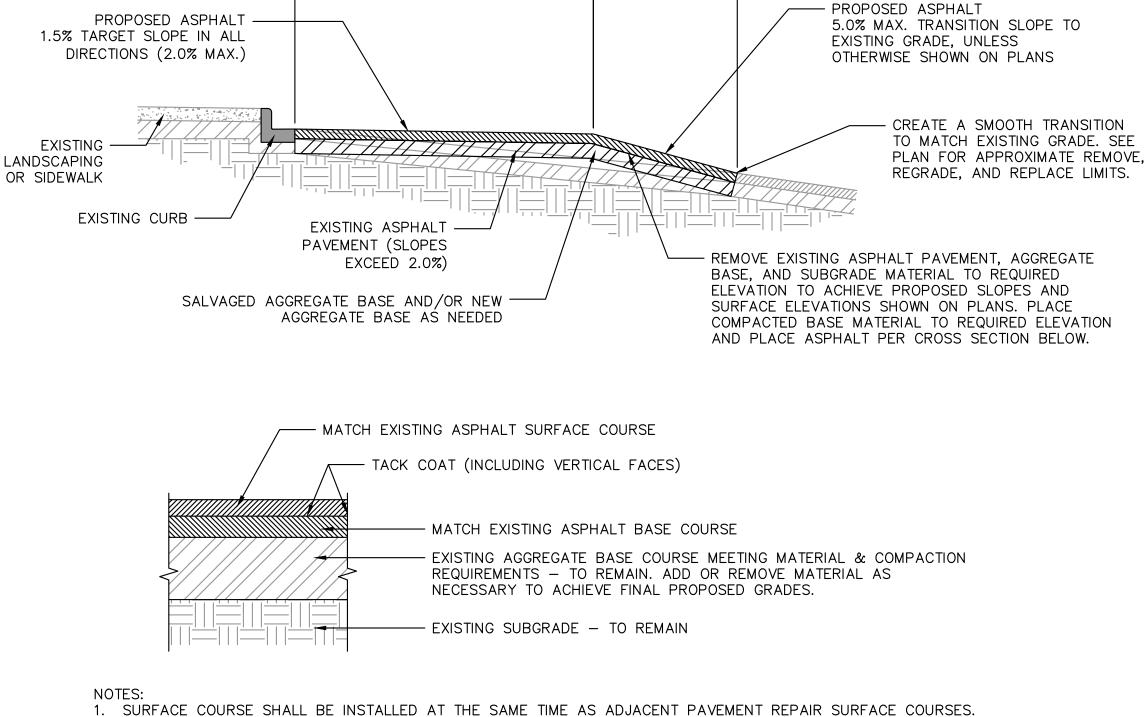

2. IF AGGREGATE BASE COURSE IS NOT PRESENT CONTRACTOR TO NOTIFY ENGINEER OF RECORD IMMEDIATELY.

ASPHALT REMOVAL AND BASE PREPARATION, PRIOR TO ASPHALT REPLACEMENT.

3. THE AGGREGATE BASE COURSE SHALL BE INSPECTED BY THE TESTING AGENCY, OWNER OR DESIGN CONSULTANT AFTER

DETAIL

ASPHALT PAVEMENT - REMOVE, REGRADE, AND REPLACE

SHEET NUMBER C2-02

CORING INFORMATION


2016 Pavement Investigation Program

Site: Center at Hobbs
Address: 100 Charlton Road, Sturbridge MA
PSI Project #: 0446625
Date: 8/8/2016



Core #	Asphalt Thickness	Coarses & Thickness of each Coarse	Base Type & Thickness	Subgrade Type & Condition
C-01	3"	Top = 1.5"	4" Brown 2" minus	7" to 2' Brownish orange medium sandy gravel
		Binder = 1.5"	processed gravel and medium sand	2" to 3'-2" Brownish orange medium-fine sand
	Comment: Corrug	gated plastic drain pipe was	encountered at 3'-2". Core 01 location	was moved to northwest corner behind Stop & Shop.
C-02	3.4"	Top = 1.5" Binder = 1.9"	16.5" Brown 2" minus processed gravel and medium sand	Refusal
	Comment: Core 0	2 location was moved appr	oximately 50' southwest into parking lo	ot.
C-03	2"	Top = 1" Binder = 1"	5" Brown 3" minus processed gravel and medium sand with cobbles	7" to 1' Gray and orange silt with fine sand and trace clay 1' to 1'-8" Brown silty sandy gravel with cobbles Refusal
	Comment: Binde	r coarse poor bonding thick	ness 0.7" – 1.25".	
C-04	3.25"	Top = 1.5" Binder = 1.75"	21" Brown 2" minus processed gravel and medium sand	2" to 2'-3" Brown silty sand with trace organics Refusal
	Comment: Organ	ics observed were some de	cayed matter and fine roots and a twig	
C-05	2.3"	Top = 0.9" Binder = 1.4"	11" Brownish orange 3" minus medium to fine sandy gravel	1'-1.5" to 2'-1" Gray silty sand 2'-1" to 2'-6" Dark gray medium-fine sand with gravel Refusal

Core Location Plan

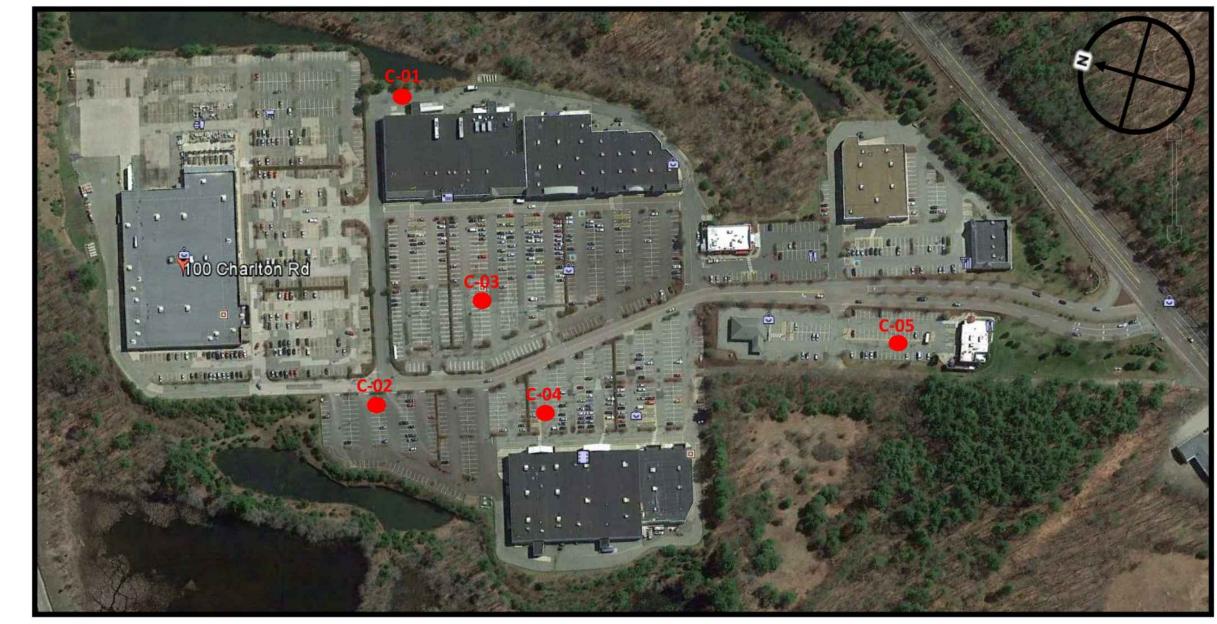

Core Location

CORING PHOTOGRAPHS





CORE 1

CORE 2





CORE 3

CORE 4



CORE 5

1	EROSION CONTROL	07/01/20	>
			I
NO.	REVISIONS	DATE	

© 2020 KIMLEY-HORN AND ASSOCIATES, INC.

1001 WARRENVILLE ROAD, SUITE 350, LISLE, IL 6053
PHONE: 630-487-5550

DATE
04/04/2020
SCALE AS SHOWN
DESIGNED BY ATO
DRAWN BY ATO

PAVEMENT CORING INFORMATION

THE CENTER AT HOBBS BROOK STURBRIDGE, MA

SHEET NUMBER

GENERAL NOTES

- ALL WORK SHALL COMPLY WITH THE REQUIREMENTS OF THE PROJECT PLANS AND SPECIFICATIONS. WHERE THE CONTRACTOR DETERMINES A CONFLICT EXISTS, THE CONTRACTOR SHALL NOTIFY THE ENGINEER AND ALLOW THE ENGINEER SUFFICIENT TIME TO ADDRESS THE CONFLICT. FAILURE TO NOTIFY THE ENGINEER WILL NOT CAUSE THE OWNER ADDITIONAL EXPENSES FOR NOTED CONFLICTS.
- 2. ALL WORK SHALL BE COMPLETED IN ACCORDANCE WITH CURRENT O.S.H.A. CODES AND STANDARDS. NOTHING INDICATED ON THESE PLANS SHALL RELIEVE THE CONTRACTOR FROM COMPLYING WITH APPROPRIATE SAFETY REGULATIONS.
- . ALL ACCESSIBLE SITE FEATURES SHALL BE CONSTRUCTED TO MEET THE CURRENT STANDARDS SET FORTH IN THE LATEST AMERICANS WITH DISABILITIES ACT (ADA).
- 4. THE CONTRACTOR SHALL REFER TO AND COMPLY WITH THE PROJECT BID DOCUMENTS FOR ALL WORK. THE CONTRACTOR SHOULD BE FAMILIAR WITH THE EXISTING SITE CONDITIONS AND THE PROPOSED PLANS. ANY EXISTING CONDITION FOUND IN CONFLICT WITH THE PROPOSED SCOPE OF WORK MUST BE IMMEDIATELY REPORTED TO THE ENGINEER AND OWNER TO
- ADDRESS.

 5. THE CONTRACTOR SHALL VERIFY THAT THE DESIGN PLANS AND SPECIFICATIONS ARE CURRENT AND HAVE BEEN APPROVED BY THE OWNER AND ALL APPLICABLE PERMIT—ISSUING AGENCIES. ALL ITEMS CONSTRUCTED BY THE CONTRACTOR PRIOR TO RECEIVING FINAL APPROVAL AND/OR PERMITS THAT REQUIRE ADJUSTMENT OR REPLACEMENT, SHALL BE COMPLETED AT THE SOLE EXPENSE OF THE CONTRACTOR.
- 6. THE CONTRACTOR IS CAUTIONED THAT THE EXISTING INFORMATION SHOWN ON THESE PLANS ARE BASED ON CAD FILES AND NOT FROM FIELD MEASUREMENTS. THE ENGINEER DOES NOT GUARANTEE THE COMPLETENESS OR ACCURACY OF THE INFORMATION SHOWN ON THE PLANS. THE CONTRACTOR WILL BE RESPONSIBLE FOR FIELD VERIFYING EXISTING SITE CONDITIONS.
- 7. ALL CONSTRUCTION OPERATIONS MUST BE DONE IN SUCH A MANNER AS TO PROTECT ALL ADJACENT EXISTING BUILDINGS, PAVEMENTS, LANDSCAPING AND OTHER SITE ELEMENTS. THIS INCLUDES USING SMALLER EQUIPMENT OR CONTROLLING ACCESS ROUTES FOR EQUIPMENT TO ELIMINATE DAMAGE TO SITE PAVEMENTS. ANY EXISTING ELEMENTS DAMAGED DURING CONSTRUCTION MUST BE REPAIRED TO THE OWNER'S SATISFACTION AT THE SOLE EXPENSE OF THE CONTRACTOR.
- 8. THE CONTRACTOR SHALL PROVIDE FOR THE CONTINUOUS OPERATION OF EXISTING FACILITIES WITHOUT INTERRUPTION DURING CONSTRUCTION UNLESS SPECIFICALLY AUTHORIZED OTHERWISE BY THE OWNER.
- 9. THE CONTRACTOR'S STAGING AND MATERIAL STORAGE AREAS MUST BE COORDINATED WITH THE OWNER. ALL SUCH AREAS AND CONSTRUCTION METHODS MUST BE DONE IN SUCH A MANNER AS TO AVOID INTERFERENCE WITH THE OWNER'S OPERATIONS AND CUSTOMER ACCESS.
- 10. THE CONTRACTOR SHALL MAKE APPLICATION FOR, OBTAIN AND HAVE IN POSSESSION ALL NECESSARY PERMITS REQUIRED TO COMPLETE THE WORK PRIOR TO THE START OF CONSTRUCTION.
- 11. THE CONTRACTOR SHALL CONFINE ACTIVITIES TO THE PROJECT SITE UNDER DEVELOPMENT, EXISTING RIGHTS—OF—WAY, AND EASEMENTS AS APPLICABLE. THE CONTRACTOR SHALL NOT TRESPASS UPON ANY OTHER PRIVATE PROPERTY WITHOUT THE WRITTEN CONSENT OF THE RESPECTIVE PROPERTY OWNER.
- 12. THE CONTRACTOR SHALL CLEAN UP ALL DEBRIS AND MATERIALS RESULTING FROM OPERATIONS AND RESTORE ALL SURFACES, STRUCTURES, DITCHES AND OTHER SITE ELEMENTS TO THEIR ORIGINAL CONDITION AND THE SATISFACTION OF THE OWNER.
- 13. THE CONTRACTOR WILL BE RESPONSIBLE FOR PROVIDING A LICENSED MATERIALS TESTING AGENCY, SUPPORTED BY A REGISTERED PROFESSIONAL ENGINEER, TO PROVIDE ONSITE INSPECTION AND VERIFY IN THE FIELD THAT ALL MIX DESIGNS ARE IN COMPLIANCE WITH THE PLANS AND SPECIFICATIONS AND THAT ALL BACKFILL AND PAVEMENT HAS BEEN PLACED WITH THE PROPER NUMBER OF LAYERS AND THICKNESS AND COMPACTED IN ACCORDANCE WITH THE PLANS AND SPECIFICATIONS.
- 14. EMPLOYMENT OF A MATERIALS TESTING AGENCY SHALL NOT RELIEVE THE CONTRACTOR OF OBLIGATIONS TO PERFORM THE WORK IN ACCORDANCE WITH THE CONTRACT DOCUMENTS. THE CONTRACTOR SHALL COORDINATE AND PROVIDE 48 HOUR NOTICE TO THE MATERIALS TESTING AGENCY PER SPECIFICATION FOR INSPECTION OF WORK.
- 15. REPORTS, CERTIFICATIONS, MATERIAL CHECKS AND FIELD TESTS SHALL BE COMPLETED DAILY AND A COPY OF THE RESULTS SHOULD BE EMAILED TO THE PROJECT ENGINEER DAILY.
- 16. IF IN THE OPINION OF THE ENGINEER, THE WORK DOES NOT MEET THE TECHNICAL OR DESIGN REQUIREMENTS STIPULATED FOR THE WORK, THE CONTRACTOR SHALL MAKE ALL NECESSARY ADJUSTMENTS FOR APPROVAL AT THEIR SOLE EXPENSE. THE CONTRACTOR SHALL MAKE NO DEVIATIONS FROM THE CONTRACT DOCUMENTS WITHOUT SPECIFIC WRITTEN APPROVAL OF THE ENGINEER OR OWNER.
- 17. THE CONTRACTOR SHALL CERTIFY THAT THE PAVEMENT AND ALL RELATED WORK HAS BEEN INSTALLED IN ACCORDANCE WITH THE CONTRACT DOCUMENTS. CERTIFICATIONS SHALL BE EMAILED TO THE PROJECT ENGINEER. IF REQUIRED, THE CONTRACTOR SHALL BE RESPONSIBLE TO MAKE ANY CHANGES IN THE FIELD FOR COMPLIANCE WITH THE CONTRACT DOCUMENTS AT HIS SOLE EXPENSE.
- 18. THE CONTRACTOR SHALL BE RESPONSIBLE TO CERTIFY THAT PROPER SUBGRADE AND TRENCH BACKFILL COMPACTION HAS BEEN OBTAINED BY THE SUBCONTRACTORS UNDER THEIR SUPERVISION.
- 19. IF THE CONTRACTOR'S OPERATIONS ARE SHOWN TO NEGATIVELY IMPACT THE OWNER'S USE OF THE SITE, THE OWNER AND/OR THE ENGINEER SHALL PROVIDE 24—HOUR NOTICE TO THE CONTRACTOR TO MODIFY THEIR OPERATIONS TO THE OWNER'S SATISFACTION.

SITE INFRASTRUCTURE NOTES

- THE CONTRACTOR SHALL NOTIFY ALL UTILITY OWNERS BY CALLING 811 AT LEAST 72 HOURS BEFORE ANY EXCAVATION (EXCLUDING WEEKENDS AND HOLIDAYS) TO REQUEST EXACT FIELD LOCATION AND STAKING OF UTILITIES. IF NO NOTIFICATION IS GIVEN AND DAMAGE RESULTS, SAID DAMAGE WILL BE REPAIRED AT THE SOLE EXPENSE OF THE CONTRACTOR. THE CONTRACTOR SHALL NOTIFY THE OWNER OF THE UTILITY IMMEDIATELY UPON BREAK OR DAMAGE TO ANY UTILITY LINE OR APPURTENANCE THEREOF. WHEN HIS OPERATIONS MAY REQUIRE AN INTERRUPTION OF THE UTILITY SERVICE OR POTENTIALLY CAUSE DAMAGE TO THE UTILITY INVOLVED, THE CONTRACTOR SHALL NOTIFY THE UTILITY COMPANY/OWNER PRIOR TO CONSTRUCTION.
- 2. IF EXISTING UTILITY LINES ARE ENCOUNTERED THAT CONFLICT IN LOCATION WITH PROPOSED CONSTRUCTION, THE CONTRACTOR SHALL NOTIFY THE ENGINEER IMMEDIATELY SO THAT THE CONFLICT MAY BE RESOLVED.
- 3. ALL UTILITY MANHOLE COVERS, VALVES, BOXES, FITTINGS AND/OR OTHER UTILITY APPURTENANCES THAT ARE AT THE SURFACE OF PAVEMENTS TO BE REPLACED OR REPAIRED SHALL BE ADJUSTED FLUSH WITH THE NEW SURFACE SO AS NOT TO BE COVERED WITH PAVEMENT OR CAUSE A TRIPPING HAZARD.
- 4. IN THE EVENT THAT EXISTING UTILITY SERVICES ARE TO BE INTERRUPTED OR IMPACTED BY NECESSARY CONSTRUCTION OPERATIONS, IT SHALL BE THE CONTRACTOR'S RESPONSIBILITY TO GIVE PRIOR NOTIFICATION TO THE RESPECTIVE OWNER/UTILITY COMPANY AND ALL SERVICE USERS TO BE AFFECTED BY THE SERVICE INTERRUPTION. ALL SERVICE INTERRUPTIONS SHALL BE PERFORMED AT OFF—PEAK HOURS, WHEN POSSIBLE, TO MINIMIZE ANY INCONVENIENCE TO THE AFFECTED PARTIES.
- 5. ALL EXISTING UTILITIES AND SITE INFRASTRUCTURE, INCLUDING BUT NOT LIMITED TO, LIGHT POLES, BOLLARDS, WATER MAINS, FIELD TILES, SEWERS, AND UTILITY SERVICE LINES SHALL BE PROTECTED BY THE CONTRACTOR DURING CONSTRUCTION. DAMAGED INFRASTRUCTURE SHALL BE REPAIRED TO ITS ORIGINAL CONDITION AT THE SOLE EXPENSE OF THE CONTRACTOR.

SITE ACCESS/TRAFFIC CONTROL NOTES

- 1. ALL TRAFFIC CONTROLS ON THIS PROJECT SHALL ADHERE TO THE REQUIREMENTS OF THE AGENCY HAVING JURISDICTION. ALL SIGNS, SUPPORTS, BARRICADES AND OTHER REQUIRED MATERIALS SHALL BE IN ACCORDANCE WITH THE MANUAL ON UNIFORM TRAFFIC CONTROL DEVICES (MUTCD), CURRENT EDITION, AND SHALL BE PROVIDED AND INSTALLED BY THE CONTRACTOR.
- 2. THE CONTRACTOR SHALL BE RESPONSIBLE FOR PROVIDING ALL REQUIRED PLANS TO RECEIVE APPROVAL FROM THE LOCAL GOVERNING AGENCY FOR THE PROPER INSTALLATION OF NECESSARY TRAFFIC CONTROLS AND WORK AREA PROTECTION AS APPLICABLE.
- 3. TRAFFIC CONTROLS SHALL BE INSTALLED PRIOR TO THE COMMENCEMENT OF ANY WORK REQUIRING SUCH MATERIALS. THEY SHALL BE MAINTAINED THROUGHOUT CONSTRUCTION AND SHALL REMAIN IN PLACE UNTIL THE CONCLUSION OF WORK.
- 4. PROPER SIGNING AND BARRICADING SHALL BE PROVIDED BY THE CONTRACTOR. IF IN THE OPINION OF THE ENGINEER OR OWNER, ADDITIONAL SIGNS AND BARRICADES, INCLUDING LANTERNS AND/OR HIGH RISE WARNING DEVICES, ARE NEEDED TO MAINTAIN OPERATIONS, SUCH CONTROLS SHALL BE PROVIDED AT THE SOLE EXPENSE OF THE CONTRACTOR.
- THE CONTRACTOR SHALL NOTIFY THE OWNER AND ENGINEER DAILY AND WEEKLY OF THE PROJECT SCHEDULE. ACCESS SHALL BE MAINTAINED AT ALL TIMES TO THE PROPERTIES ADJOINING THE CONSTRUCTION SITES, INCLUDING ROADWAYS PERMANENTLY OR TEMPORARILY CLOSED TO THROUGH TRAFFIC. ACCESS TO PRIVATE PROPERTIES MAY BE RESTRICTED TEMPORARILY FOR THE INSTALLATION OF A SPECIFIC UTILITY OR CONSTRUCTION ACTIVITY. IN THIS EVENT, THE PROPERTY OWNER SHALL BE CONTACTED BY THE CONTRACTOR AT LEAST TWENTY-FOUR (24) HOURS IN ADVANCE OF THE RESTRICTION AND SHALL BE GIVEN THE TIME AND DURATION OF THE RESTRICTION. IN NO EVENT SHALL ACCESS BE DENIED OVERNIGHT OR FOR MORE THAN EIGHT (8) CONSECUTIVE HOURS. IF TEMPORARY ACCESS IS AFFORDED NEAR EXCAVATIONS, SUCH ACCESS SHALL BE CLEARLY DELINEATED AND ADEQUATE MEASURES TAKEN AS REQUIRED TO INSURE ADEQUATE, SAFE ACCESS. ACCESS TO PROPERTIES SHALL BE MAINTAINED AT ALL TIMES. WHERE MULTIPLE DRIVEWAYS ARE PRESENT, AT LEAST ONE SHALL REMAIN OPEN FOR ACCESS AT ALL TIMES. WHERE ONLY ONE DRIVEWAY IS PRESENT, WORK SHALL PROGRESS SUCH THAT ONLY ONE-HALF OF THE DRIVEWAY IS RESTRICTED OR AN ALTERNATE ACCESS SHALL BE PROVIDED IF THE ENTIRE SECTION IS CLOSED. PARTIAL CLOSURE SCHEDULES SHALL BE SUBMITTED TO THE BUSINESS PROPRIETOR AT LEAST TWENTY-FOUR (24) HOURS IN ADVANCE OF THE STARTING TIME AND FOR THE DURATION OF CLOSURE.
- THE CONTRACTOR SHALL BE RESPONSIBLE TO NOTIFY ALL GOVERNING AGENCIES AND EMERGENCY RESPONSE PROVIDERS, INCLUDING FIRE AND POLICE DEPARTMENTS, BY PHONE OR IN WRITING, BEFORE THE BEGINNING OF HIS OPERATIONS SO THAT THESE AGENCIES MAY PLAN THEIR OPERATIONS IN CONSIDERATION OF THE CONSTRUCTION ZONE AND RELATED ACTIVITIES.
- 7. FIRE DEPARTMENT ACCESS SHALL BE MAINTAINED AT ALL TIMES.
- THE ENGINEER, OWNER, CITY AND STATE SHALL NOT BE HELD LIABLE FOR ANY CLAIMS RESULTING FROM ACCIDENTS OR DAMAGES CAUSED BY THE CONTRACTOR'S FAILURE TO COMPLY WITH TRAFFIC AND PUBLIC SAFETY REGULATIONS DURING THE CONSTRUCTION PERIOD.

GRADING NOTES

- 1. THE CONTRACTOR SHALL CONFIRM THAT THE FINAL PAVEMENT GRADES WILL NOT CREATE A PONDING WATER CONDITION (I.E. A LOW SPOT OR PAVEMENT SLOPES LESS THAN 1%) OR SLOPES IN EXCESS OF 5%. THE CONTRACTOR SHALL ADVISE ENGINEER IMMEDIATELY IF ONE OF THESE SITUATIONS WILL OCCUR.
- "SKIN PATCHING" WILL NOT BE PERMITTED FOR THE REPAIR OF WATER PONDING AREAS. AT A MINIMUM, A 1" THICK MILL AND REPLACE SHOULD BE USED FOR THE REPAIR OF THESE AREAS AS NECESSARY.
- THE CONTRACTOR IS RESPONSIBLE FOR CONTROLLING STORM WATER RUNOFF DURING CONSTRUCTION OPERATIONS. OF PARTICULAR CONCERN WILL BE THE TIME PERIOD AFTER THE SITE HAS BEEN STRIPPED AND NOT YET RESTORED, BUILT UPON, OR PAVED. THE CONTRACTOR MUST INSTALL OR CONSTRUCT APPROPRIATE TEMPORARY SOIL EROSION AND SEDIMENTATION CONTROL MEASURES TO PROTECT ADJACENT PROPERTIES.
- CONTRACTOR IS MADE AWARE THAT ANY PAVEMENT WORK WITHIN AND 5 FEET SURROUNDING ADA PARKING AREAS SHALL HAVE A MAXIMUM SLOPE OF 2 PERCENT IN ANY DIRECTION. THE ENGINEER WILL INDICATE THE LOCATION OF THESE AREAS ON THE PLANS WHICH MUST BE CORRECTED AS PART OF THE NEW RESURFACING PROJECT.

PAVING CONSTRUCTION NOTES

- 1. PAVING CONSTRUCTION SHALL BE PERFORMED IN ACCORDANCE WITH THE LOCAL, STATE DEPARTMENT OF TRANSPORTATION, AND/OR OTHER PERMITTING AGENCIES HAVING JURISDICTION AS APPLICABLE. WHERE THESE PLANS DIFFER FROM THE STANDARD DETAILS OR SPECIFICATIONS OF ANY GOVERNING AGENCY, THE AGENCY'S REQUIREMENTS SHALL GOVERN.
- 2. REMOVE ANY EXISTING TOPSOIL, VEGETATION, TREES AND OTHER DELETERIOUS MATERIALS TO EXPOSE THE SUBGRADE SOIL. TREE ROOTS SHALL BE COMPLETELY REMOVED.
- 3. EXCAVATE TO THE DEPTH OF THE FINAL SUBGRADE ELEVATION TO ALLOW FOR GRADE CHANGES AND THE PLACEMENT OF THE RECOMMENDED PAVEMENT SYSTEM.
- . WHERE FULL-DEPTH PAVEMENT RESTORATION IS CALLED FOR ON THE PLANS, THE TOP 12 INCHES OF THE EXPOSED SUBGRADE SHALL BE COMPACTED TO A DENSITY NO LESS THAN 95 PERCENT OF THE MAXIMUM DRY DENSITY AS DETERMINED BY THE MODIFIED PROCTOR (ASTM D 1557-91).
- WHERE FULL-DEPTH PAVEMENT RESTORATION IS CALLED FOR ON THE PLANS, THE FINAL SUBGRADE SHALL BE THOROUGHLY PROOF ROLLED UNDER THE OBSERVATION OF THE MATERIALS TESTING AGENCY. LOOSE OR YIELDING AREAS WHICH CANNOT BE MECHANICALLY STABILIZED SHALL BE REMOVED AND REPLACED WITH ENGINEERED FILL OR AS DICTATED BY FIELD CONDITIONS UNDER THE APPROVAL OF THE ENGINEER AND/OR OWNER
- WHERE PARTIAL—DEPTH PAVEMENT RESTORATION IS CALLED FOR ON THE PLANS, THE AGGREGATE BASE SHALL BE COMPACTED TO A DENSITY NO LESS THAN 95 PERCENT OF THE MAXIMUM DRY DENSITY AS DETERMINED BY THE MODIFIED PROCTOR (ASTM D 1557—91). THE BASE SHALL EXTEND A MINIMUM OF 1 FOOT BEYOND THE PAVED EDGE.
- 7. CONSTRUCTION TRAFFIC SHALL BE MINIMIZED ON THE NEW PAVEMENT. IF CONSTRUCTION TRAFFIC IS ANTICIPATED ON THE PAVEMENT STRUCTURE, THE PLACEMENT OF THE FINAL LIFT SHALL BE DELAYED UNTIL THE MAJORITY OF THE CONSTRUCTION ACTIVITIES HAVE BEEN COMPLETED. THIS ACTION WILL ALLOW REPAIR OF LOCALIZED FAILURE, IF ANY DOES OCCUR, AS WELL AS REDUCE LOAD DAMAGE ON THE PAVEMENT SYSTEM. THE CONTRACTOR IS RESPONSIBLE FOR REPAIR TO ANY DAMAGED SECTION RESULTING FROM CONSTRUCTION ACTIVITY AT THE SOLE EXPENSE OF THE CONTRACTOR.
- 8. ANY CONCRETE CURB DISTURBED AND/OR CALLED OUT TO BE REPLACED DURING CONSTRUCTION SHOULD BE REPLACED TO MATCH THE EXISTING PROFILE OF THE CURB AND GUTTER. CONTRACTOR SHALL REVERSE GUTTER PANS, WHERE REQUIRED, TO PREVENT WATER PONDING AND/OR ENTRAPMENT AGAINST THE CURB.
- WHERE A PROPOSED CURB AND GUTTER SECTION IS ADJACENT TO AN ADA RAMP, DROP CURB HEIGHT TO MAXIMUM 1/4" ACROSS THE RAMP OPENING.
- 10. PLACE EXPANSION JOINT AND JOINT SEALANT WHERE NEW CONCRETE PAVEMENT OR WALKS ABUT BUILDING WALLS (PROPOSED OR EXISTING), CURB, OR EXISTING CONCRETE PAVEMENT.
- 11. ANY CUT AND PATCH AREAS SHOWN ON THESE PLANS ARE APPROXIMATE IN SIZE AND LOCATION AND MAY BE ADJUSTED AT THE TIME OF CONSTRUCTION. IT WILL BE THE RESPONSIBILITY OF THE CONTRACTOR TO FIELD VERIFY CUT AND PATCH AREAS SHOWN AND COMPLETE THE ENTIRE SCOPE OF WORK AT NO INCREASE IN LUMP SUM PRICE.
- 12. THE CONTRACTOR SHALL REMOVE EXISTING PAVEMENT IN A MANNER WHICH DOES NOT ADVERSELY AFFECT THE SURROUNDING AREAS OF THE SITE. ANY NEEDED REPAIRS DUE TO DAMAGE DONE DURING REMOVAL OPERATIONS TO SURROUNDING AREAS SHALL BE AT THE SOLE EXPENSE OF THE CONTRACTOR AND TO THE SATISFACTION OF THE OWNER.
- 13. THE SUBGRADE SHALL BE INSPECTED BY THE MATERIALS TESTING AGENCY AFTER PAVEMENT REMOVAL AND PRIOR TO REPLACEMENT. SUBGRADE UNDERCUTTING SHALL BE PERFORMED AT THE REQUEST OF THE TESTING AGENCY, OWNER, OR ENGINEER AND WILL BE PAID AS A SEPARATE ITEM, UNLESS SPECIFICALLY CALLED OUT FOR ON THE PLANS.
- 14. WHERE SECTIONS OF EXISTING PARKING LOTS AND/OR INTERNAL ROADWAYS ARE TO BE MODIFIED, THE CONTRACTOR SHALL PROVIDE ALL FINISHED PAVEMENT MARKINGS, INCLUDING INFORMATIONAL AND DIRECTIONAL MARKINGS, SUCH THAT THEY MATCH THE EXISTING MARKING TYPE, COLOR, PATTERN AND LOCATION. THE CONTRACTOR MUST TAKE FIELD MEASUREMENTS AND ESTABLISH CONTROLS IN THE FIELD PRIOR TO REMOVING OR COVERING THE EXISTING MARKINGS IN ORDER TO REPLACE THEM. NOT ALL EXISTING PAVEMENT MARKINGS THAT ARE TO BE RE-ESTABLISHED MAY BE SHOWN ON THE PROJECT PLANS. REFER TO THE PROJECT PLANS FOR AREAS OF PAVEMENT MARKINGS THAT ARE TO BE MODIFIED FROM THE EXISTING LAYOUT. CONTRACTOR SHALL INSTALL NEW PAVEMENT MARKINGS IN ACCORDANCE WITH THE PLANS AND SPECIFICATIONS. NOTIFY THE ENGINEER PRIOR TO NEW MARKINGS BEING PLACED IF ANY CONFLICTS ARE FOUND WITH THE EXISTING MARKINGS. CONTRACTOR SHALL INCLUDE COSTS TO PROVIDE ALL MARKINGS.
- 15. WHERE AREAS OF PARKING LOTS WILL BE REOPENED FOR CUSTOMER USE PRIOR TO FINAL PAVEMENT MARKINGS BEING INSTALLED, THE CONTRACTOR SHALL PROVIDE TEMPORARY STRIPING FOR THE CENTERLINE OF THE PARKING BAY IN ORDER TO ASSIST DRIVERS TO PARK IN THE INTENDED ALIGNMENT ALONG THE BAY.

NIGHT TIME WORK

- 1. ANY NIGHT TIME OR AFTER DARK WORK SHALL BE APPROVED BY THE OWNER AND LOCAL AGENCIES HAVING JURISDICTION.
- 2. CONTRACTOR SHALL SUPPLY AMPLE LIGHTING TO PERFORM THE NIGHT TIME WORK. LIGHTING SHALL BE SHIELDED FOR ADJACENT PROPERTIES AND ROADWAYS.
- 3. ALL NIGHT TIME WORK SHALL BE SCHEDULED 24 HOURS IN ADVANCE WITH THE OWNER.

DEMOLITION NOTES

- 1. THE CONTRACTOR SHALL PROTECT EXISTING WALKS, PAVEMENT, CURBS, GUTTERS, WALLS, FENCES, SIGNS, GATES, LANDSCAPING AND TREES TO REMAIN DURING CONSTRUCTION.
- 2. THE CONTRACTOR SHALL FIELD—VERIFY THE LOCATION OF ALL UTILITIES ON SITE PRIOR TO ANY CONSTRUCTION WORK. DAMAGE TO ANY UTILITIES DURING CONSTRUCTION SHALL BE REPAIRED AT THE SOLE EXPENSE OF THE CONTRACTOR.
- 3. THE CONTRACTOR SHALL STAGE CONSTRUCTION OPERATIONS SO AS TO NOT IMPEDE FACILITY ACCESS AND OPERATIONS.
- 4. DISPOSAL OF MATERIALS REMOVED FROM THE SITE IS THE RESPONSIBILITY OF THE CONTRACTOR. THE CONTRACTOR SHALL DISPOSE OF ALL MATERIALS IN A TIMELY MANNER AND IN ACCORDANCE WITH ALL GOVERNING AGENCY REGULATIONS. BURYING DEBRIS ON THE SUBJECT SITE IS PROHIBITED.
- 5. EQUIPMENT AND MATERIALS USED IN CONSTRUCTION OPERATIONS SHALL BE STORED AND STOCKPILED IN ACCORDANCE WITH ALL GOVERNING AGENCY REGULATIONS AND AT THE DIRECTION OF THE OWNER OR THE ENGINEER.
- 6. IT IS THE RESPONSIBILITY OF THE CONTRACTOR TO MAINTAIN THE CLEANLINESS OF THE SITE THROUGHOUT THE PROJECT. THE CONTRACTOR SHALL CLEAN UP ANY DEBRIS ON SITE RESULTING FROM CONSTRUCTION OPERATIONS.
- 7. THE USE OF EXPLOSIVES SHALL NOT BE PERMITTED.
- 8. ALL NECESSARY RESTORATION WORK SHALL BE COMPLETED AT THE SOLE EXPENSE OF THE CONTRACTOR.
- 9. THE CONTRACTOR SHALL BE SOLELY AND COMPLETELY RESPONSIBLE FOR CONDITIONS OF THE JOB SITE, INCLUDING SAFETY OF ALL PERSONS AND PROPERTY DURING PERFORMANCE OF THE WORK. THIS REQUIREMENT WILL APPLY CONTINUOUSLY AND NOT BE LIMITED TO NORMAL WORKING HOURS. ANY CONSTRUCTION OBSERVATION BY THE ENGINEER OF THE CONTRACTOR'S PERFORMANCE IS NOT INTENDED TO INCLUDE REVIEW OF THE ADEQUACY OF THE CONTRACTOR'S SAFETY MEASURES IN, ON OR NEAR THE CONSTRUCTION SITE. ALL WORK SHALL BE COMPLETED IN ACCORDANCE WITH CURRENT O.S.H.A. CODES AND STANDARDS. NOTHING INDICATED ON THESE PLANS SHALL RELIEVE THE CONTRACTOR FROM COMPLYING WITH APPROPRIATE SAFETY REGULATIONS.

SOIL EROSION AND SEDIMENTATION CONTROL NOTES

- 1. THE CONTRACTOR SHALL PROVIDE AND MAINTAIN ALL SOIL EROSION AND SEDIMENTATION CONTROL MEASURES IN ACCORDANCE WITH THE REQUIREMENTS OF ALL GOVERNING AGENCIES' ENVIRONMENTAL STANDARDS.
- 2. CONTRACTOR SHALL TAKE ALL APPROPRIATE MEASURES TO KEEP ON-SITE SOIL EROSION SEDIMENT FROM ENTERING ADJACENT PARKING AREA AND INSURE THAT THE PARKING AREA IS KEPT CLEAN.
- 3. ALL SOIL EROSION AND SEDIMENTATION CONTROL MEASURES SHALL BE INITIATED AS SOON AS PRACTICABLE AND PRIOR TO ANY LAND DISTURBANCE AND/OR DEMOLITION.
- 4. ALL SOIL EROSION AND SEDIMENTATION CONTROL MEASURES ARE TO BE INSPECTED A MINIMUM OF ONCE PER WEEK AND/OR WITHIN 24 HOURS AFTER A RAIN EVENT. ALL SOIL EROSION AND SEDIMENTATION CONTROL MEASURES ARE TO BE MAINTAINED AND REPAIRED IMMEDIATELY AS NECESSARY.
- 5. SOIL EROSION AND SEDIMENTATION CONTROL MEASURES MAY HAVE TO BE ALTERED AT VARIOUS STAGES DURING CONSTRUCTION TO ACCOMMODATE ACTUAL SITE CONDITIONS.
- 6. THE CONTRACTOR IS RESPONSIBLE FOR CLEANING AND REMOVING ANY MUD/DEBRIS TRACKING FROM THE STREETS AND SIDEWALKS DURING THE SAME DAY OF OCCURRENCE.
- 7. ALL WASH WATER (PAVING TRUCKS, VEHICLE CLEANING, EQUIPMENT CLEANING, ETC.) SHALL BE DISPOSED OF IN AN APPROPRIATE MANNER THAT PREVENTS CONTACT BETWEEN THESE MATERIALS AND STORM WATER THAT IS DISCHARGED FROM THE SITE.
- 8. RUBBISH, TRASH, GARBAGE, LITTER OR OTHER SUCH MATERIALS SHALL BE DEPOSITED INTO SEALED CONTAINERS. MATERIALS SHALL BE PREVENTED FROM LEAVING THE PREMISES THROUGH THE ACTION OF WIND OR STORMWATER DISCHARGE.
- 9. SUFFICIENT OIL AND GREASE ABSORBING MATERIALS AND FLOTATION BOOMS SHALL BE MAINTAINED ON SITE OR READILY AVAILABLE TO CONTAIN AND CLEAN—UP FUEL OR CHEMICAL SPILLS AND LEAKS.
- 10. DUST ON THE SITE SHALL BE CONTROLLED BY SPRAYING WATER ON DRY AREAS OF THE SITE OR BY OTHER APPROVED MEANS THROUGHOUT ALL CONSTRUCTION OPERATIONS. WATERING TRUCKS SHALL BE USED AS NEEDED. THE USE OF MOTOR OILS AND OTHER PETROLEUM BASED OR TOXIC LIQUIDS FOR DUST SUPPRESSION OPERATIONS IS PROHIBITED.
- 11. THE CONTRACTOR SHALL FOLLOW ALL LOCAL AND STATE SOIL EROSION ORDINANCES TO INSURE THAT NO ON—SITE SOIL EROSION SEDIMENT LEAVES THE CONSTRUCTION SITE. ANY SOIL EROSION SEDIMENT OR CONSTRUCTION DEBRIS WHICH IS FOUND OFF—SITE SHALL BE PROMPTLY REMOVED AT CONTRACTOR'S SOLE EXPENSE.

RESTORATION NOTE

- 1. RESTORE ALL NON-PAVED AREAS WITH 3" OF CLEAN TOPSOIL AND SPECIFIED SEED MIX. PLACE MULCH IN ALL SEEDED AREAS. ON SLOPES IN EXCESS OF 10 HORIZONTAL TO 1 VERTICAL PLACE NORTH AMERICAN GREEN DS150 MULCH BLANKET IMMEDIATELY AFTER SEEDING. USE METAL STAPLES PER MANUFACTURERS RECOMMENDATIONS TO HOLD MATTING IN PLACE.
- RESTORE ALL CONCRETE SIDEWALKS, ADA RAMPS AND/OR OTHER PEDESTRIAN ACCESS ITEMS SO THAT ACCESS IS NOT RESTRICTED FOR MORE THAN 24 HOURS.
- CONTRACTOR SHALL PROVIDE TEMPORARY ADA PARKING STALLS, RAMPS, AND/OR OTHER ACCESSIBLE ROUTES AT ALL TIMES THAT PERMANENT ADA ITEMS ARE RESTRICTED.

1 EROSION CONTROL 07/07/20 WA
DATE BY

© 2020 KIMLEY-HORN AND ASSOCIATES, INC.

1001 WARRENVILLE ROAD, SUITE 350, LISLE, IL 609
PHONE: 630-487-5550

DATE
04/04/2020
SCALE AS SHOWN
DESIGNED BY ATO
DRAWN BY ATO

GENERAL NOTES

THE CENTER AT HOBBS BROOK TURBRIDGE, MA

SHEET NUMBER

C3-00