
- 1.) PROPERTY LINES/SITE FEATURES ARE THE RESULT OF AN ON THE GROUND SURVEY PERFORMED BY SUMMIT ENGINEERING & SURVEY, INC.
- 2.) ALL MATERIALS AND CONSTRUCTION PRACTICES SHALL BE IN CONFORMANCE WITH THE LATEST EDITION OF THE TOWN OF STURBRIDGE'S DEPARTMENT OF PUBLIC WORKS & PARKS STANDARD SPECIFICATIONS & DETAILS, UNLESS OTHERWISE SPECIFIED BY LOCAL AUTHORITY OR THE ENGINEER.
- 3.) THE CONTRACTOR SHALL UTILIZE ALL MEASURES AND MATERIALS NECESSARY TO ENSURE THE SAFETY OF ALL PERSONS AND PROPERTIES AT THE SITE DURING CONSTRUCTION. ALL EXCAVATIONS SHALL CONFORM TO CURRENT OSHA STANDARDS.
- 4.) UNLESS OTHERWISE NOTED, ALL DISTURBED AREAS SHALL BE DRESSED WITH A MINIMUM OF FOUR INCHES (4") OF LOAM AND SHALL BE SEEDED WITH AN APPROVED GRASS MIX.
- 5.) THE CONTRACTOR SHALL PROVIDE APPROPRIATE EROSION AND SEDIMENTATION CONTROL MEASURES AT ALL TIMES. DEWATERING OPERATIONS SHALL BE PROVIDED, IF REQUIRED; ALL DISCHARGE SHALL PASS THROUGH SEDIMENTATION CONTROL DEVICES TO PREVENT IMPACTS UPON WATER BODIES, BORDERING VEGETATED WETLANDS, DRAINAGE SYSTEMS AND ABUTTING PROPERTIES.
- 6.) DISTURBED AREAS SHALL BE STABILIZED BY LOAMING AND SEEDING SOON AFTER THE FINISHED GRADE HAS BEEN MET. IF FINAL GRADING DOES NOT OCCUR DURING THE GROWING SEASON, THESE AREAS SHALL BE MULCHED WITH HAY SECURED BY WEIGHTED SNOW FENCE, CHICKEN WIRE MESH OR JUTE NETTING WITH STAPLES. SEED FOR PERMANENT GRASS COVER SHOULD BE ACCORDING TO SOIL CONSERVATION SERVICE GUIDELINES FOR SOIL AND MOISTURE CONDITIONS FOUND ON THE SITE.
- 7.) SEDIMENTATION CONTROL FENCE AND/OR HAY BALES SHALL BE MAINTAINED UNTIL ALL SLOPES HAVE BEEN STABILIZED AND THERE IS NO DANGER OF EROSION DIRECTLY ONTO ABUTTING PROPERTIES
- 8.) PRIOR TO INITIATING CONSTRUCTION, SEDIMENTATION CONTROL DEVICES SHALL BE INSTALLED . THE CONTRACTOR SHALL MAINTAIN THE DEVICES UNTIL ALL WORK IS COMPLETE AND ALL AREAS HAVE BEEN STABILIZED.
- 9.) IF THE PROPOSED ROADWAY AREAS ARE NOT PAVED IMMEDIATELY AFTER THE INSTALLATION OF THE DRAINAGE STRUCTURES, HAY BALES SHALL BE PLACED TO PROTECT THE INTEGRITY OF THE STRUCTURES.
- 10.) THE LOCATION OF UNDERGROUND UTILITIES AND STRUCTURES ARE BASED ON FIELD AND RECORD INFORMATION. THE ENGINEER DOES NOT GUARANTEE THEIR ACCURACY OR THAT ALL UTILITIES AND SUBSURFACE STRUCTURES ARE SHOWN. THE CONTRACTOR SHALL VERIFY SIZE, LOCATION AND INVERT ELEVATIONS OF STRUCTURES AND UTILITIES, AS REQUIRED PRIOR TO THE START OF CONSTRUCTION. ANY DISCREPANCIES WITH RECORD DATA SHALL BE REPORTED TO THE ENGINEER IMMEDIATELY. PRIOR TO, AND DURING CONSTRUCTION, THE CONTRACTOR SHALL NOTIFY AND COORDINATE WITH THE LOCAL UTILITY COMPANIES, WITH THE TOWN OF STURBRIDGE'S HIGHWAY DEPARTMENT, OTHER TOWN UTILITY DEPARTMENTS, APPLICABLE PRIVATELY OWNED UTILITY COMPANIES AND DIG-SAFE (1-888-344-7233) TO VERIFY UTILITY LOCATION AND TO PROTECT UTILITIES DURING AND AFTER CONSTRUCTION.
- 11.) IT SHALL BE THE RESPONSIBILITY OF THE CONTRACTOR TO COORDINATE HIS WORK WITH THE APPROPRIATE HIGHWAY AND UTILITY DEPARTMENTS. CONTRACTOR SHALL MAINTAIN ALL EXISTING AND NEWLY INSTALLED UTILITIES IN GOOD WORKING ORDER AND SHALL PROTECT THEM FROM DAMAGE AT ALL TIMES UNTIL THE WORK IS COMPLETED AND ACCEPTED.
- 12.) THE CONTRACTOR SHALL PROVIDE FOR ALL TRAFFIC CONTROL IN ACCORDANCE WITH THE TOWN OF STURBRIDGE REQUIREMENTS.
- 13.) NO TRENCHES SHALL BE ALLOWED TO REMAIN OPEN OVERNIGHT.
- 14.) ALL POTABLE WATER AND SANITARY BUILDING SERVICE CONNECTIONS SHALL BE SEPARATED HORIZONTALLY BY A MINIMUM OF TEN FEET.
- 15.) TREE WORK MUST BE COMPLETED BY COMPANIES HOLDING CURRENT COMPLIANCE AGREEMENTS WITH THE MASSACHUSETTS LONGHORNED BEETLE ERADICATION PROJECT. ANY COMPANY CAN BECOME COMPLIANT BY ATTENDING A TRAINING SESSION AT THE PROGRAM OFFICE IN WORCESTER,

DEFINITIVE SITE PLAN at 6 PICKER ROAD STURBRIDGE, MA

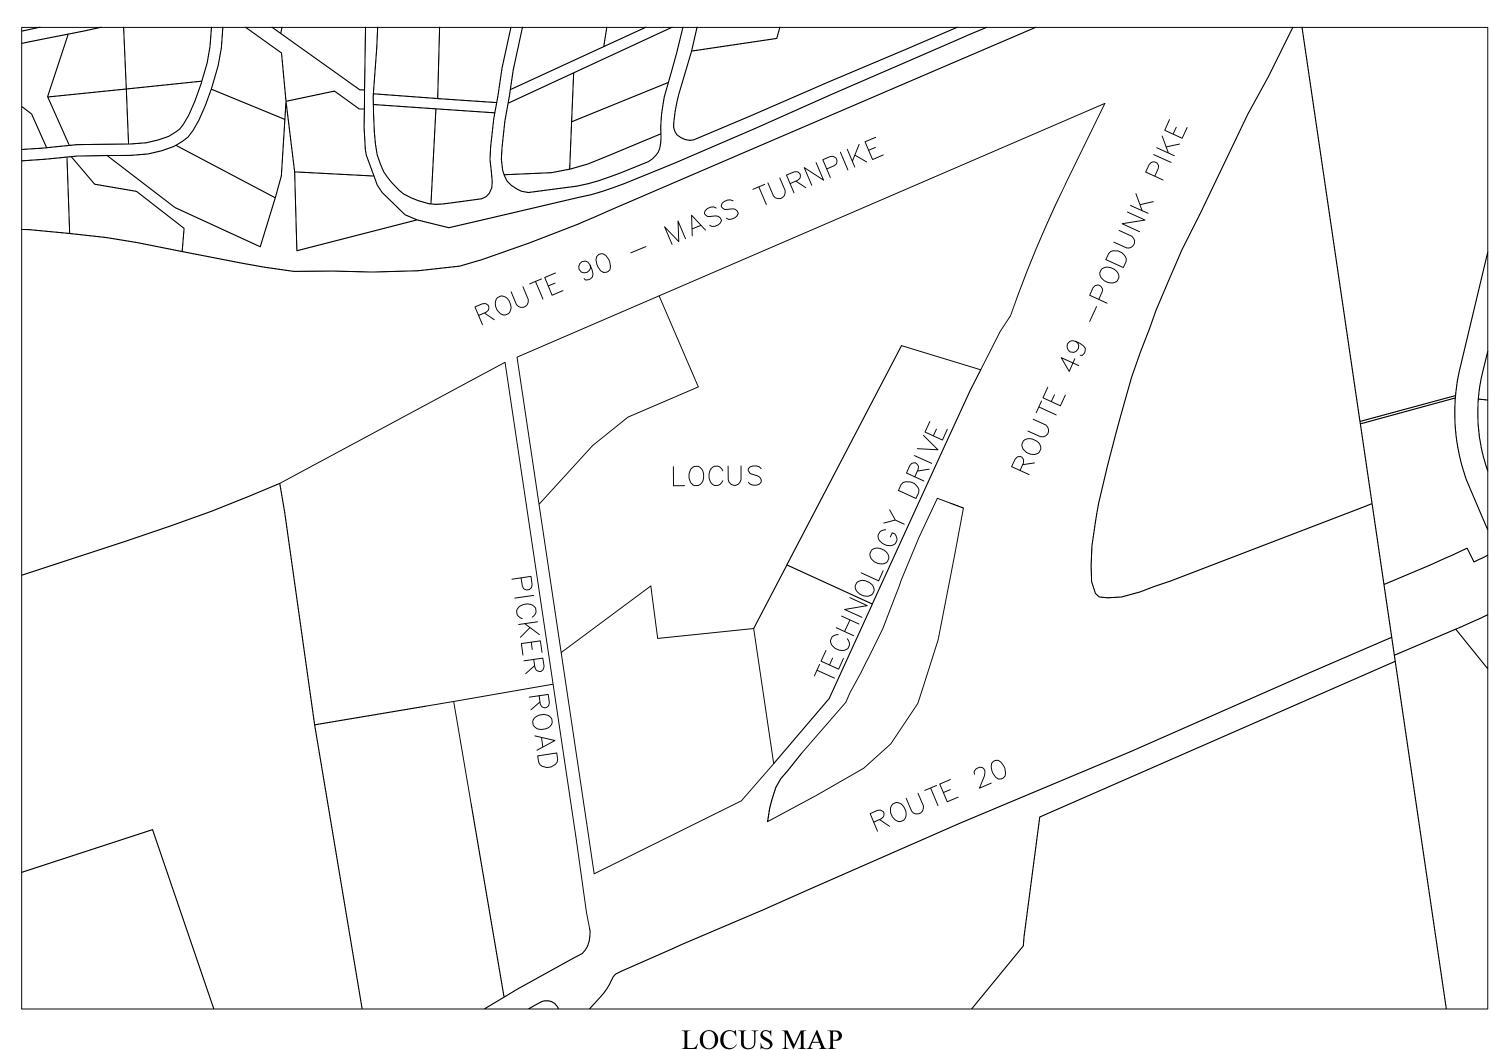

 $SCALE: 1" = 250' \pm$

LIST OF DRAWINGS:

SHEET - 1	COVER SHEET	SHEET - 14	LANDSCAPE
SHEET - 2	EXISTING CONDITIONS	SHEET - 15	LANDSCAPE
SHEET - 3	EXISTING CONDITIONS	SHEET - 16	CONSTRUCTION DETAILS
SHEET - 4	DEMO PLAN	SHEET - 17	CONSTRUCTION DETAILS
SHEET - 5	DEMO PLAN	SHEET - 18	CONSTRUCTION DETAILS
SHEET - 6	EROSION & SEDIMENTATION CONTROL	SHEET - 19	CONSTRUCTION DETAILS
SHEET - 7	EROSION & SEDIMENTATION CONTROL		
SHEET - 8	GRADING/DRAINAGE		
SHEET - 9	GRADING/DRAINAGE		
SHEET - 8	GRADING/DRAINAGE		

SHEET - 10

SHEET - 11

SHEET - 12

SHEET - 13

PAVING PLAN

PAVING PLAN

LAYOUT/UTILITY

LAYOUT/UTILITY



ZONING DISTRICT:

ZONE: INDUSTRIAL AREA: 87,120 SQ. FT. FRONTAGE: 300'

> SETBACK REQUIREMENTS FRONT: 60' SIDE: 30' REAR: 30' MAX. HEIGHT (MEAN): 35'

RECORD OWNER: ONE PICKER REALTY TRUST DANIEL PROUTY, TRUSTEE Bk. 34336 Pg. 243 ASSESSORS ID: 510-02215-0006

FOR PERMITTING ONLY: NOT FOR CONSTRUCTION



ARCO **DESIGN/BUILD**

380 Interstate North Pkwy. SE, Atlanta, GA 30339





710 Main Street North Oxford, MA 01537



NEW ENGLAND COLD STORAGE, LLC.

> 6 PICKER ROAD STURBRIDGE, MA

> > COVER

6/1/20 - PER CONSERVATION COMMISSION COMMENTS REVISIONS

SCALE: AS SHOWN DATE: 20-122 JOB NO:


MAY 12, 2020 20-122 DEFINITIVE SITE PLAN PLAN NO: SHEET NO: 1 OF 19

PLAN NOTES:

1. EXISTING AND BOUNDARY CONDITIONS ARE THE RESULT OF AN ON THE GROUND SURVEY PERFORMED BY SUMMIT ENGINEERING & SURVEY, INC.

2. WETLAND FLAGS DELINEATED BY EBT ENVIRONENTAL, INC. AND LOCATED BY SUMMIT

ENGINEERING & SURVEY, INC. 3. BORING TESTS PERFORMED BY WHITESTONE ASSOCIATES, INC. ON 3/18/2020. REFER TO "REPORT OF GEOTECHNICAL FINDINGS, PROPOSED COLD STORAGE FACILITY, SIX PICKER ROAD, MAP 510 BLOCK 2215 LOT 6, STURBRIDGE WORCESTER COUNTY MASSACHUSETTS" DATED APRIL 10, 2020 BY WHITESTONE ASSOCIATES, INC. PROJECT NO.: GM2017067.000.

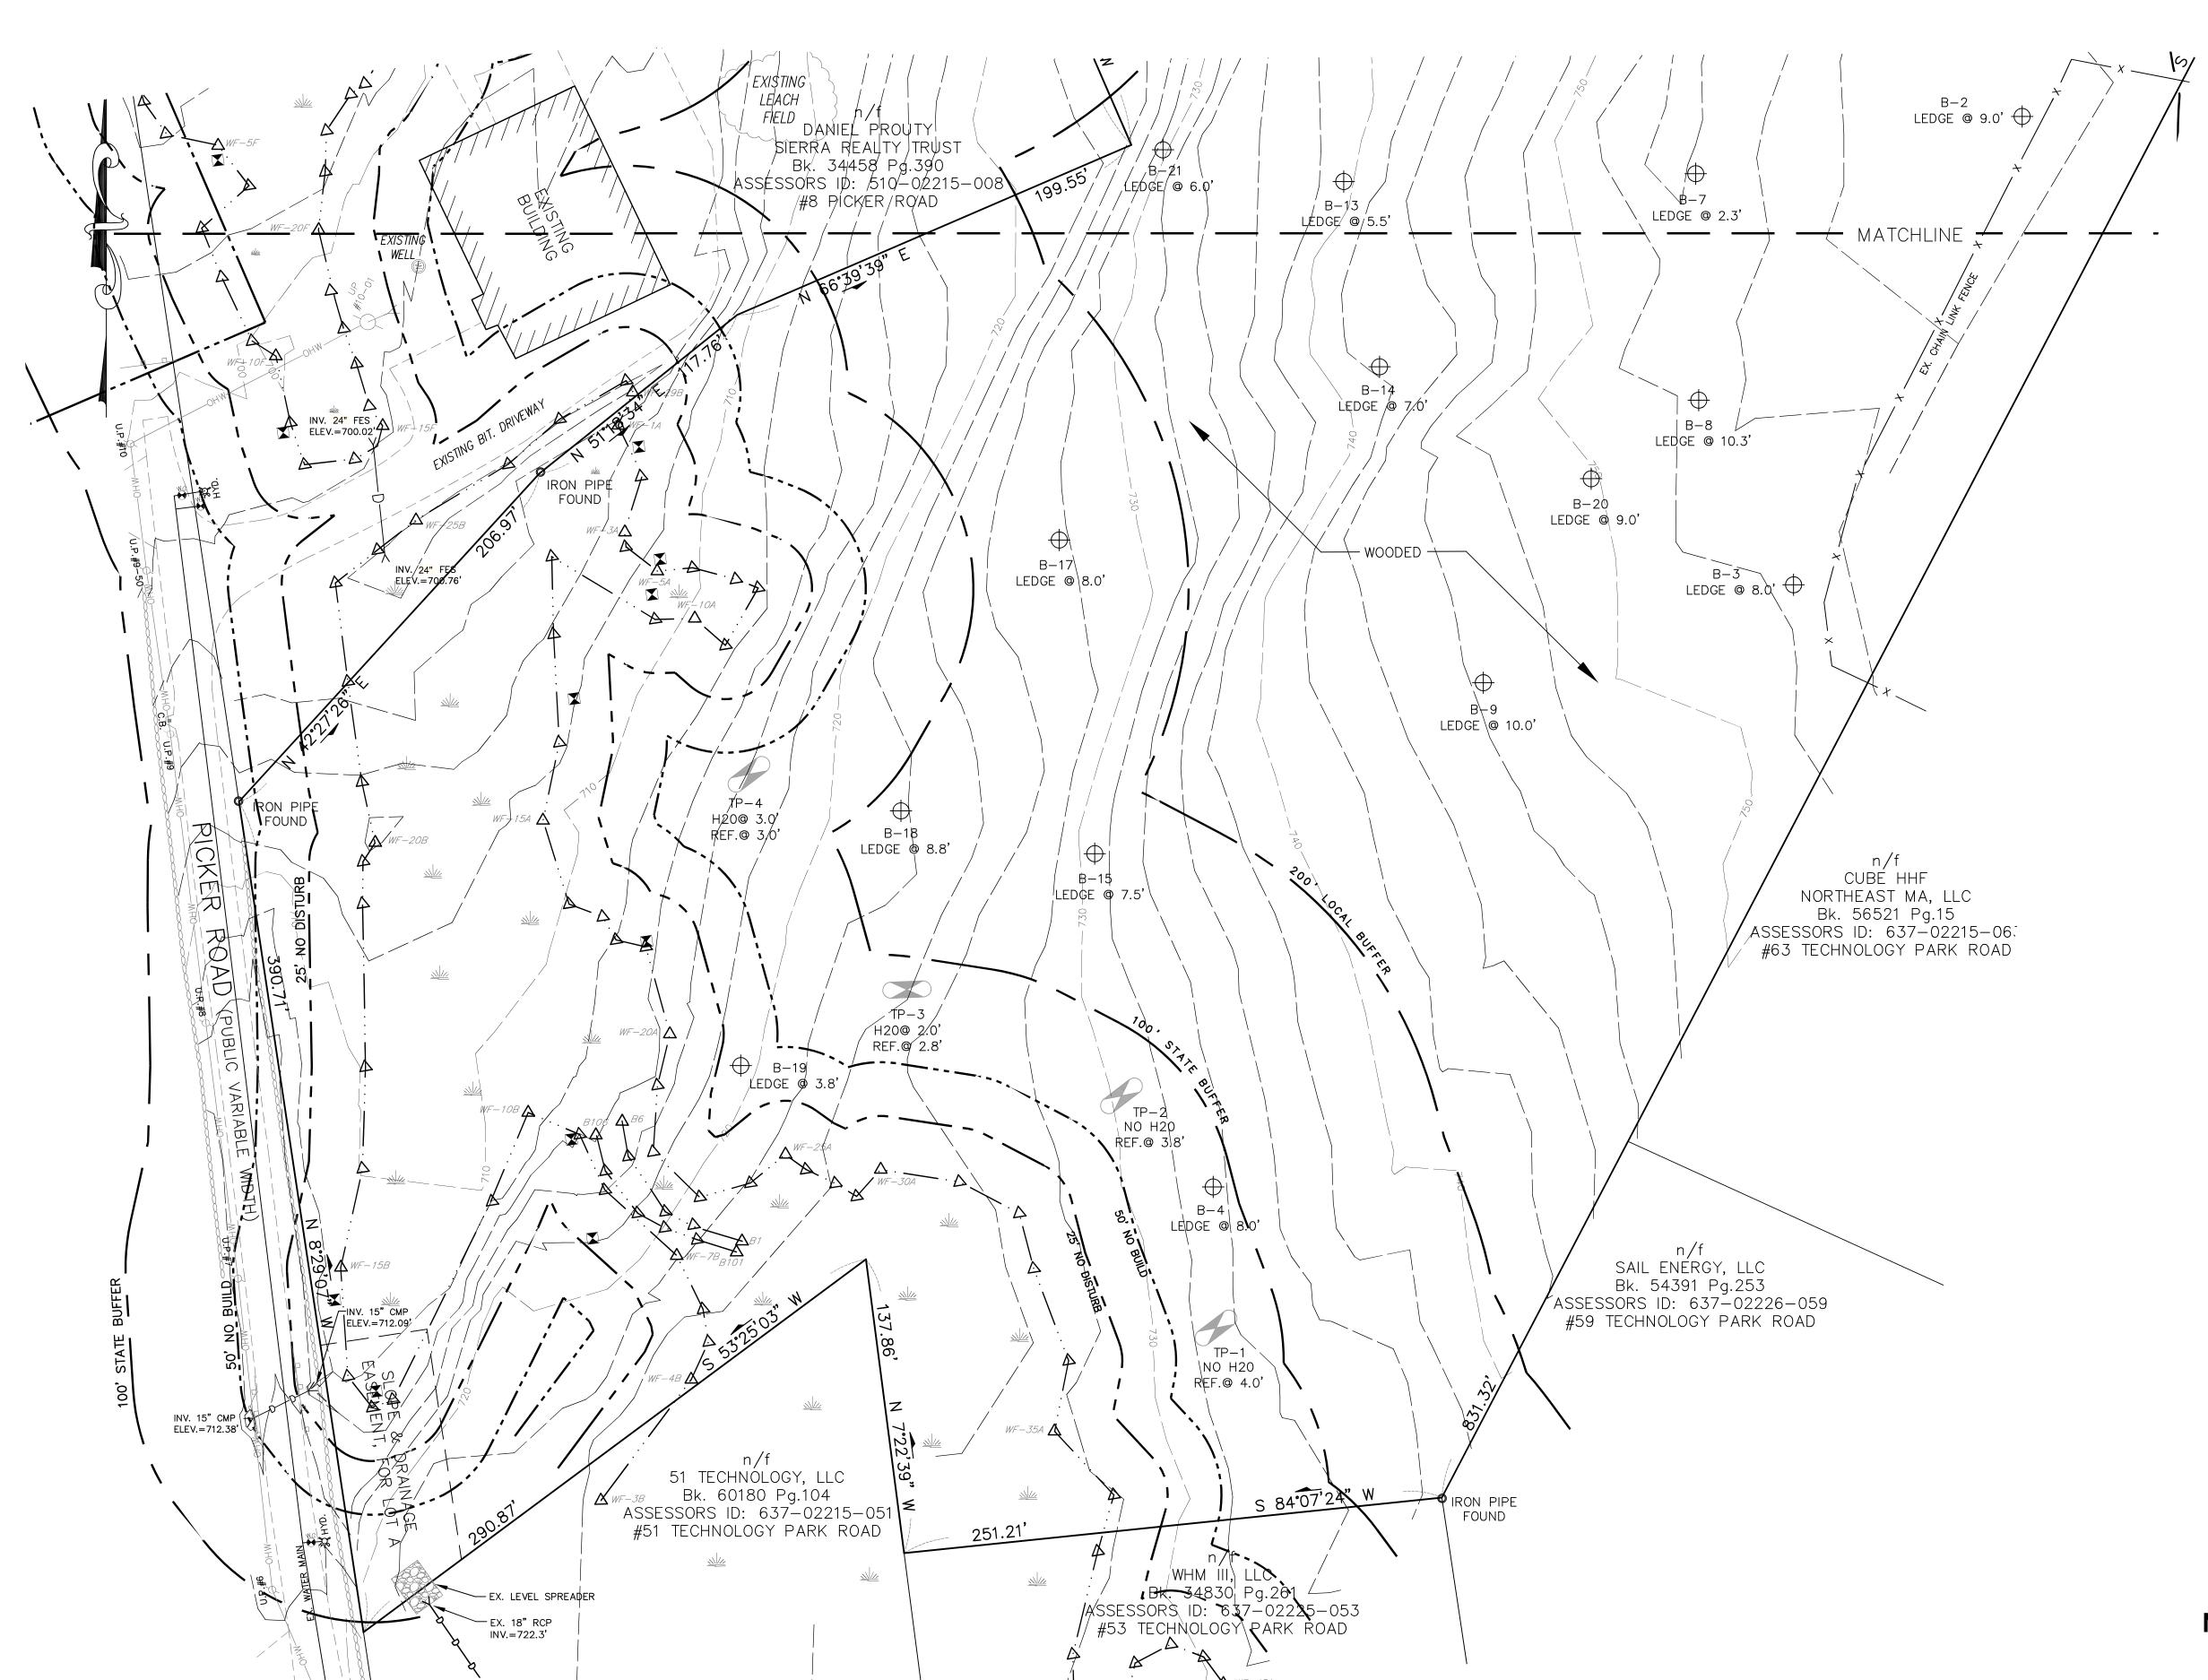






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NEW ENGLAND COLD STORAGE, LLC.

6 PICKER ROAD STURBRIDGE, MA

EXISTING CONDITIONS

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<u>LEGEN</u>D

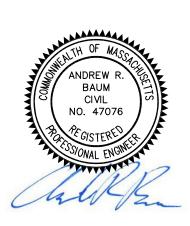DRILL HOLE FOUND

SEWER MANHOLE

DRAIN MANHOLE

CATCH BASIN

CLEANOUT MONITORING WELL ANCHOR UTILITY POLE WATER GATE VALVE WATER SHUT OFF HYDRANT BENCHMARK GAS VALVE

SPOT LIGHT

BOLLARD

BOULDER

ELECTRIC LINE

STONEWALL

BORDERING VEGETATED WETLANDS

PROPERTY LINE

EDGE OF PAVEMENT

EDGE OF LANDSCAPING

CNCRB

BTCRB

——S——S——S SEWER LINE

T—T—T—T—TELEPHONE LINE

----OHW---OHW---OHW---OVERHEAD WIRES -----C----C CABLE TELEVISION

GUARD RAILING (AS NOTED)

TREE LINE

____D___D___D DRAIN LINE

MAILBOX (MBX)

ELECTRIC MANHOLE

TELEPHONE MANHOLE WATER MANHOLE

UNDETERMINED MANHOLE

LIGHT POLE / LAMP POST

OBSERVATION TEST PIT

HYDRIC SOIL TEST PIT

SHRUBS, BUSHES, ETC. DECIDUOUS TREE CONIFEROUS TREE WETLAND FLAG


VERTICAL GRANITE CURBING CONCRETE CURBING

CAPE COD BERM (BITUMINOUS)

BITUMINOUS CURBING (GENERIC)

BORING TEST PIT

STONE OR CONCRETE MONUMENTS

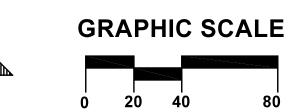


/20 - PER CONSERVATION COMMISSION COMM
REVISIONS

SCALE: 1" = 40' MAY 12, 2020 DATE: 20-122 JOB NO: 20-122 DEFINITIVE SITE PLAN PLAN NO:

SHEET NO:

2 OF 19

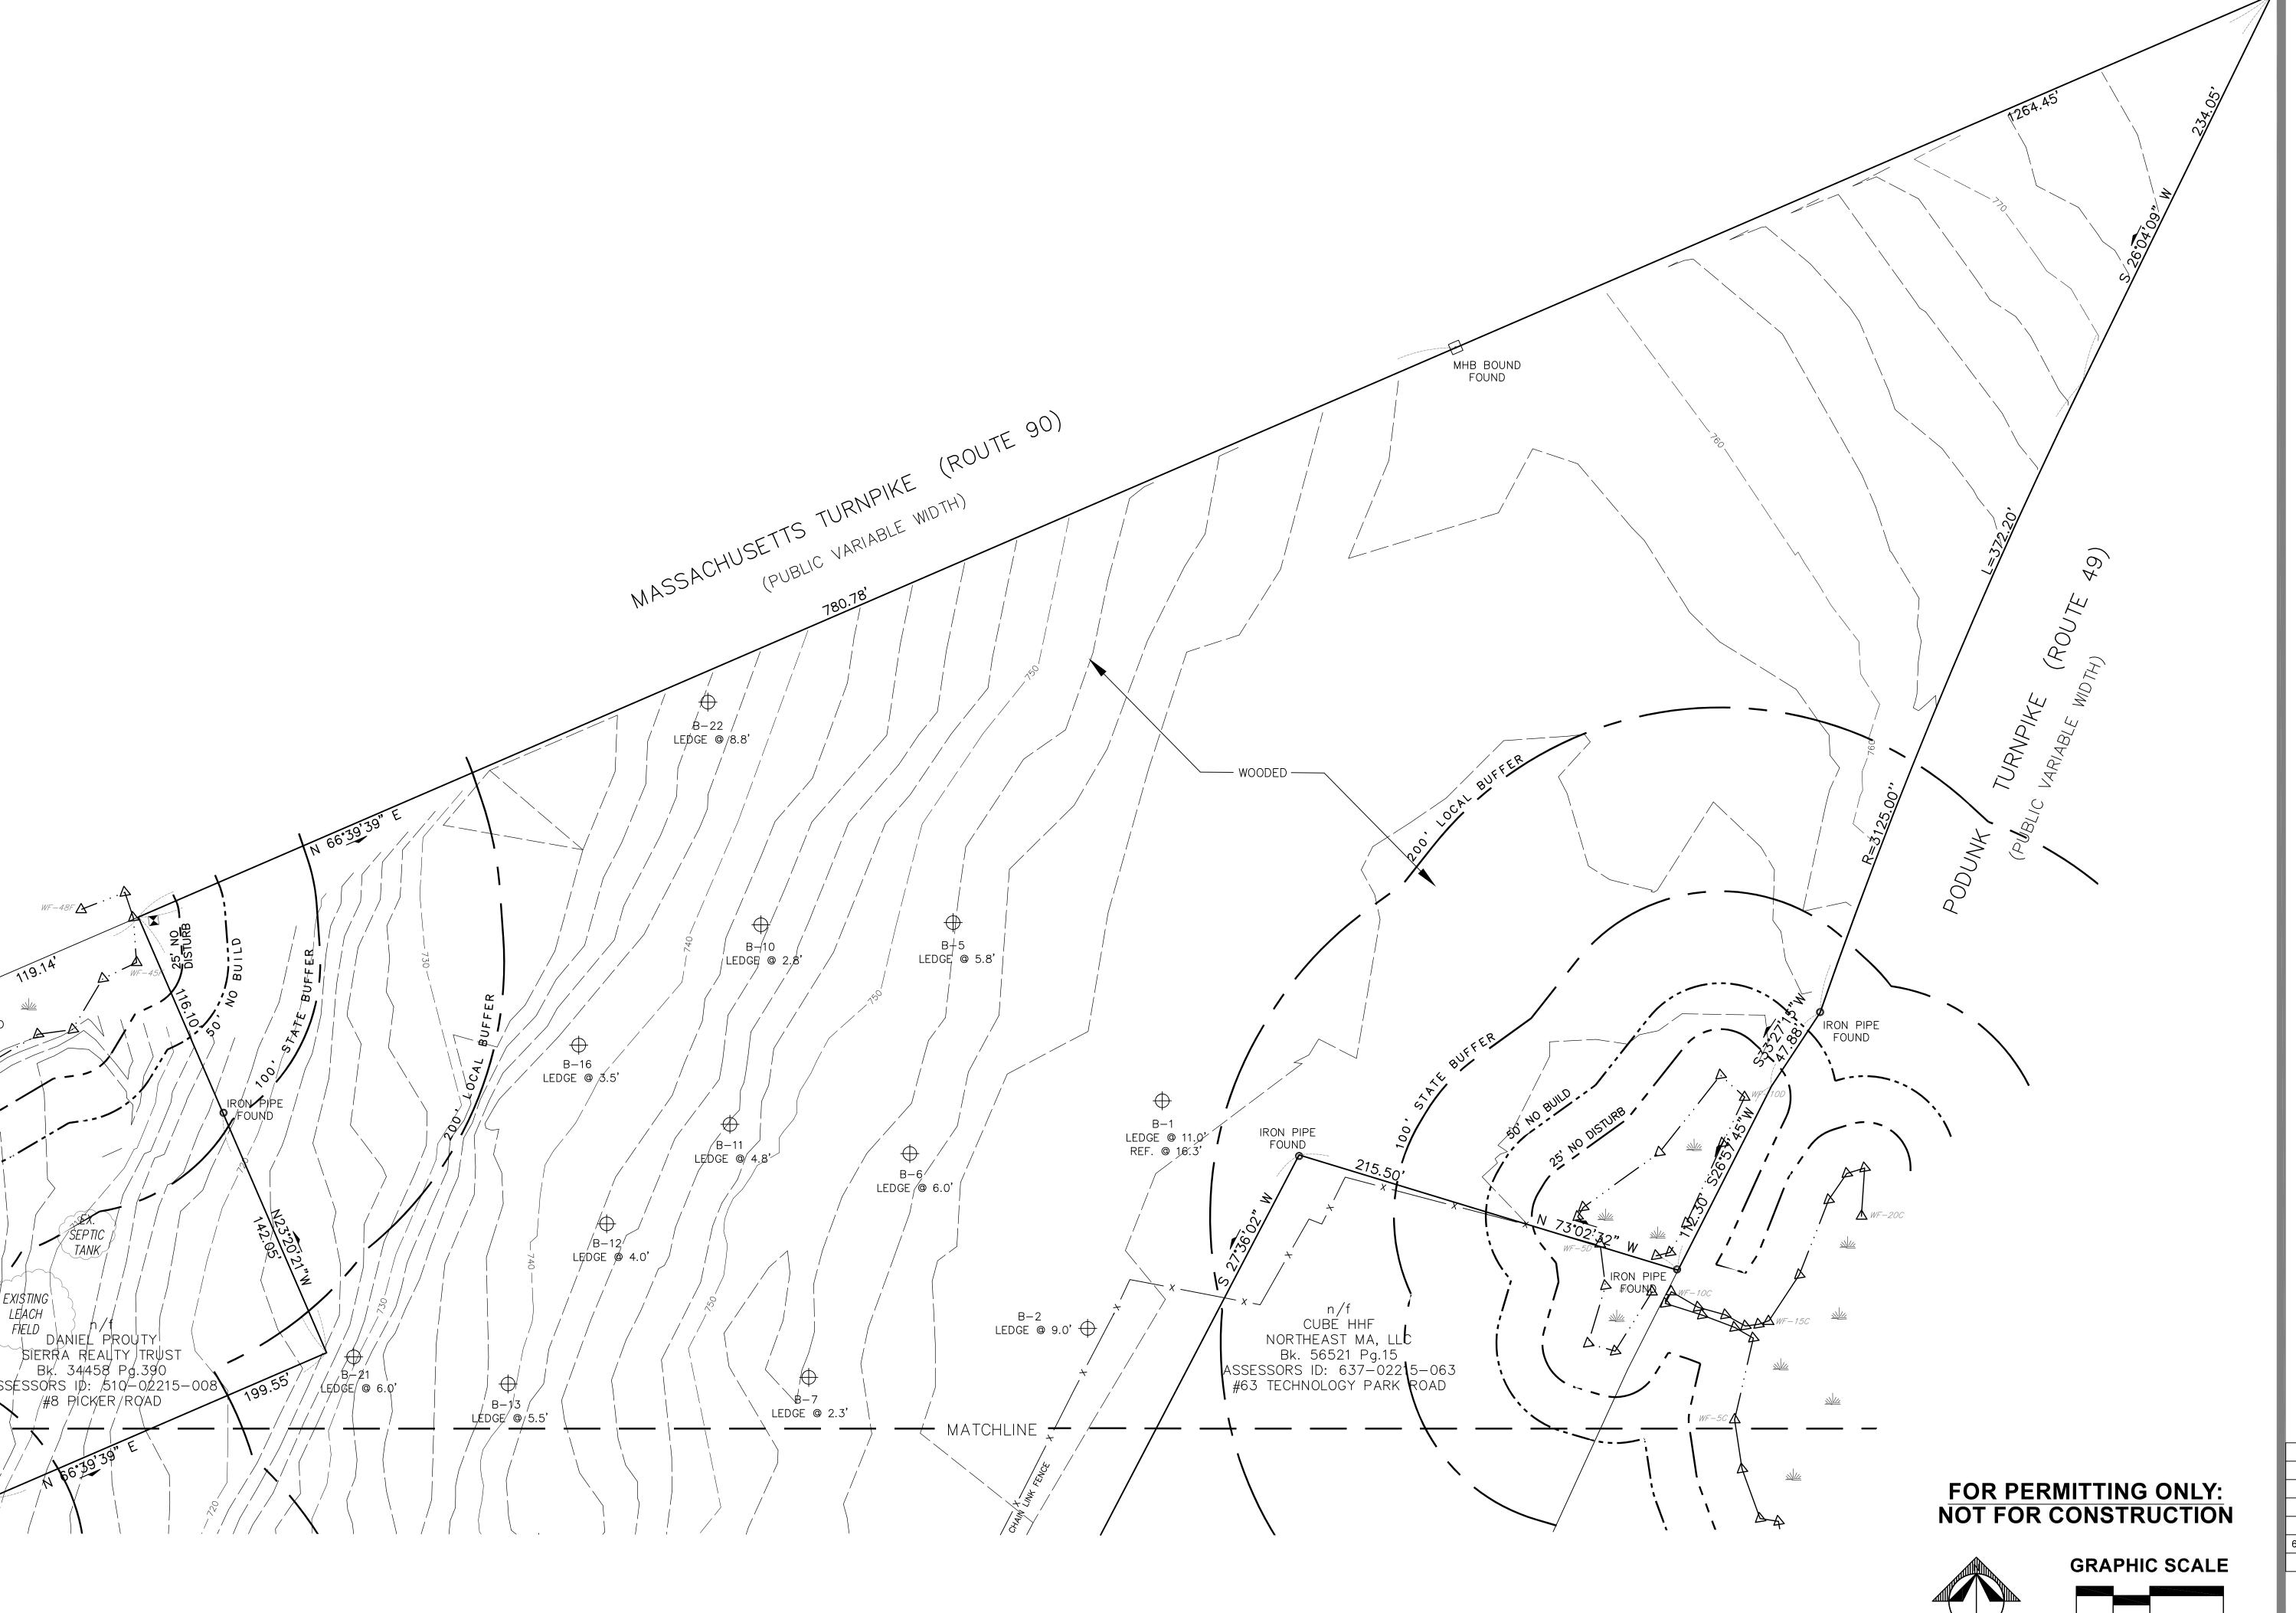










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NEW ENGLAND COLD STORAGE, LLC.
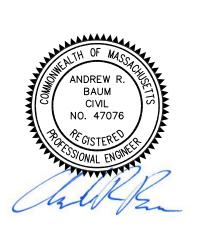
> 6 PICKER ROAD STURBRIDGE, MA

EXISTING CONDITIONS

6/1/20 - PER CONSERVATION COMMISSION COMMENTS
REVISIONS

REVISIONS
SCALE: 1" = 40'

SHEET NO:


 SCALE:
 1" = 40'

 DATE:
 MAY 12, 2020

 JOB NO:
 20-122

 PLAN NO:
 20-122 DEFINIT

20-122 DEFINITIVE SITE PLAN 3 OF 19

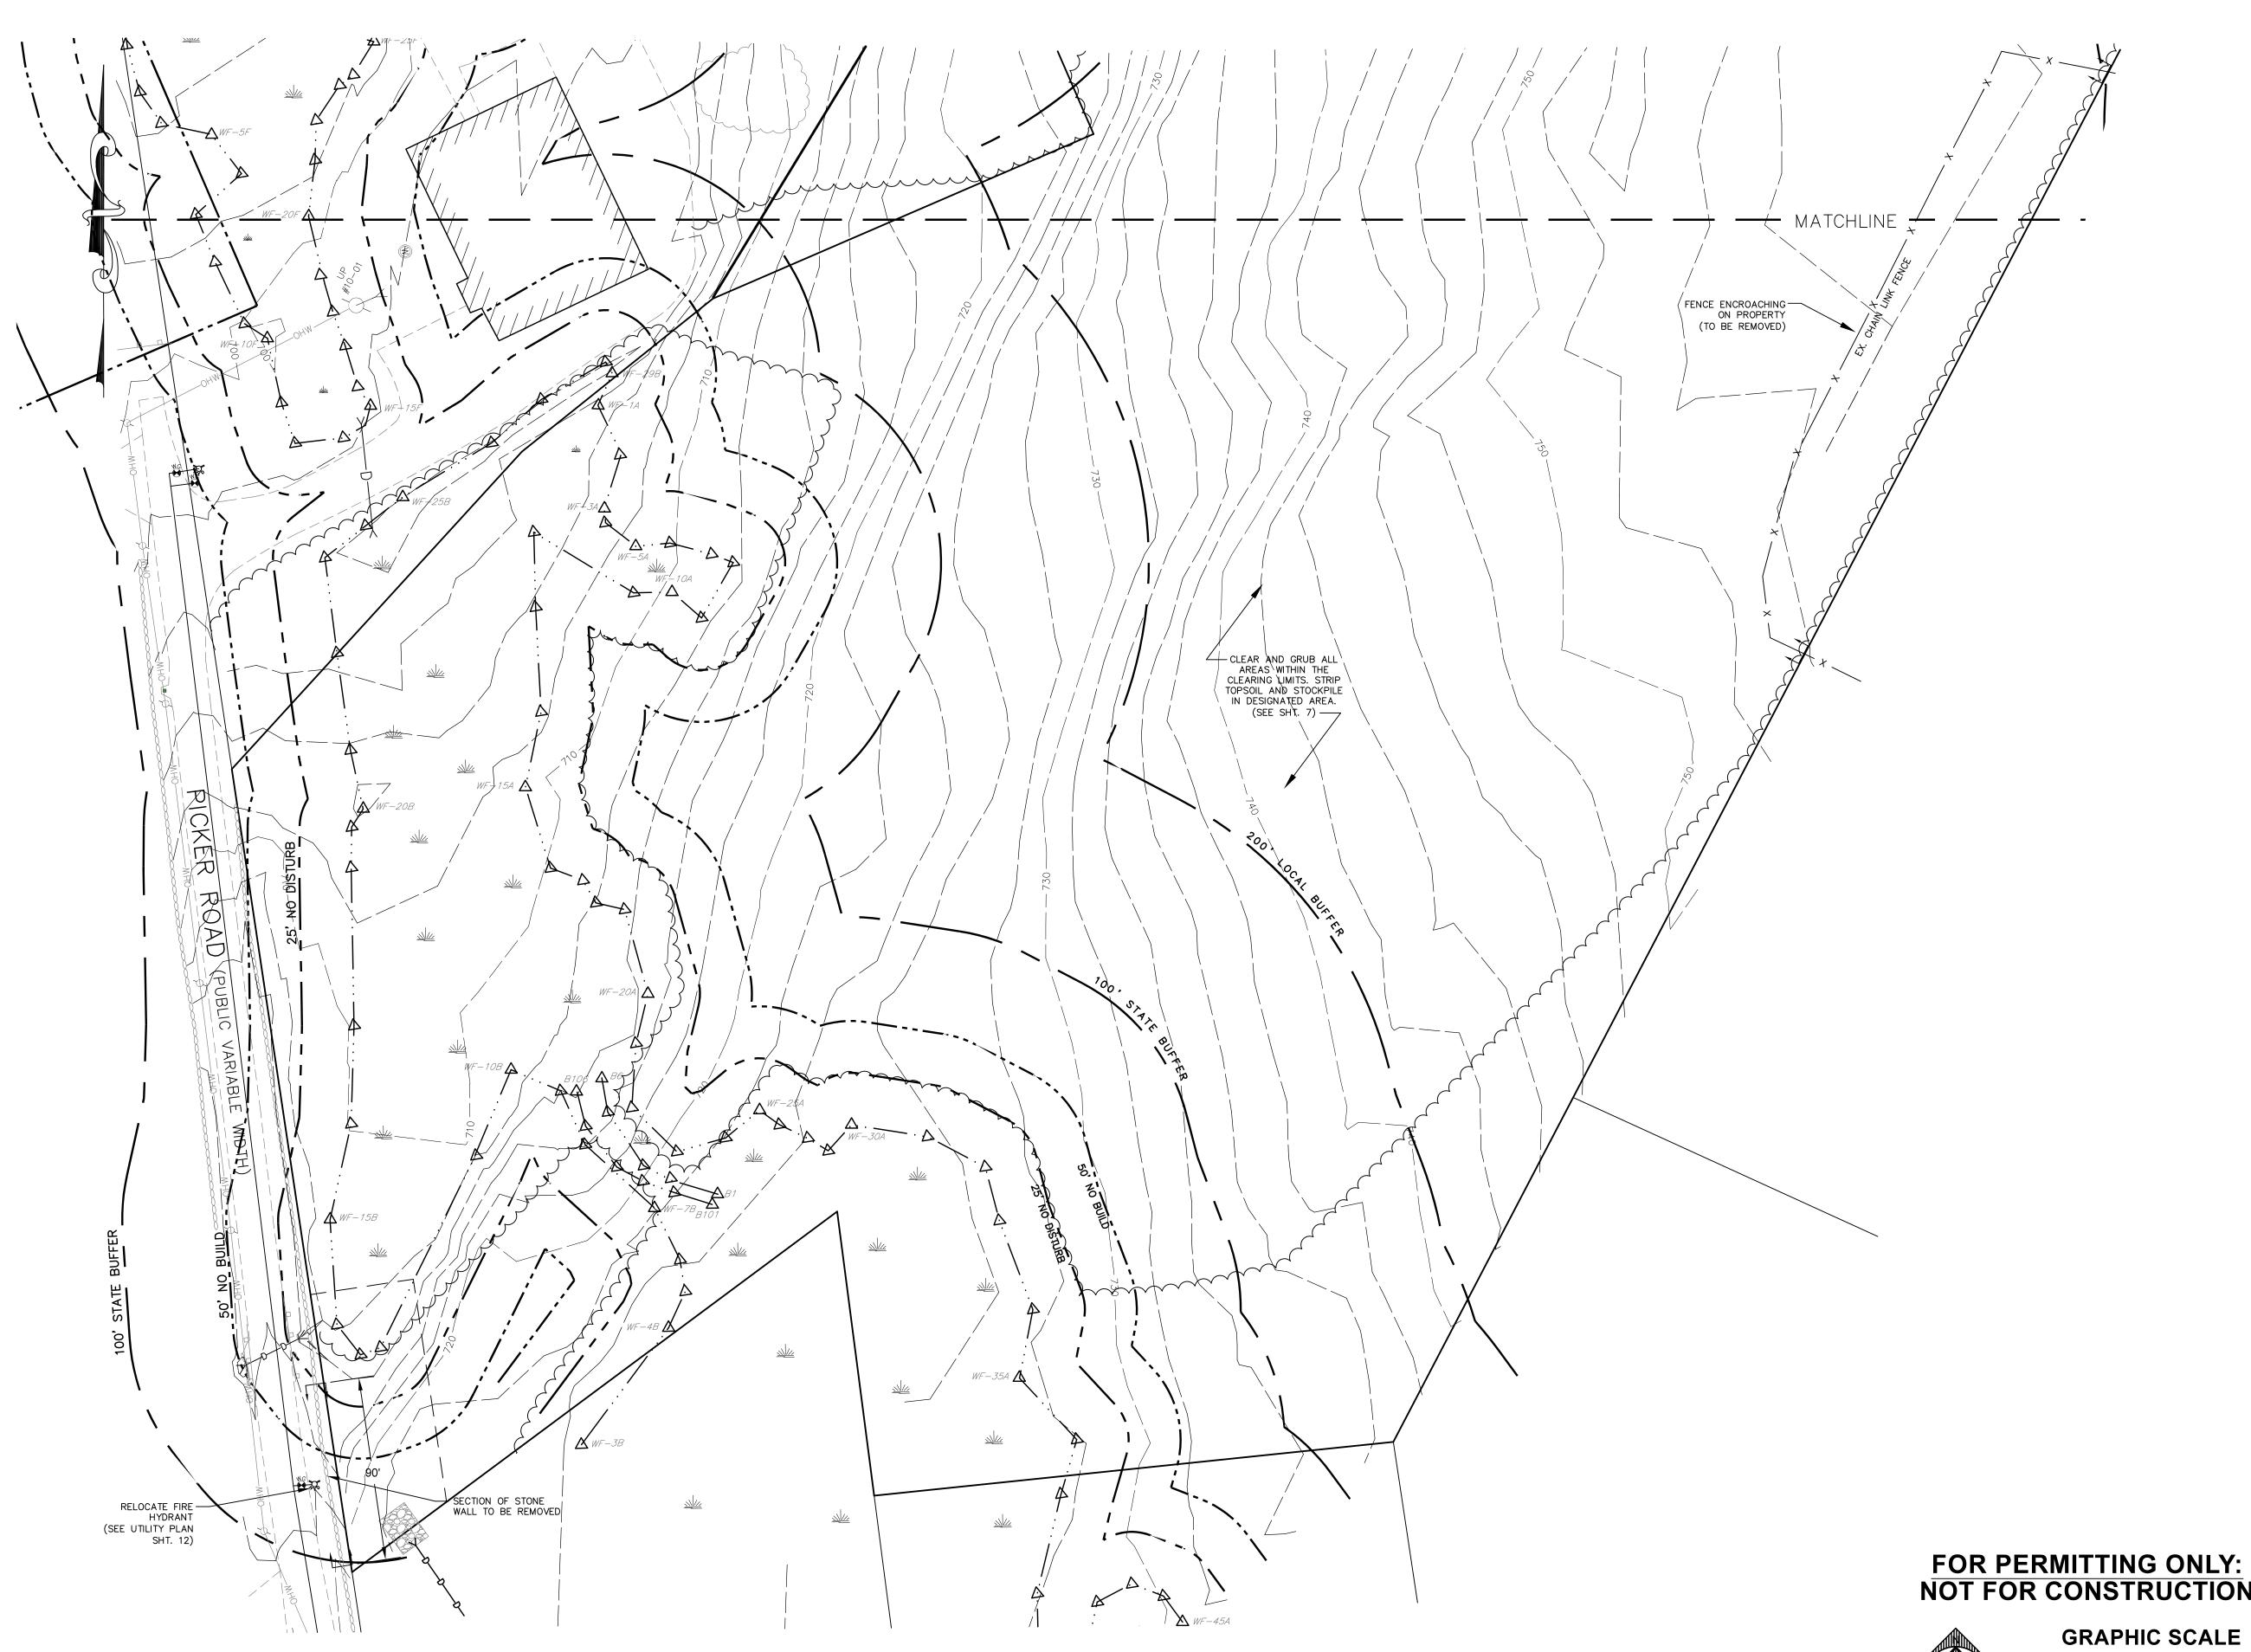










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NEW ENGLAND COLD STORAGE, LLC.

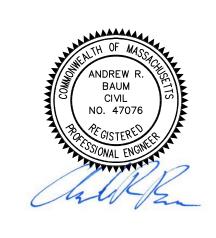6 PICKER ROAD STURBRIDGE, MA

DEMO PLAN




6/1/20 - PER CONSERVATION COMMISSION COMMENTS REVISIONS

SHEET NO:

SCALE: DATE: JOB NO: PLAN NO:

1" = 40' MAY 12, 2020 20-122 20-122 DEFINITIVE SITE PLAN 4 OF 19

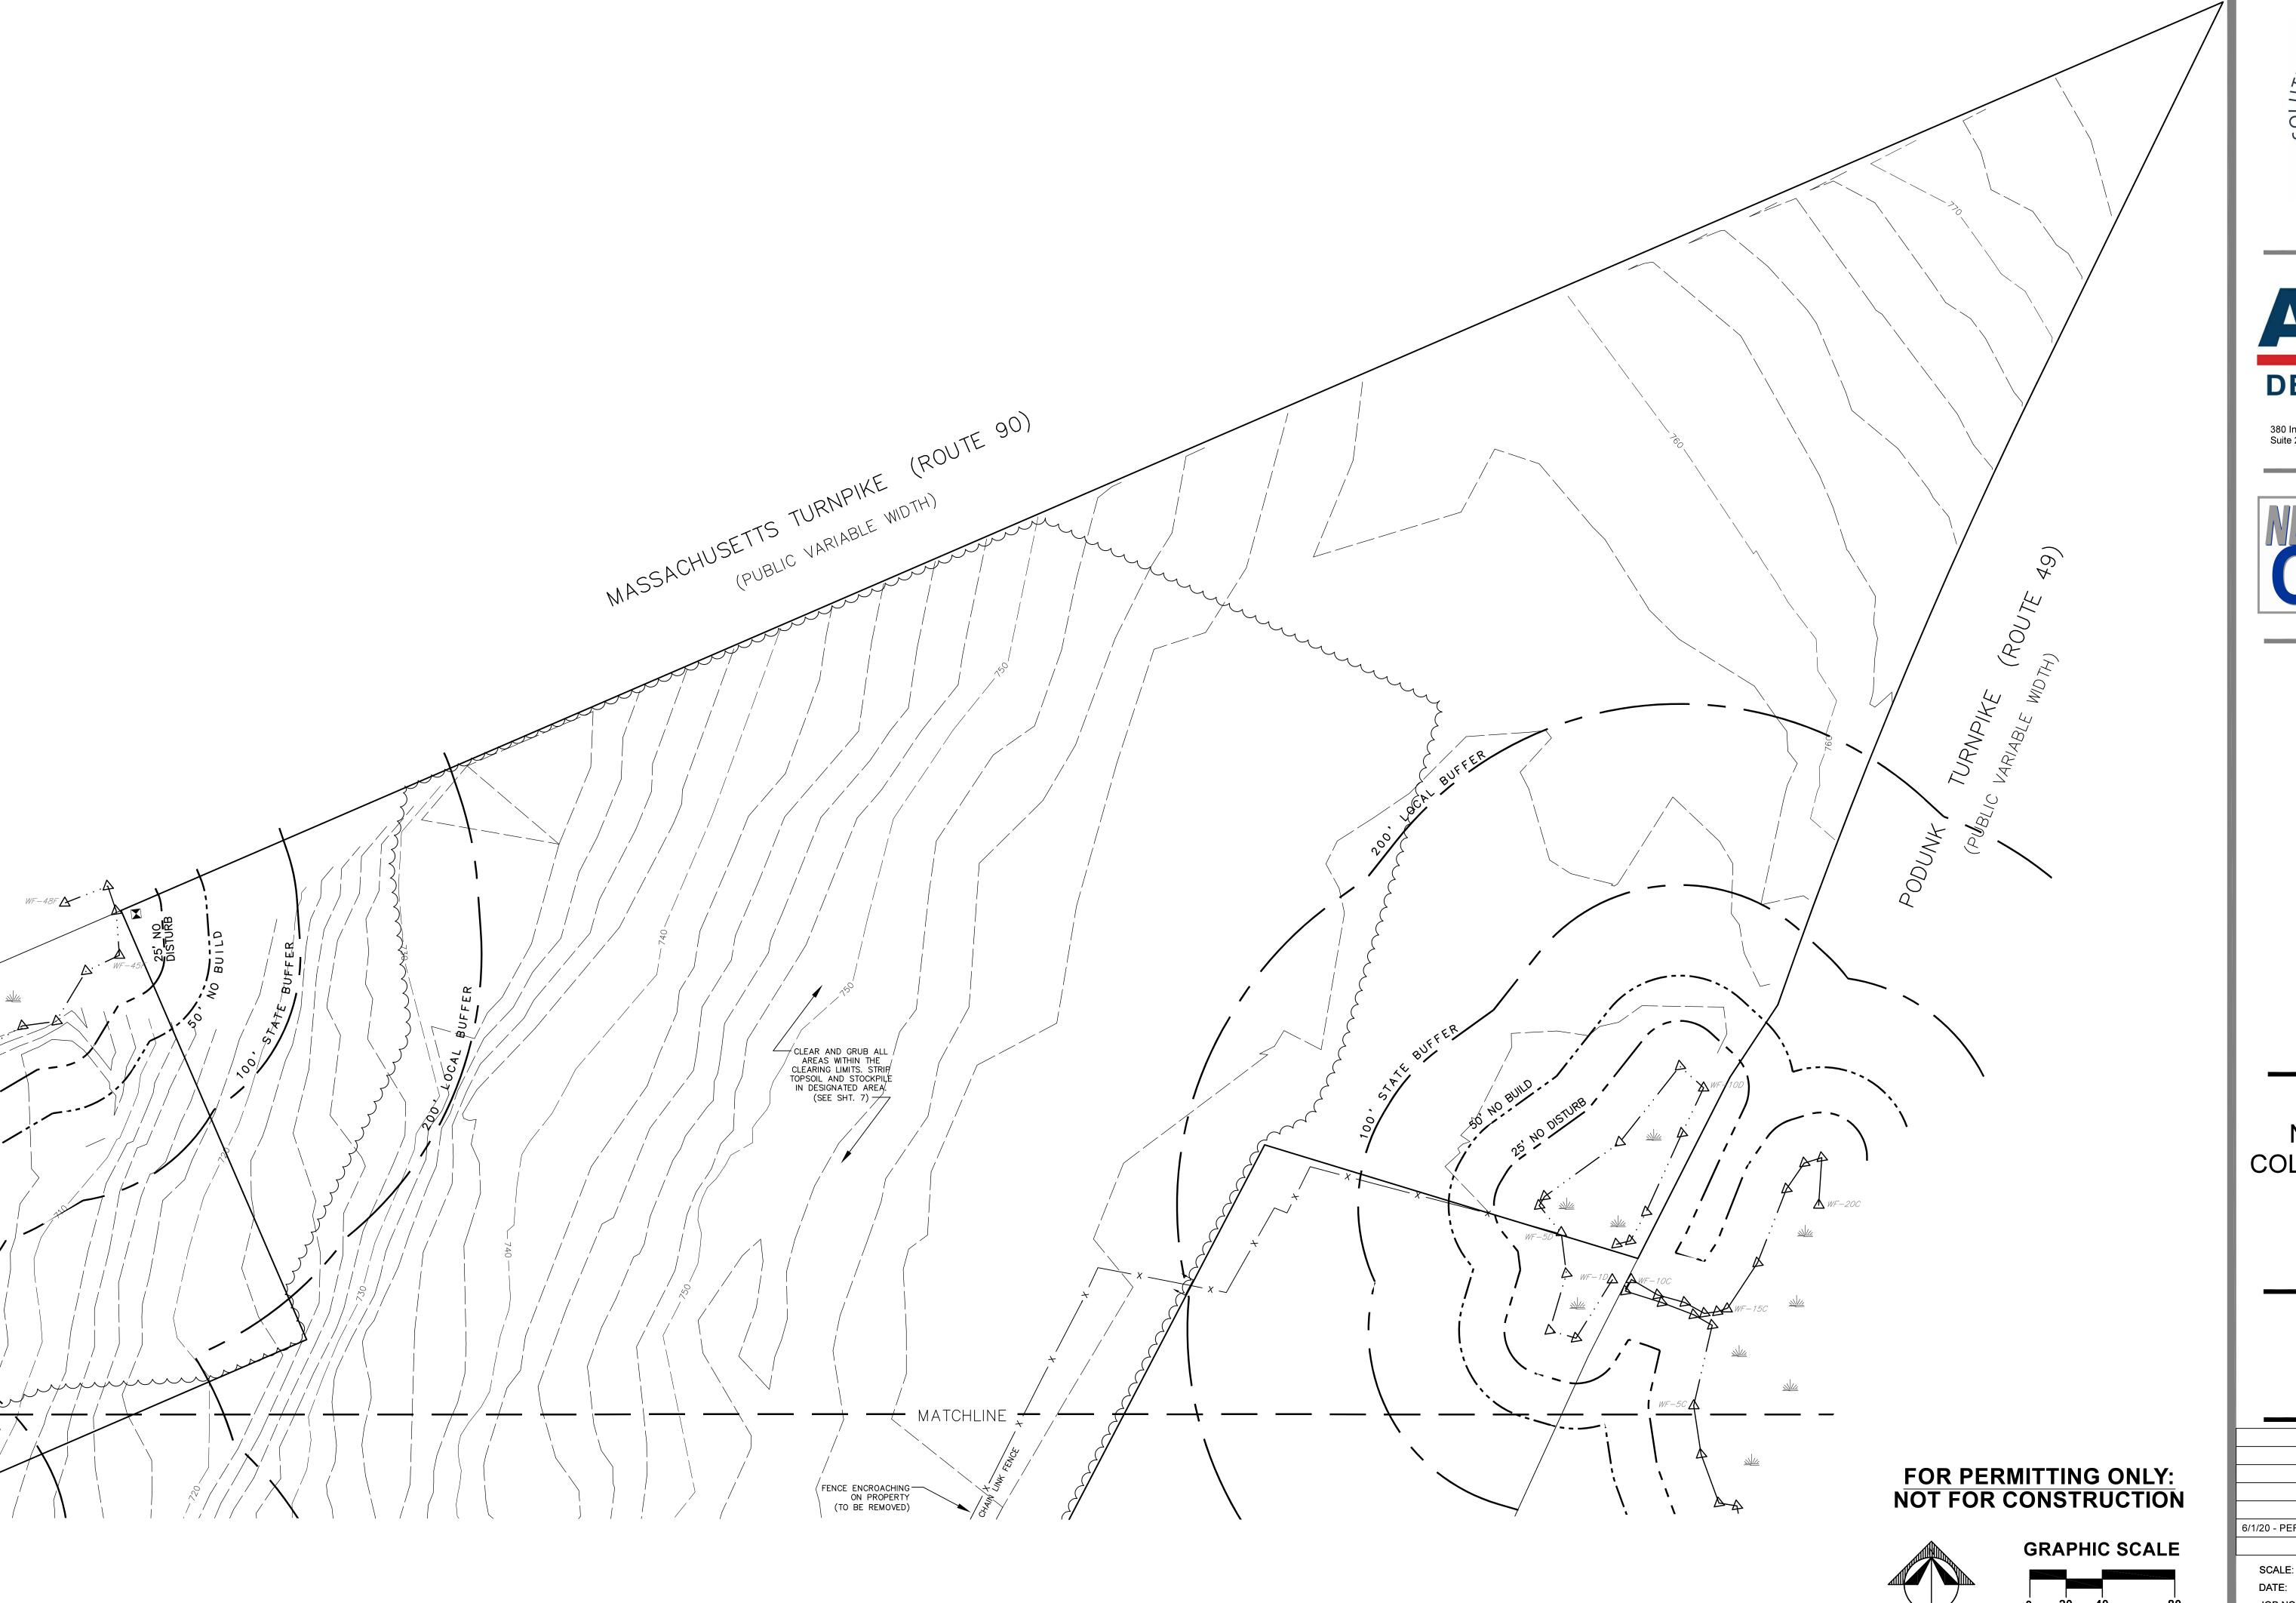










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NEW ENGLAND COLD STORAGE, LLC.
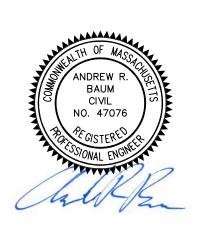
> 6 PICKER ROAD STURBRIDGE, MA

DEMO PLAN

6/1/20 - PER CONSERVATION COMMISSION COMMENTS

REVISIONS

 SCALE:
 1" = 40'

 DATE:
 MAY 12,

 JOB NO:
 20-122

 PLAN NO:
 20-122 D

SHEET NO:

MAY 12, 2020 20-122 20-122 DEFINITIVE SITE PLAN












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NEW ENGLAND COLD STORAGE, LLC.
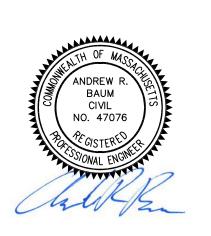
> 6 PICKER ROAD STURBRIDGE, MA

EROSION & SEDIMENTATION CONTROL


6/1/20 - PER CONSERVATION COMMISSION COMMENTS

REVISIONS

1" = 40"

SCALE:
DATE:
JOB NO:
PLAN NO:
SHEET NO:

1" = 40'
MAY 12, 2020
20-122
20-122 DEFINITIVE SITE PLAN
7 OF 19

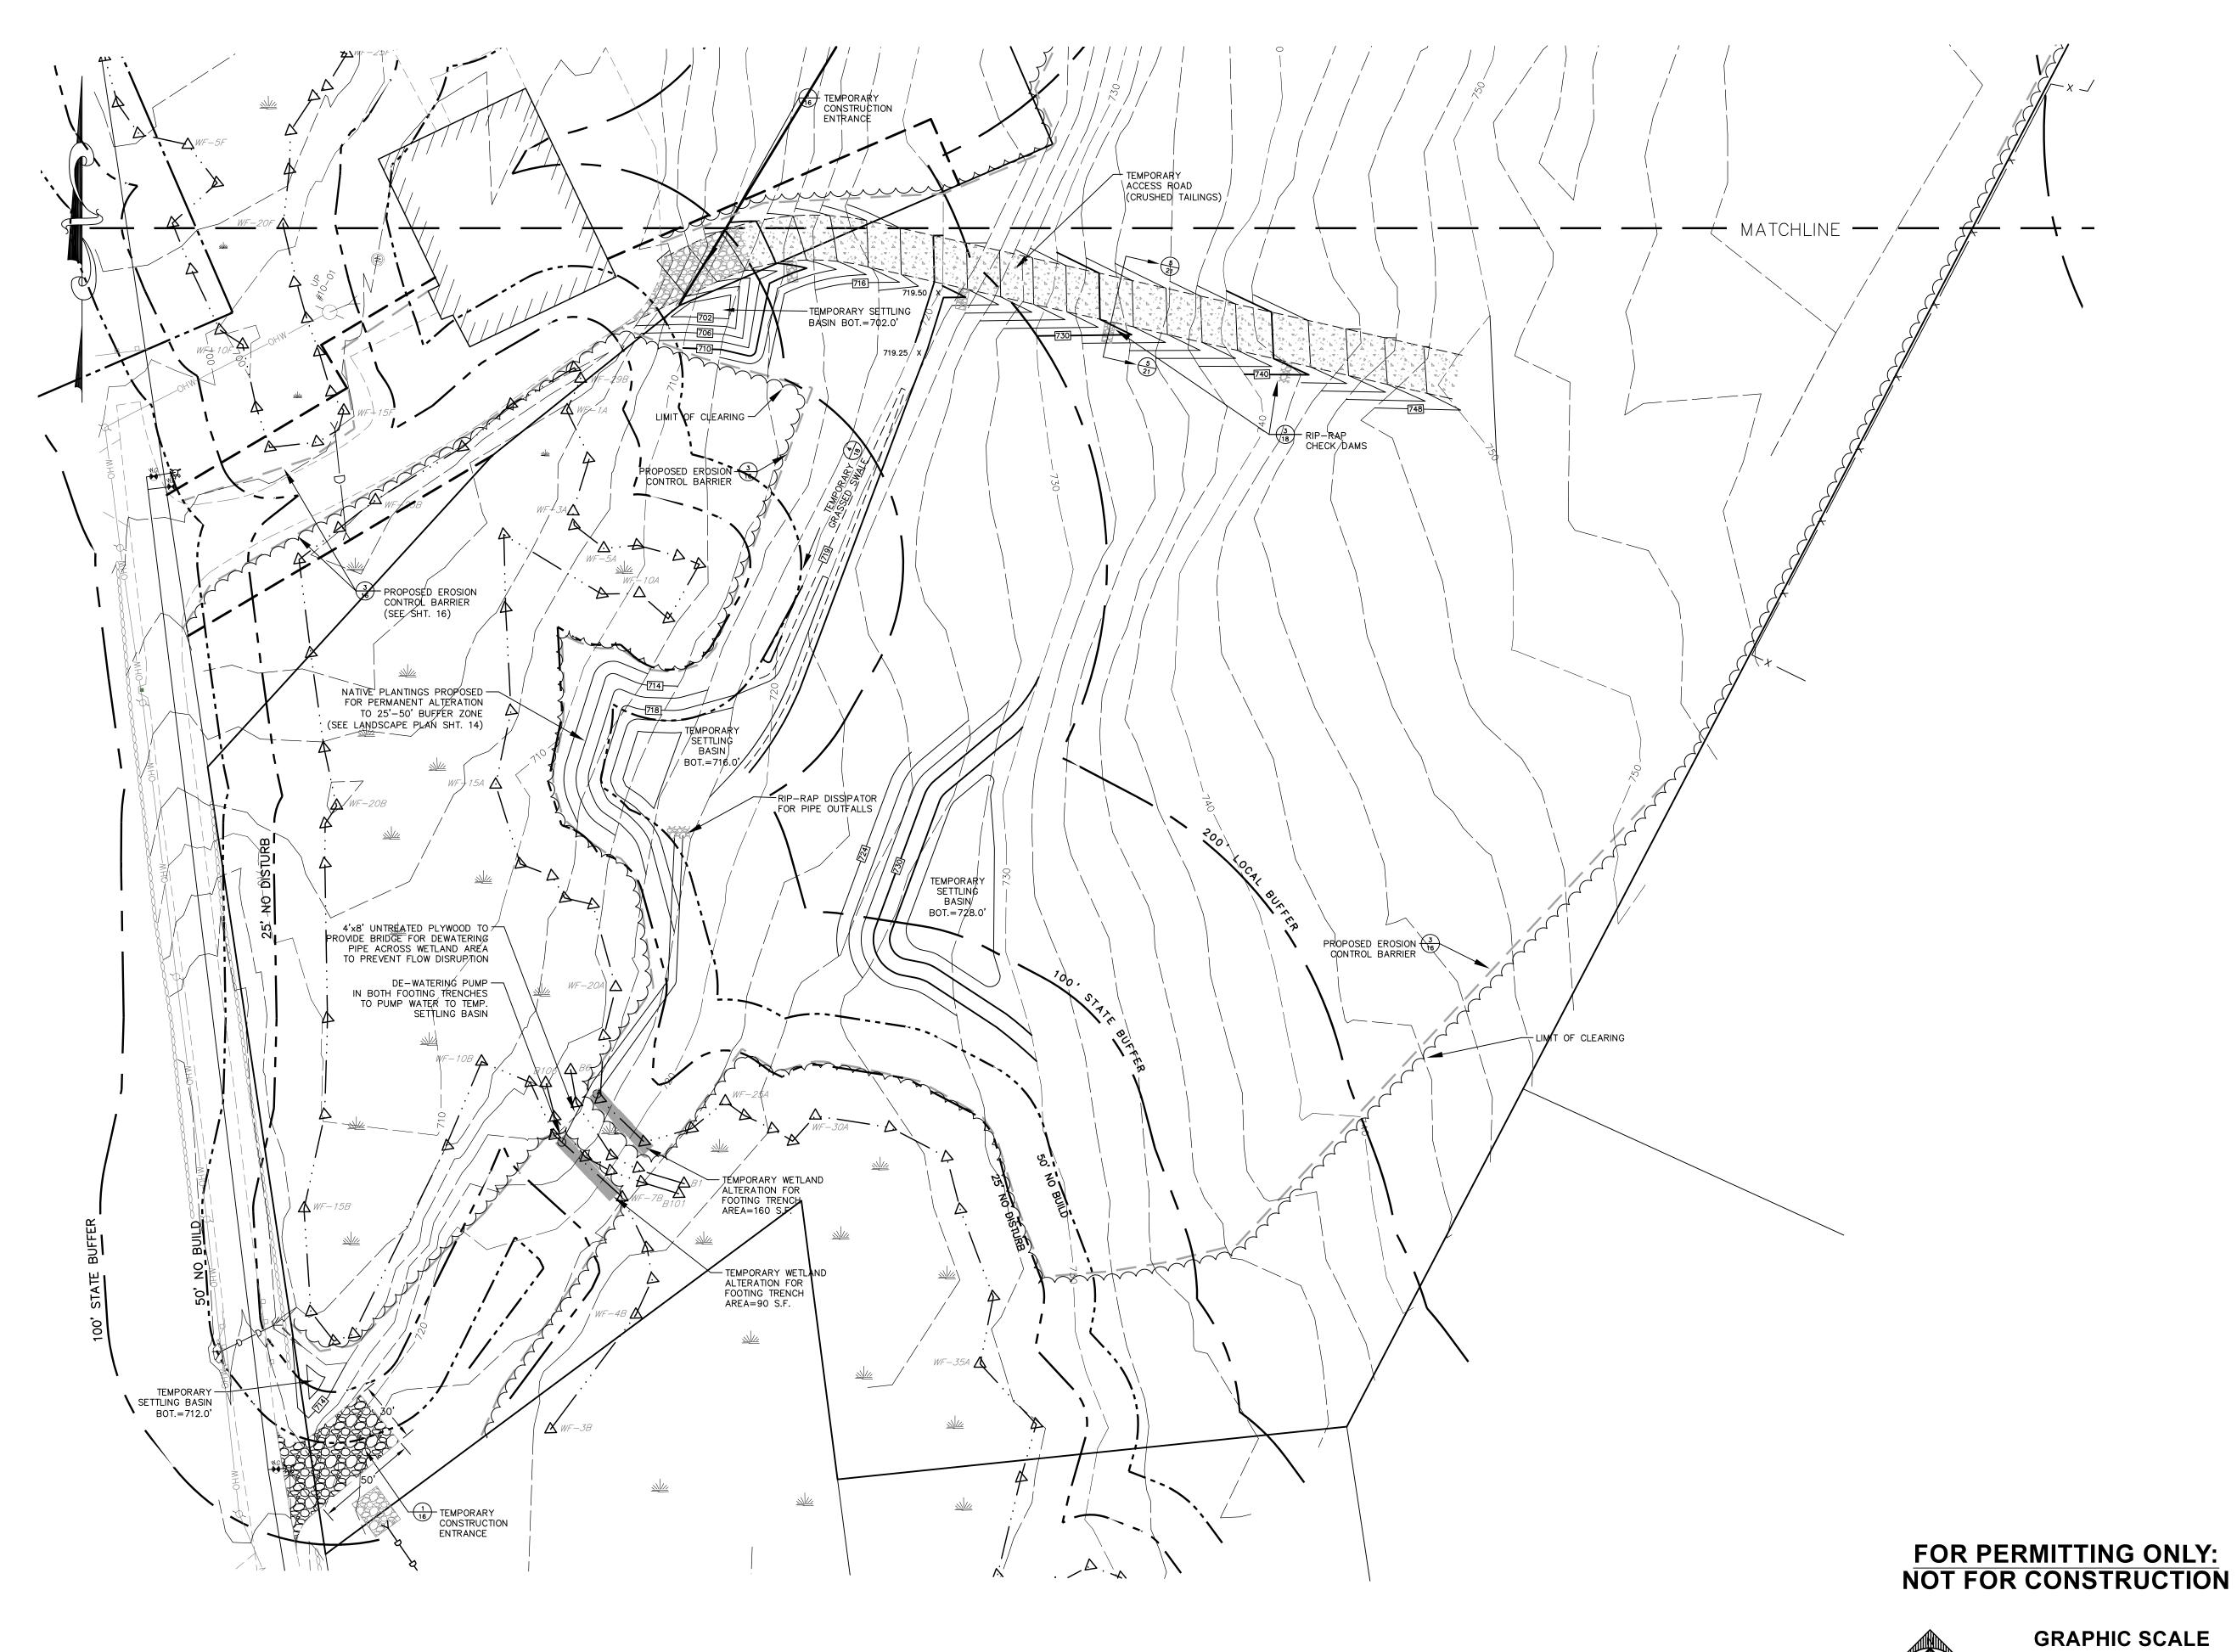










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NEW ENGLAND COLD STORAGE, LLC.

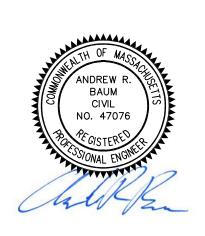6 PICKER ROAD STURBRIDGE, MA

EROSION & SEDIMENTATION CONTROL

6/1/20 - PER CONSERVATION COMMISSION COMMENTS

REVISIONS SCALE: 1" = 40'

MAY 12, 2020 20-122 JOB NO: 20-122 DEFINITIVE SITE PLAN PLAN NO:


OUTL	ET CONTROL STR	UCTURE SCHED	ULE OF ELEVATIONS	
DESCRIPTION	INVERT	DIAMETER	NOTES	
		BASIN A		
INVERT OUT	725.00	18	HDPE DISCHARGE	
	726.50	3	1 - VERTICAL ORIFACE	
	728.20	6	2 - VERTICAL ORIFACE	
	730.70	24	TOP STRUCTURE GRATE	
		BASIN B		
INVERT OUT	715.00	12	HDPE DISCHARGE	
	716.50	3	1 - VERTICAL ORIFACE	
	717.00	4	2 - VERTICAL ORIFACE	
	718.50	24	TOP STRUCTURE GRATE	

DRA	INAGE SCHEDUI	LE OF ELEVATIO	NS	_
STRUCTURE	RIM	INVERT	PIPE DIA. (INCHES)	NOTES
	САТСНВ	ASINS		
DBL CTB A, TRUCK COURT	744.00	740.00	18	DOUBLE CATCH BASIN
DBL CTB B, STA 11+47, 6.5' RT.	744.00	740.00	18	DOUBLE CATCH BASIN
CTB C, STA 6+75, 10' LT	741.49	737.49	12	
CTB D, STA 6+65, 39' RT	741.93	737.93	12	
CTB E, STA 5+58, 15' RT	734.68	730.68	12	
CTB F, STA 3+32.1, 15' RT	722.50	719.00	12	
TB F, STA 3+32.1, 15' LT	722.50	719.00	12	
TB H, STA 0+19, 15' RT	718.00	714.50	12	
CTB I, STA 15+40, 15' LT	718.53	715.03	12	
CTB J, PERIMETER ROAD	743.00	739.50	12	
	DRAIN MA	NHOLES		
MH-A STA, 11+28, 33' RT	745.80	737.00	18	FROM DBL CTB A.
	-	739.36	18	FROM DBL CTB STA 11+47
	-	735.00	24	TO DMH STA
NALLD CTA 44 . 20 40 DT	746.00	724.02	24	EDOM DAMI A
OMH B, STA 11+28, 19' RT	746.00	734.83	24	FROM DMH A
	-	734.73	24	ТО DMH C
OMH C, STA 6+65, 4' LT	740.91	736.94	12	FROM CTB C
	-	736.64	12	FROM CTB D
	-	731.00	24	FROM DMH B
	-	730.90	24	TO BASIN A OUTFALL
DMU 1 STORMCERTOR AEOL STA 2 · 42	722.00	710 05	12	EDOM CTP F
DMH-1, STORMCEPTOR 450I, STA 3+42	723.00	718.85	12	FROM CTB F
	-	718.85	12	FROM CTB F
	-	718.60	12	TO BASIN B OUTFALL
DMH-2, STORMCEPTOR 450I, STA 0+37, 27' LT	718.00	714.07	12	FROM CTB H
	-	714.07	12	FROM CTB I
	-	713.82	12	TO PICKER ROAD OUTFALL



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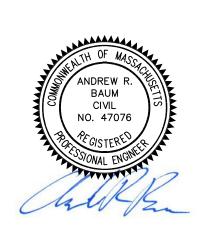
ARCO DESIGN/BUILD

380 Interstate North Pkwy. SE, Atlanta, GA 30339 Suite 210 770.541.1700

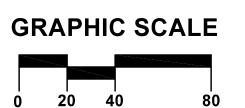



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NEW ENGLAND COLD STORAGE, LLC.

> 6 PICKER ROAD STURBRIDGE, MA

GRADING & DRAINAGE

6/1/20 - PER CONSERVATION COMMISSION COMMENTS

REVISIONS

SCALE: 1" = 40'

DATE: MAY 12, 2020

JOB NO: 20-122
PLAN NO: 20-122 DEFINITIVE SITE PLAN
SHEET NO: 8 OF 19











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NEW ENGLAND COLD STORAGE, LLC.

> 6 PICKER ROAD STURBRIDGE, MA

GRADING & DRAINAGE

6/1/20 - PER CONSERVATION COMMISSION COMMENTS
REVISIONS

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DATE: MAY 12, 2020

JOB NO: 20-122

PLAN NO: 20-122 DEFINITIVE SITE PLAN

SHEET NO: 9 OF 19



— 1.5" SURFACE COURSE



1.5" MASSDOT M3.11.03 TOP COURSE




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NEW ENGLAND COLD STORAGE, LLC.

6 PICKER ROAD STURBRIDGE, MA

PAVING PLAN


6/1/20 - PER CONSERVATION COMMISSION COMMENTS REVISIONS

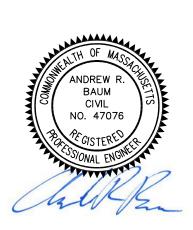
SCALE:

SHEET NO:

MAY 12, 2020 20-122 JOB NO: 20-122 DEFINITIVE SITE PLAN PLAN NO:

10 OF 19

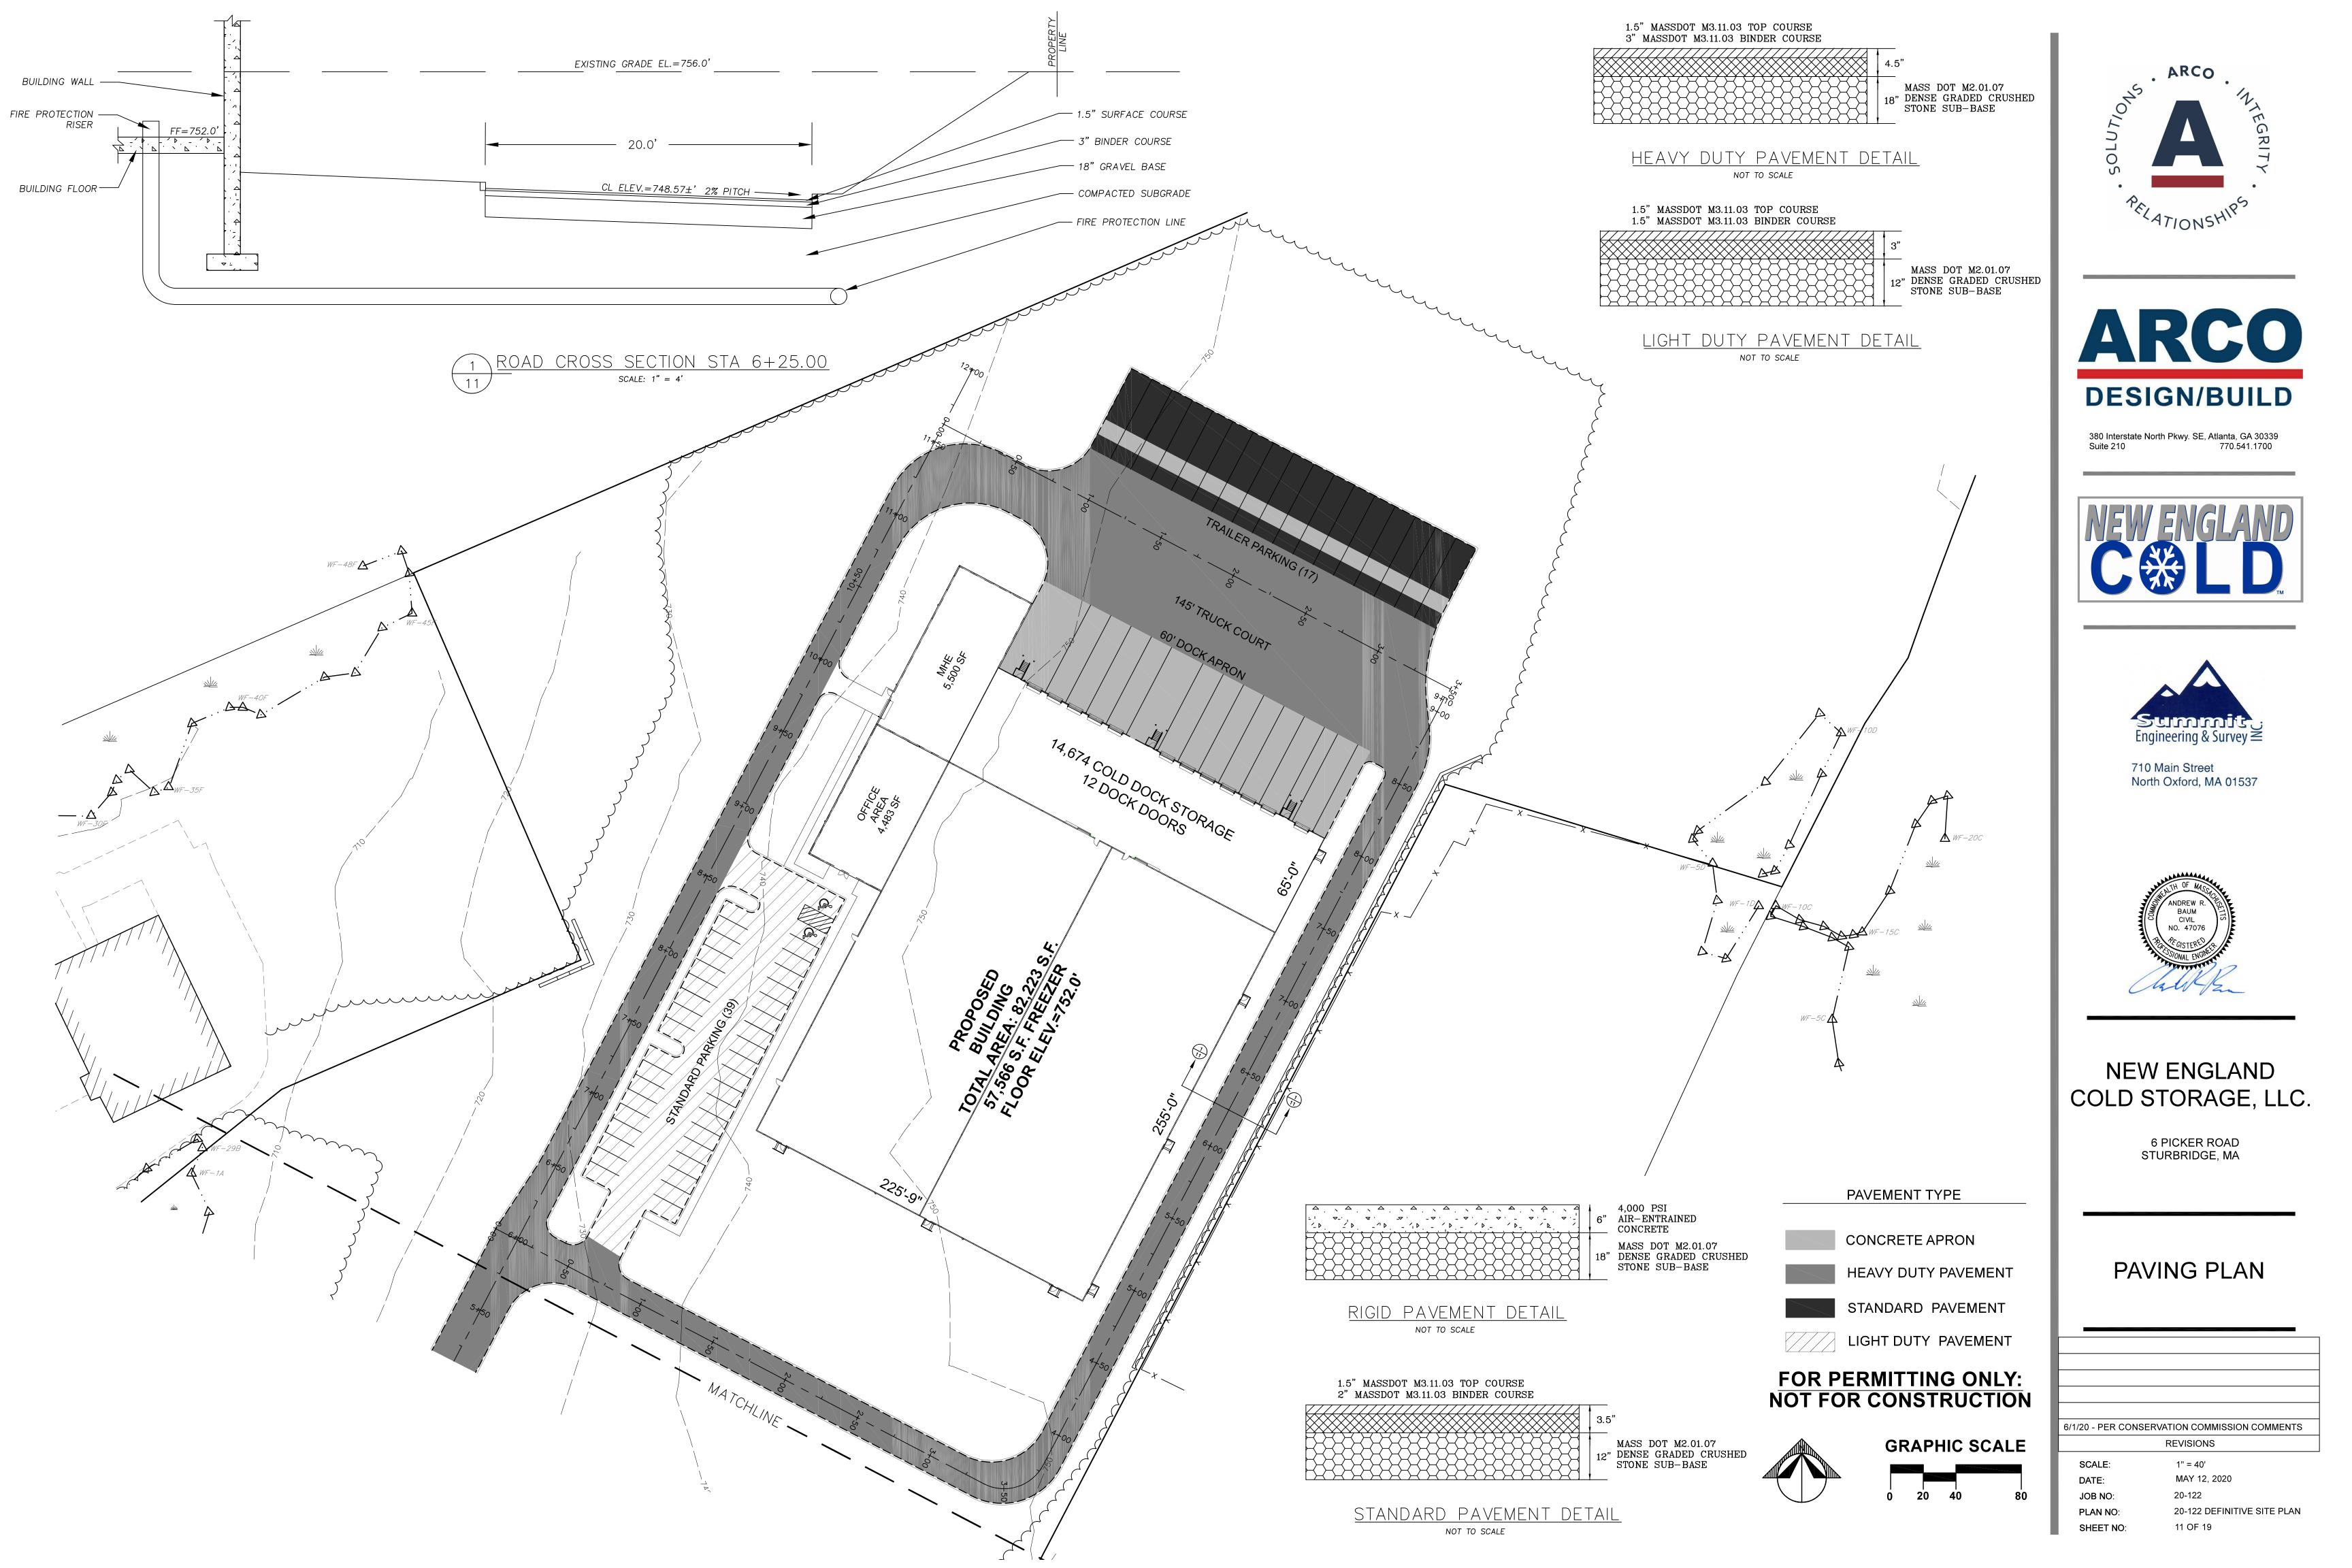

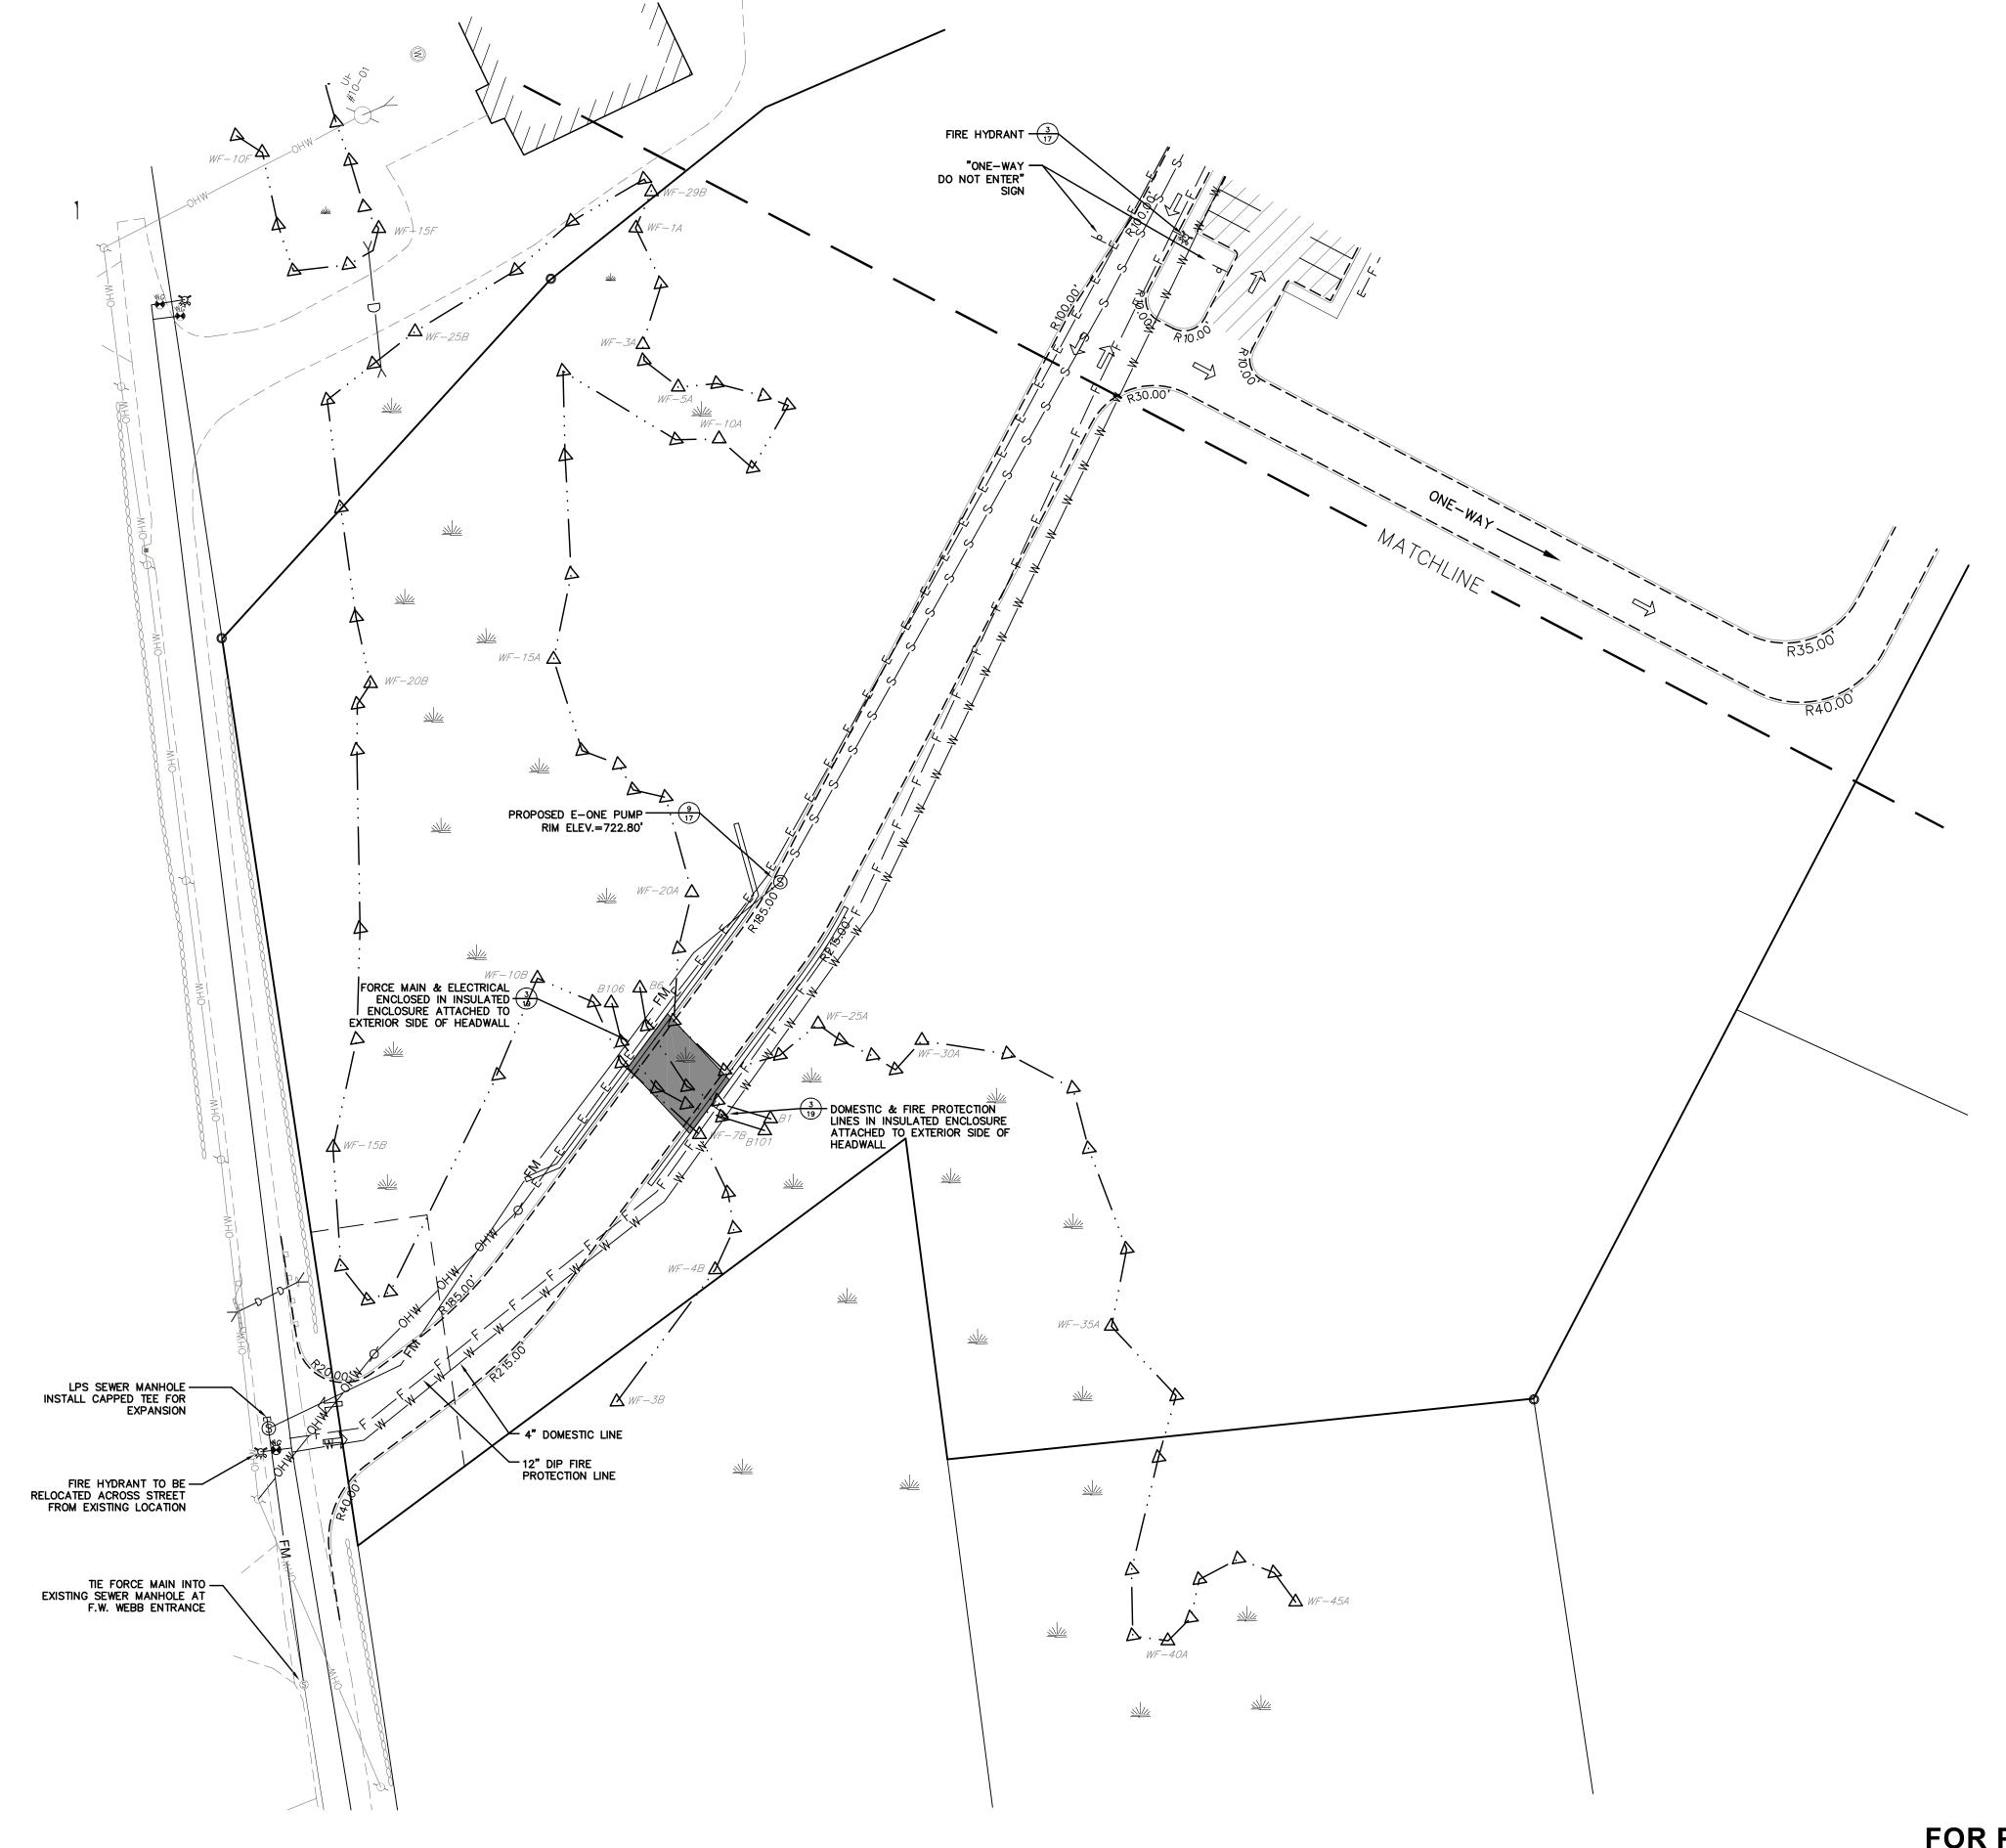










710 Main Street North Oxford, MA 01537

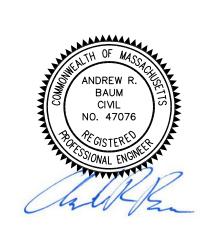

NEW ENGLAND COLD STORAGE, LLC.

6 PICKER ROAD STURBRIDGE, MA

LAYOUT & UTILITIES

6/1/20 - PER CONSERVATION COMMISSION COMMENTS

REVISIONS

12 OF 19

 SCALE:
 1" = 40'


 DATE:
 MAY 12, 2020


 JOB NO:
 20-122

 PLAN NO:
 20-122 DEFINITIVE SITE PLAN

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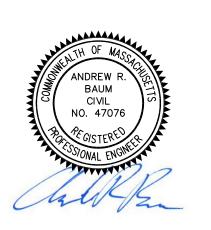




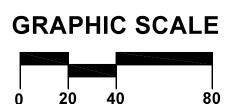

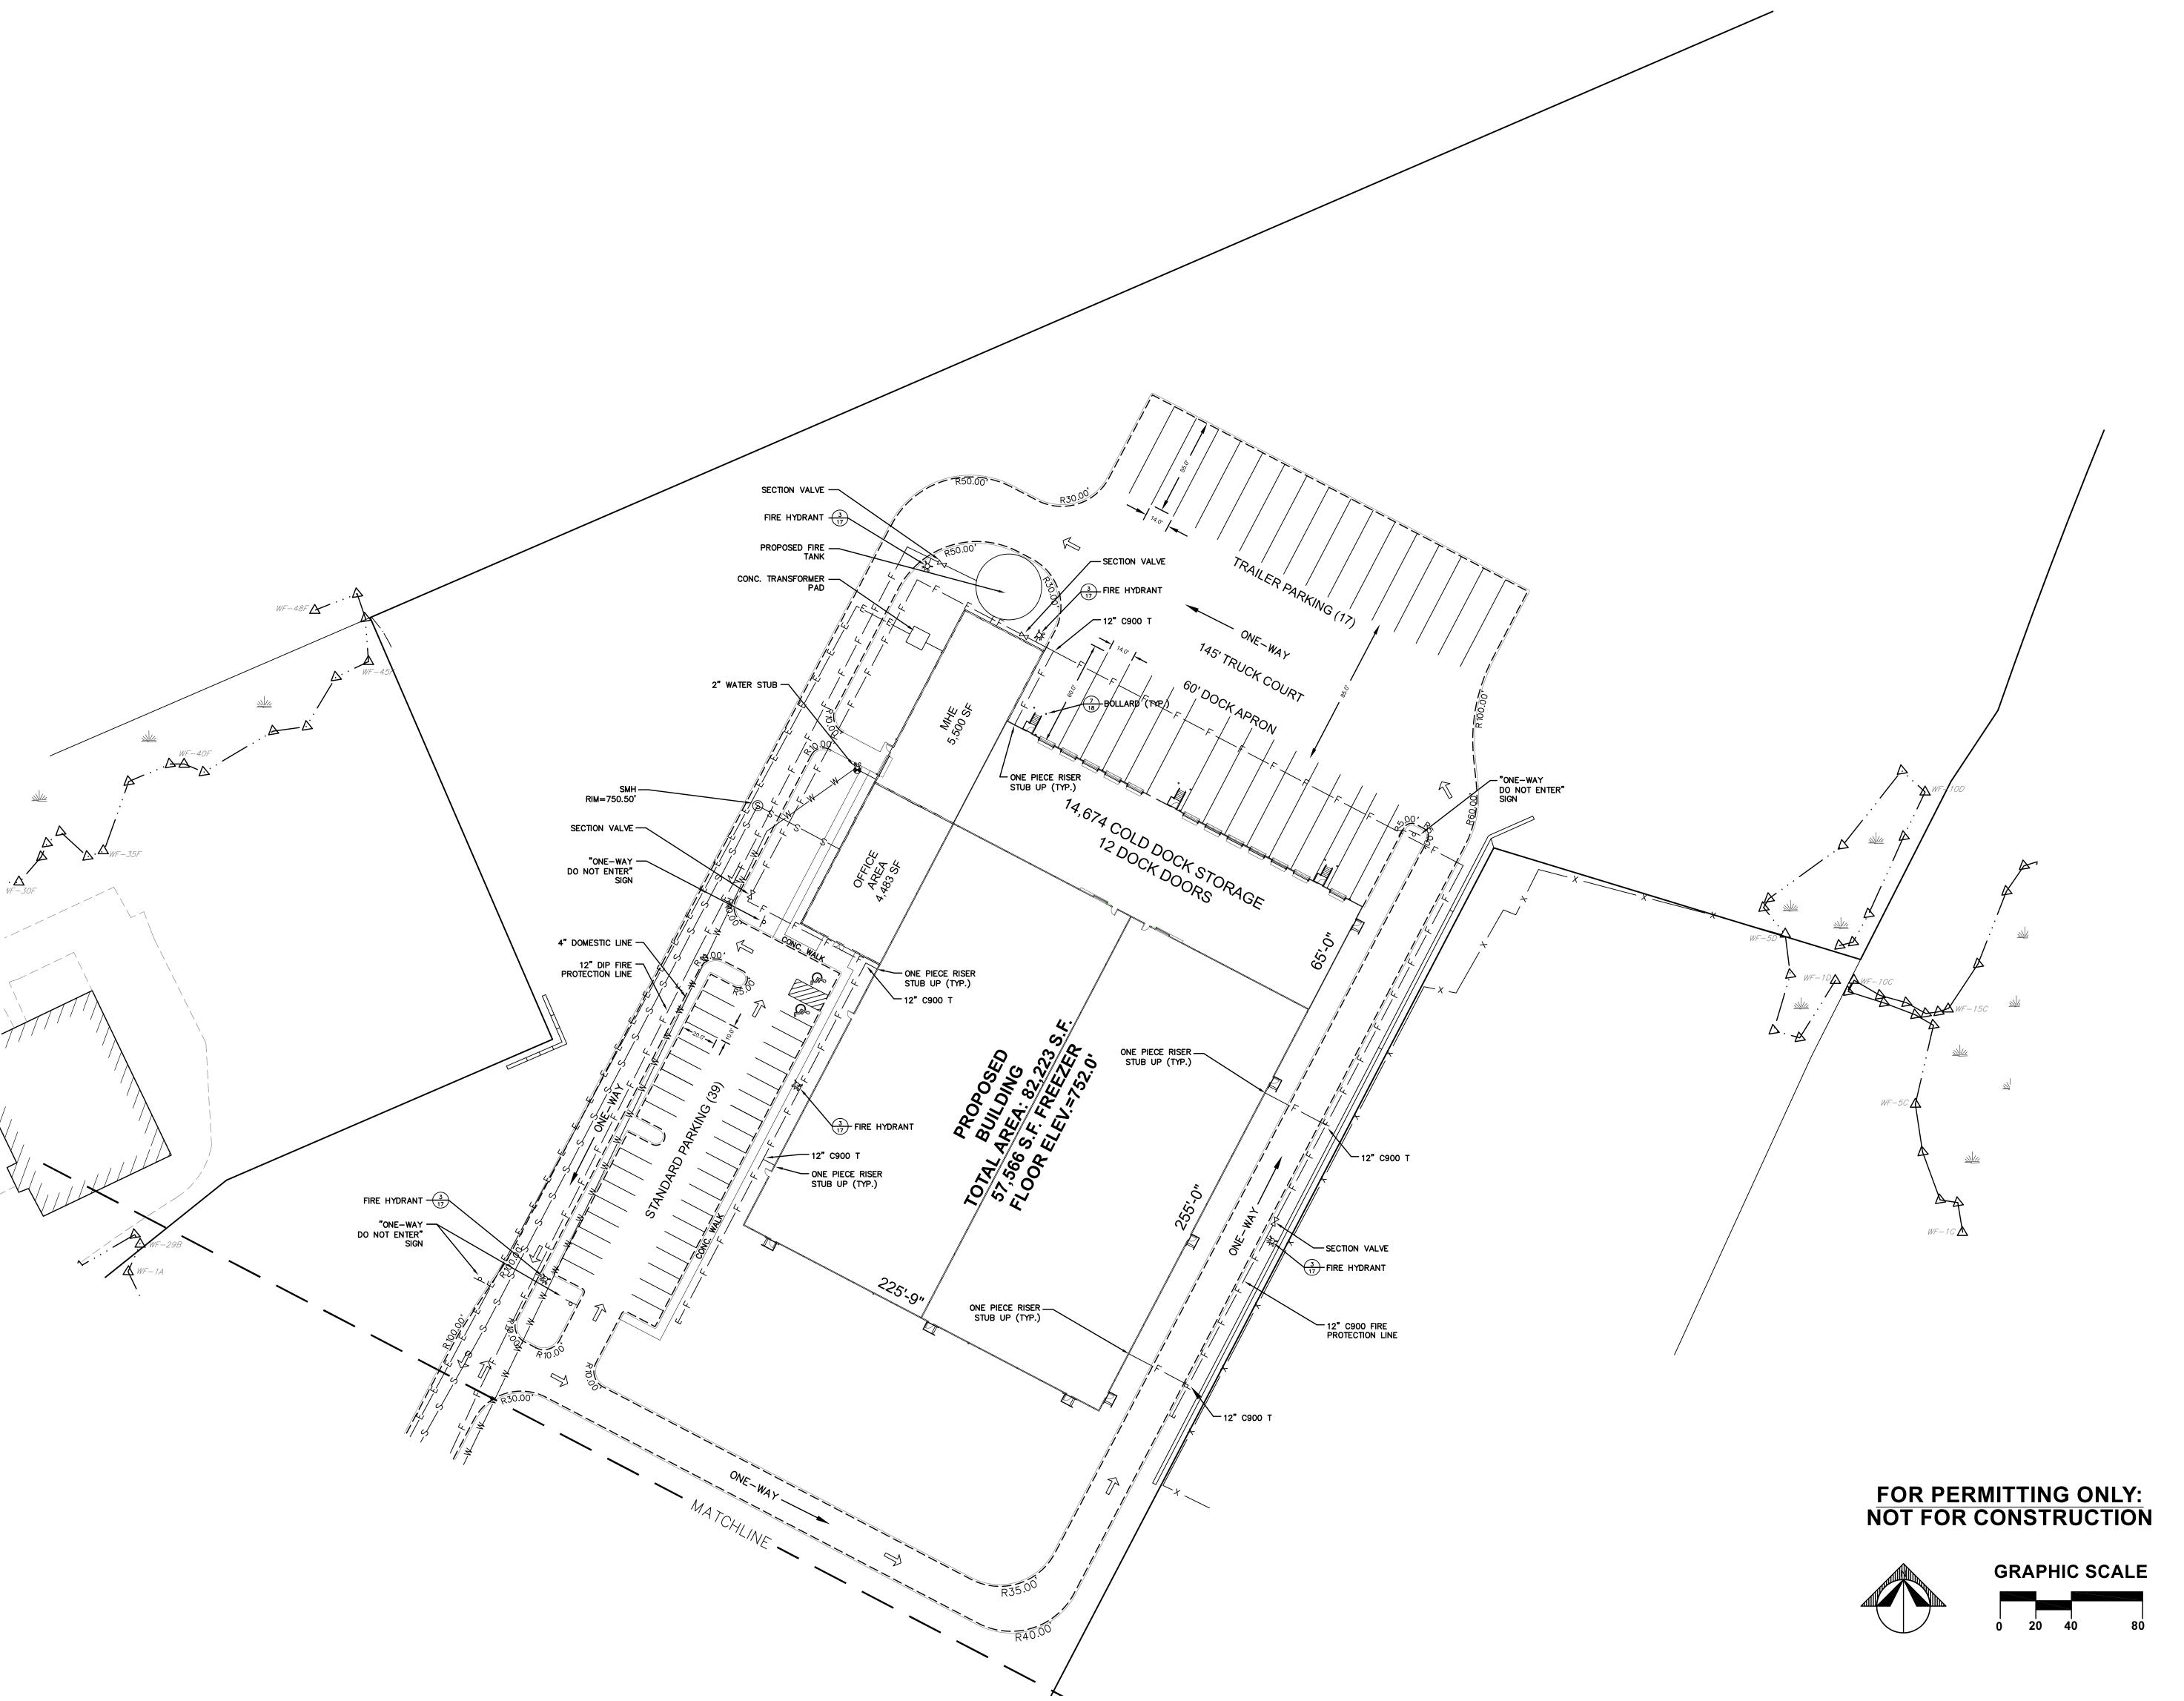

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6 PICKER ROAD STURBRIDGE, MA


LAYOUT & UTILITIES

6/1/20 - PER CONSERVATION COMMISSION COMMENTS

REVISIONS

SHEET NO:

SCALE: MAY 12, 2020 DATE: 20-122 JOB NO: 20-122 DEFINITIVE SITE PLAN PLAN NO: 13 OF 19

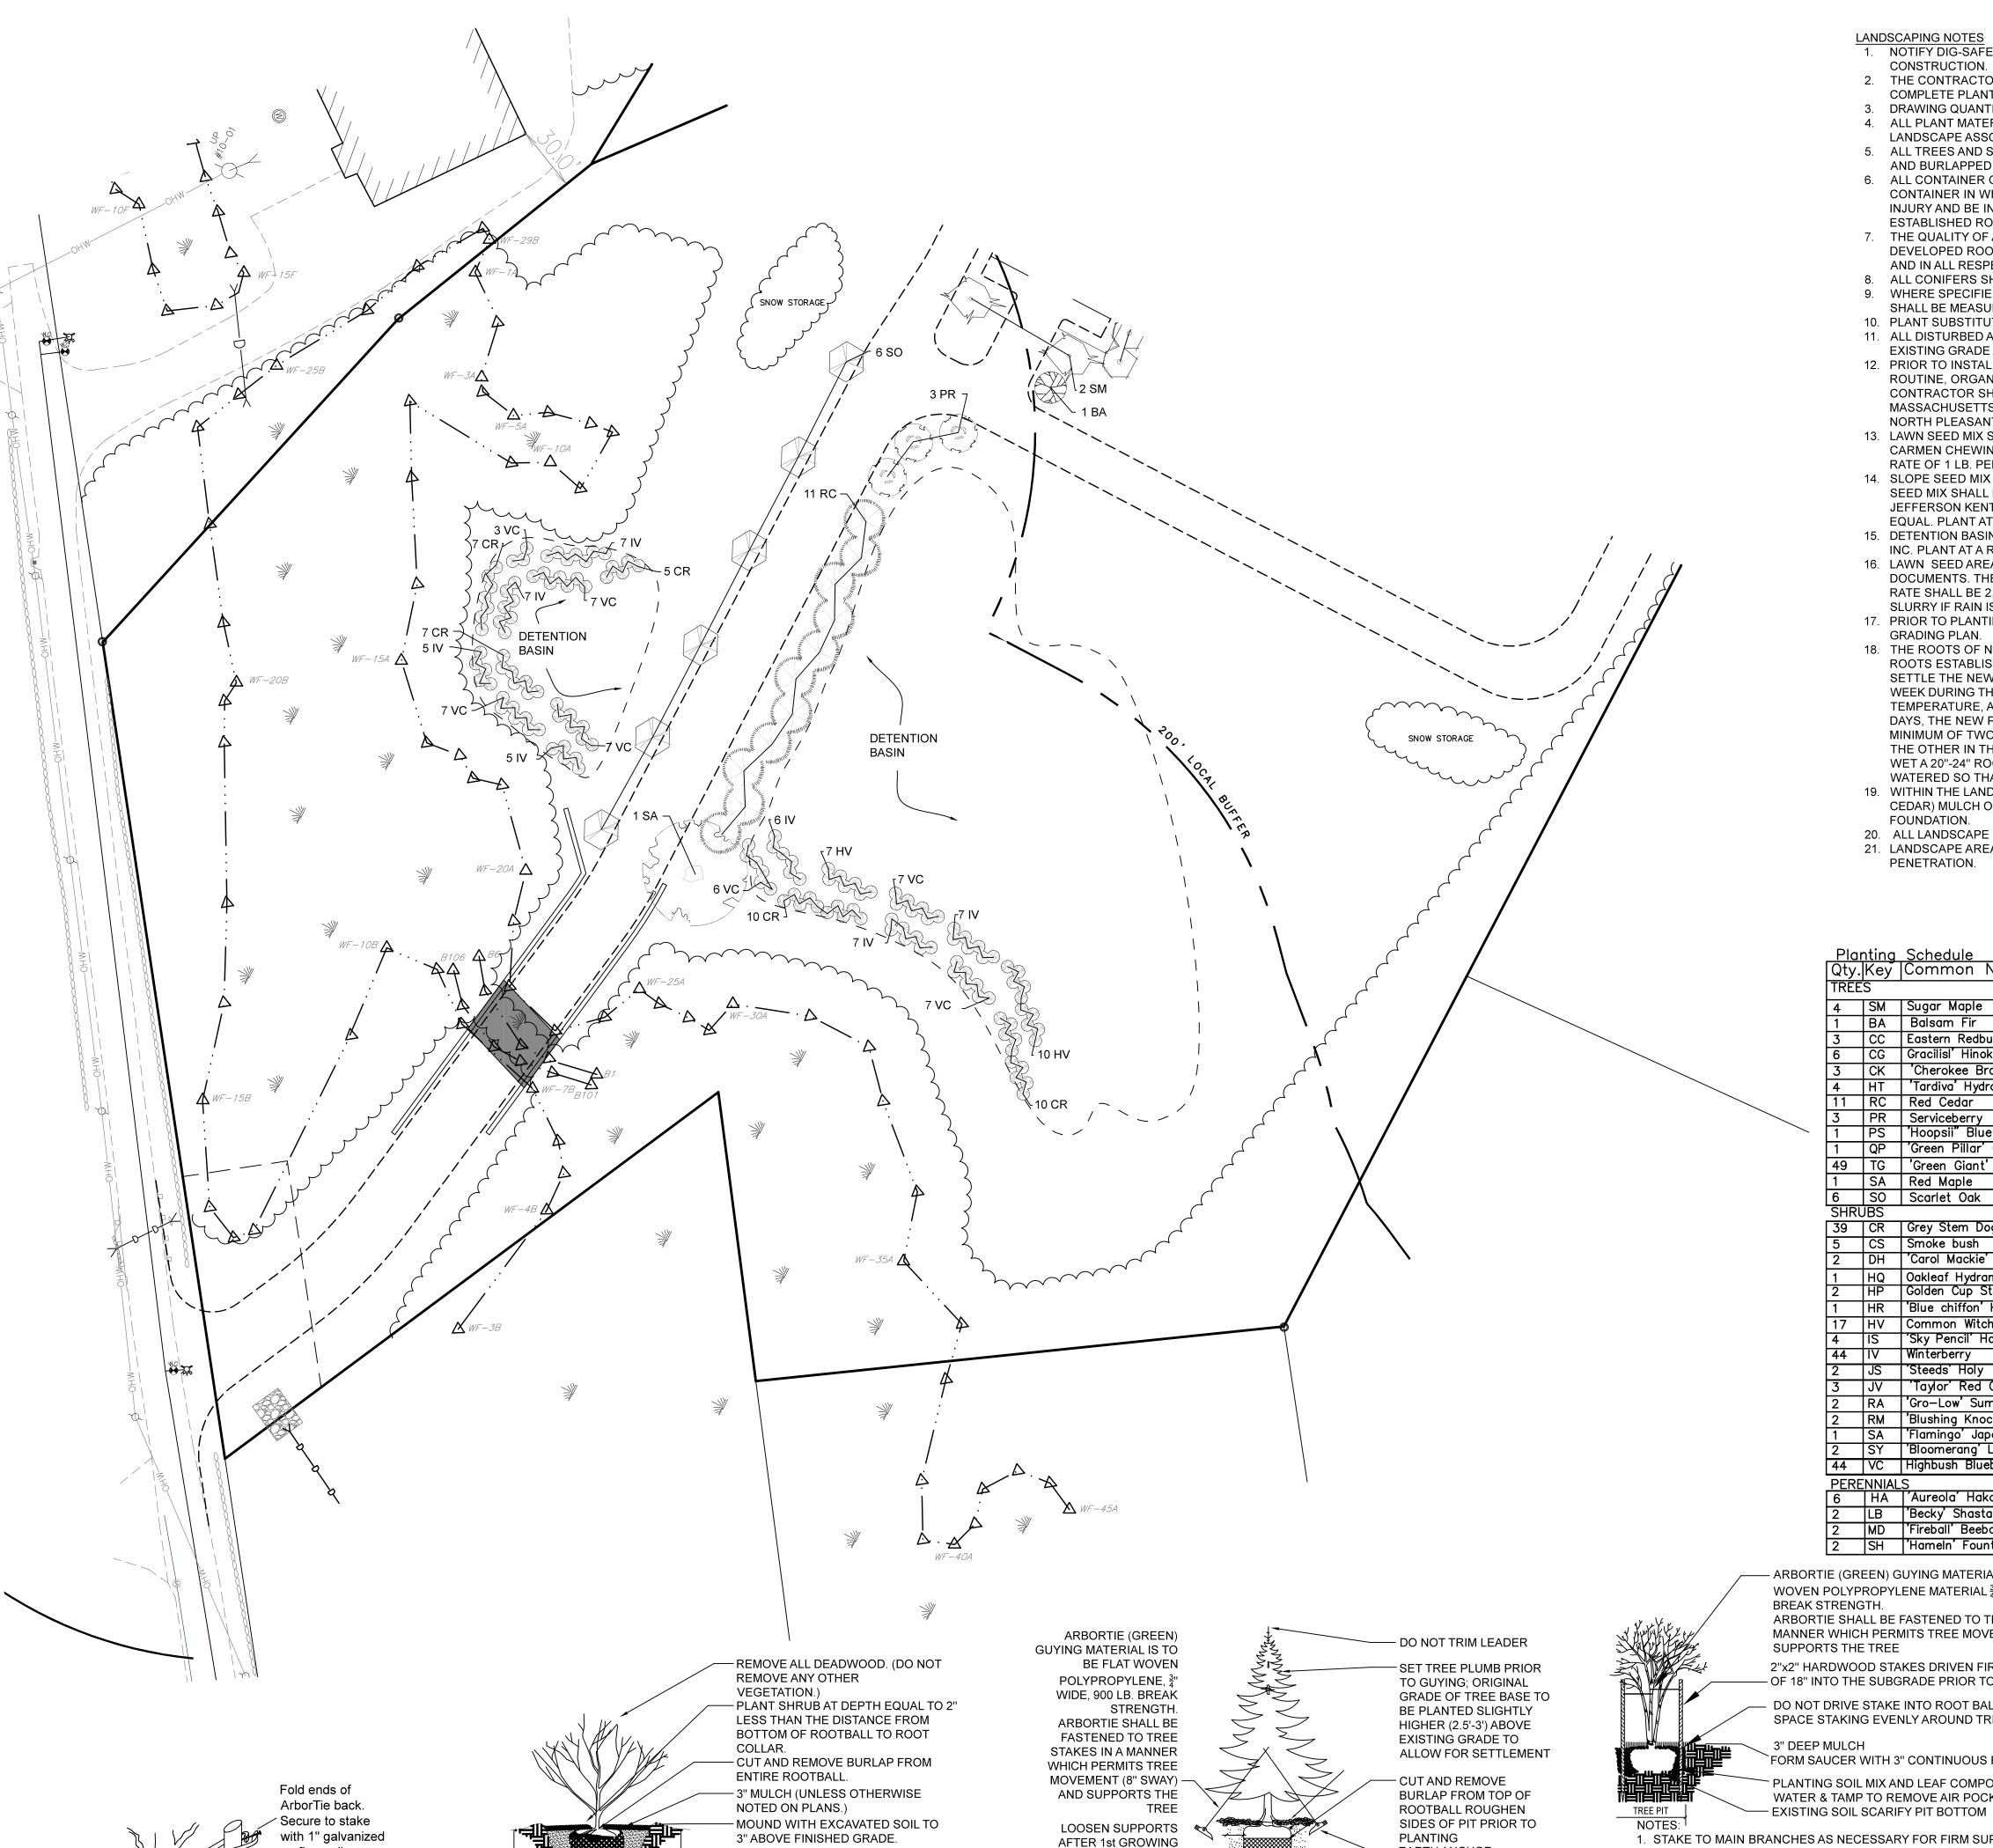

BACKFILL WITH PLANTING MIX AND

-ROOTBALL ON UNDISTURBED

LEAF COMPOST

SUBGRADE.

-3-5 x ROOTBALL

(NOT TO SCALE)

SHRUB PLANTING

NOT TO SCALE

DIA. (MIN.)

SEASON; REMOVE AFTER

2nd GROWING SEASON.

TREE PIT

3-5 x ROOTBALL

EVERGREEN TREE PLANTING

NOT TO SCALE

roofing nail or use

ArborTie

stake

nailed to 🦨

- NOTIFY DIG-SAFE AT 1-888-DIG-SAFE AND LOCAL AUTHORITIES PRIOR TO ANY TYPE OF SITE PREPARATION OR
- 2. THE CONTRACTOR SHALL SUPPLY ALL PLANT MATERIAL AND MULCH IN SUFFICIENT QUANTITIES TO
- COMPLETE PLANTING AS SHOWN ON THE DRAWINGS. 3. DRAWING QUANTITIES TAKE PRECEDENCE OVER PLANT LIST QUANTITIES.
- 4. ALL PLANT MATERIAL SHALL CONFORM TO THE GUIDELINES SET FORTH BY THE AMERICAN NURSERY &
- LANDSCAPE ASSOCIATION. 5. ALL TREES AND SHRUBS SHALL BE PLANTED WITH THE "BEST FACE" SHOWING. ALL PLANTS SHALL BE BALLED AND BURLAPPED OR CONTAINER GROWN, UNLESS OTHERWISE APPROVED BY THE LANDSCAPE ARCHITECT.
- 6. ALL CONTAINER GROWN STOCK SHALL BE HEALTHY, VIGOROUS, WELL ROOTED AND ESTABLISHED IN THE CONTAINER IN WHICH THEY ARE GROWING. THEY SHALL HAVE TOPS OF GOOD QUALITY, NO APPARENT INJURY AND BE IN A HEALTHY GROWING CONDITION. A CONTAINER GROWN PLANT SHALL HAVE A WELL ESTABLISHED ROOT SYSTEM REACHING THE SIDES OF THE CONTAINER TO MAINTAIN A FIRM BALL.
- 7. THE QUALITY OF ALL TREES & SHRUBS IS TO BE NORMAL FOR THE SPECIES. ALL PLANTS ARE TO HAVE DEVELOPED ROOT SYSTEMS, TO BE FREE OF INSECTS AND DISEASES AS WELL AS MECHANICAL INJURIES, AND IN ALL RESPECTS BE SUITABLE FOR PLANTINGS.
- 8. ALL CONIFERS SHALL HAVE DORMANT BUDS AND SECONDARY NEEDLES.
- 9. WHERE SPECIFIED, CALIPER SIZE IS TO BE THE OVERRIDING FACTOR IN TREE SELECTION. CALIPER SIZE SHALL BE MEASURED 12" ABOVE THE ROOTBALL.
- 10. PLANT SUBSTITUTIONS ARE NOT ALLOWED UNLESS APPROVED BY THE PROJECT LANDSCAPE ARCHITECT. 11. ALL DISTURBED AREAS NOT SHOWN OTHERWISE SHALL BE LOAMED AND SEEDED AND BLENDED INTO EXISTING GRADE AND CONDITIONS.
- 12. PRIOR TO INSTALLING ANY PLANT MATERIAL, THE CONTRACTOR SHALL SUBMIT A LOAM SOIL SAMPLE FOR A ROUTINE, ORGANIC, SALTS, AND NITRATE SOIL TEST. UPON THE RESULTS OF THIS TEST, THE SITE CONTRACTOR SHALL AMEND THE LOAM AS RECOMMENDED. SEND THE SOIL SAMPLE TO THE UNIVERSITY OF MASSACHUSETTS SOIL AND PLANT TISSUE TESTING LABORATORY, WEST EXPERIMENT STATION, 682
- NORTH PLEASANT ST., UNIVERSITY OF MASSACHUSETTS, AMHERST, MA 01003. 13. LAWN SEED MIX SHALL BE THE PREVIOUS YEARS CROP: 35% JEFFERSON KENTUCKY BLUEGRASS, 35% CARMEN CHEWING FESCUE AND 30% STALLION PERENNIAL RYEGRASS, OR APPROVED EQUAL. PLANT AT A RATE OF 1 LB. PER 150 SQUARE FEET.
- 14. SLOPE SEED MIX SHALL BE THE PREVIOUS YEARS CROP. PLANT AT A RATE OF 1 LB. PER 150. SQUARE FEET. SEED MIX SHALL BE STALLION PERENNIAL RYE 10%, CREEPING RED FESCUE 50%, ANNUAL RYE GRASS 15%, JEFFERSON KENTUCKY BLUE GRASS 10%, RED TOP CLOVER 5%, AND LADINO CLOVER 5%, OR APPROVED EQUAL. PLANT AT A RATE OF 1 LB. PER 150SF.
- 15. DETENTION BASIN SEED MIX SHALL BE THE CONSERVATION SEED MIX FROM NEW ENGLAND WETLAND PLANT INC. PLANT AT A RATE OF ONE POUND PER 1750SF
- 16. LAWN SEED AREAS SHALL BE DEEMED ACCEPTABLE IN ACCORDANCE WITH THE CONSTRUCTION DOCUMENTS. THE HYDRO SEED SLURRY SHALL BE A WOOD BASED BONDED FIBER MATRIX. THE APPLICATION RATE SHALL BE 2,500-3,000LB. PER ACRE SPRAYED IN A LEAST TWO DIRECTIONS. DO NOT APPLY HYDRO SEED
- SLURRY IF RAIN IS EXPECTED WITHIN 12 HOURS, AND WHEN TEMPERATURES ARE BELOW 50 DEGREES. 17. PRIOR TO PLANTING, THE LANDSCAPER SHALL REVIEW AND COORDINATE WITH THE SITE UTILITY PLAN AND
- 18. THE ROOTS OF NEWLY PLANTED TREES AND SHRUBS MUST BE KEPT STEADILY MOIST, AS THE DEVELOPING ROOTS ESTABLISH IN THE NEW SOIL. AT PLANTING, WATER THOROUGHLY TO SOAK THE ROOTS AND TO SETTLE THE NEW SOIL AROUND THE ROOT BALL THE AMOUNT OF SUPPLEMENTAL WATER NEEDED EACH WEEK DURING THE FIRST GROWING SEASON AFTER PLANTING DEPENDS ON RECENT RAINFALL TEMPERATURE, AND WIND. IF LESS THAN ONE-INCH OF RAIN HAS FALLEN OVER THE PAST FIVE TO SEVEN DAYS, THE NEW PLANTINGS MUST BE WATERED. LAWNS, TREES, AND SHRUBS WATERING SHALL OCCUR AT A MINIMUM OF TWO (2) TIMES A DAY FOR THE FIRST TWO (2) MONTHS; ONCE IN THE EARLY MORNING AND THEN THE OTHER IN THE LATE AFTERNOON. IN GENERAL TEN GALLONS OF WATER APPLIED TWICE A WEEK WILL WET A 20"-24" ROOT BALL AND PROVIDE THE EQUIVALENT OF ONE INCH OF RAIN FALL. NEW LAWNS SHALL BE WATERED SO THAT IS RECEIVES AT A MINIMUM ONE INCH (1") OF WATER EVERY WEEK.
- 19. WITHIN THE LANDSCAPE BEDS ADJACENT TO THE BUILDING FOUNDATIONS, NO (HEMLOCK, PINE, SPRUCE, OR CEDAR) MULCH OR OTHER COMBUSTIBLE LANDSCAPE MATERIALS SHALL BE INSTALLED WITHIN 18" OF THE
- 20. ALL LANDSCAPE BEDS SHALL RECEIVE THREE-INCHES OF BARK MULCH.
- 21. LANDSCAPE AREAS SHALL BE DEEP TILLED TO A DEPTH OF TWELVE INCHES TO FACILITATE DEEP WATER

Qty.Key Common Name Botanical Name |Size | Remarks 4 SM Sugar Maple Acer saccharum 1 BA Balsam Fir Abies balsamea CC Eastern Redbu 6 CG Gracilisl' Hinoki Cypress 3" Cal. B&B Chamaecyparis obtusa 'Gracilis 3" Cal. B&B 3 CK 'Cherokee Brave' Dogwood Cornus florida 'Cherokee Brave' Hydrangea paniculata 'Tardiva' treeform 3" Cal. B&B

Juniperus Virginiana 8' Ht. B&B 4 HT 'Tardiva' Hydrangea 11 RC Red Cedar 3" Cal. B&B Singlestem 3 PR Serviceberry Amelanchier canadensis 1 PS 'Hoopsii' Blue Spruce 3' Ht. | B&B Picea pungens 'Hoopsii' 1 QP 'Green Pillar' Oak 3" Cal. B&B Quercus palustris 'Green Pillar' 49 TG 'Green Giant' Arborvitae Thuju x plicata 'Green Giant' 6' Ht. | B&B 3" Cal. B&B 1 SA Red Maple Acer rubrum 6 SO Scarlet Oak Quercus Coccinea 3" Cal. B&B 39 | CR | Grey Stem Dogwood 24" Ht. B&B Cornus racemosa 5 CS Smoke bush Cotinus coggygria 48" Ht. B&B 2 DH 'Carol Mackie' Daphne Daphne burkwoodii 'Carol Mackie' 1 HQ Oakleaf Hydrangea 2 HP Golden Cup St. John's Wort 24" Ht. B&B Hydrangea quercifolia Hypericum Hidcote 24" Ht. B&B 48" Ht. B&B 1 HR 'Blue chiffon' Hibiscus Hibiscus syriacus 'Rose Satin' 36" Ht. B&B 17 HV Common Witch Hazel Hamamelis virginiana 4 IS 'Sky Pencil' Holly llex crenata 'Skv Pencil' 24" Ht. B&B 44 IV Winterberry llex vertillata 24" Ht. B&B 2 JS 'Steeds' Holy llex crenata 'Steeds' 24" Ht. B&B 3 JV 'Taylor' Red Cedar 48" Ht. B&B Juniperus virginiana 'Taylor' 2 RA 'Gro-Low' Sumac 24" Ht. B&B Rhus aromatica 'Gro-Low' 2 RM 'Blushing Knock out' Rose 1 SA 'Flamingo' Japanese Willow 24" Ht. B&B Rosa sp. 'Blushing Knock Out' 24" Ht. B&B Salix integra 'Flamingo' SY 'Bloomerang' Lilac 36" Ht. B&B Syringa x Bloomerang 44 VC Highbush Blueberry 36" Ht. B&B Vaccinium corymbosum PERENNIALS
6 | HA | 'Aureola' Hakone Grass #3 Pot Container Grown #3 Pot Container Grown Hakonechloa macra 'Aureola' LB 'Becky' Shasta Daisy Leucanthemum x superbum 'Becky' #3 Pot Container Grown MD ('Fireball' Beebalm Monarda didyma 'Fireball' SH 'Hameln' Fountain Grass #3 Pot Container Grown Pennisetum alopecuroides 'Hameln'

- ARBORTIE (GREEN) GUYING MATERIAL IS TO BE FLAT WOVEN POLYPROPYLENE MATERIAL 3" WIDE, 900 LB. BREAK STRENGTH. ARBORTIE SHALL BE FASTENED TO TREE STAKES IN A MANNER WHICH PERMITS TREE MOVEMENT (8" SWAY) AND

2"x2" HARDWOOD STAKES DRIVEN FIRMLY A MINIMUM - OF 18" INTO THE SUBGRADE PRIOR TO BACKFILLING.

DO NOT DRIVE STAKE INTO ROOT BALL. SPACE STAKING EVENLY AROUND TREE

FORM SAUCER WITH 3" CONTINUOUS RIM.

PLANTING SOIL MIX AND LEAF COMPOST WATER & TAMP TO REMOVE AIR POCKETS

1. STAKE TO MAIN BRANCHES AS NECESSARY FOR FIRM SUPPORT. 2. PLANT SO THAT TOP OF ROOT BALL IS EVEN WITH THE FINISHED

3. GUY WIRE SHALL NOT TOUCH OR RUB ADJACENT TRUNKS OR 4. REMOVE ALL CONTAINERS AND BASKETS FROM ROOT BALL.

<u>DECIDUOUS TREE PLANTING</u>

5. REMOVE BURLAP FROM TOP ONE THIRD OF ROOT BALL.

6. LOOSEN ROOTBALL PRIOR TO PLANTING.

- EARTH ANCHOR

6" HIGH MOUND OF

TOPSOIL COMPACTED

NOTE: SET CROWN OF

ROOTBALL 1-2" ABOVE

GRAPHIC SCALE

FOR PERMITTING ONLY:

NOT FOR CONSTRUCTION





380 Interstate North Pkwy. SE, Atlanta, GA 30339





710 Main Street North Oxford, MA 01537

NEW ENGLAND COLD STORAGE, LLC.

> 6 PICKER ROAD STURBRIDGE, MA


LANDSCAPE

6/1/20 - PER CONSERVATION COMMISSION COMMENTS

REVISIONS SCALE: 1" = 40' MAY 12, 2020 DATE: 20-122 JOB NO:

20-122 DEFINITIVE SITE PLAN PLAN NO: 14 OF 18 SHEET NO:

NOT TO SCALE

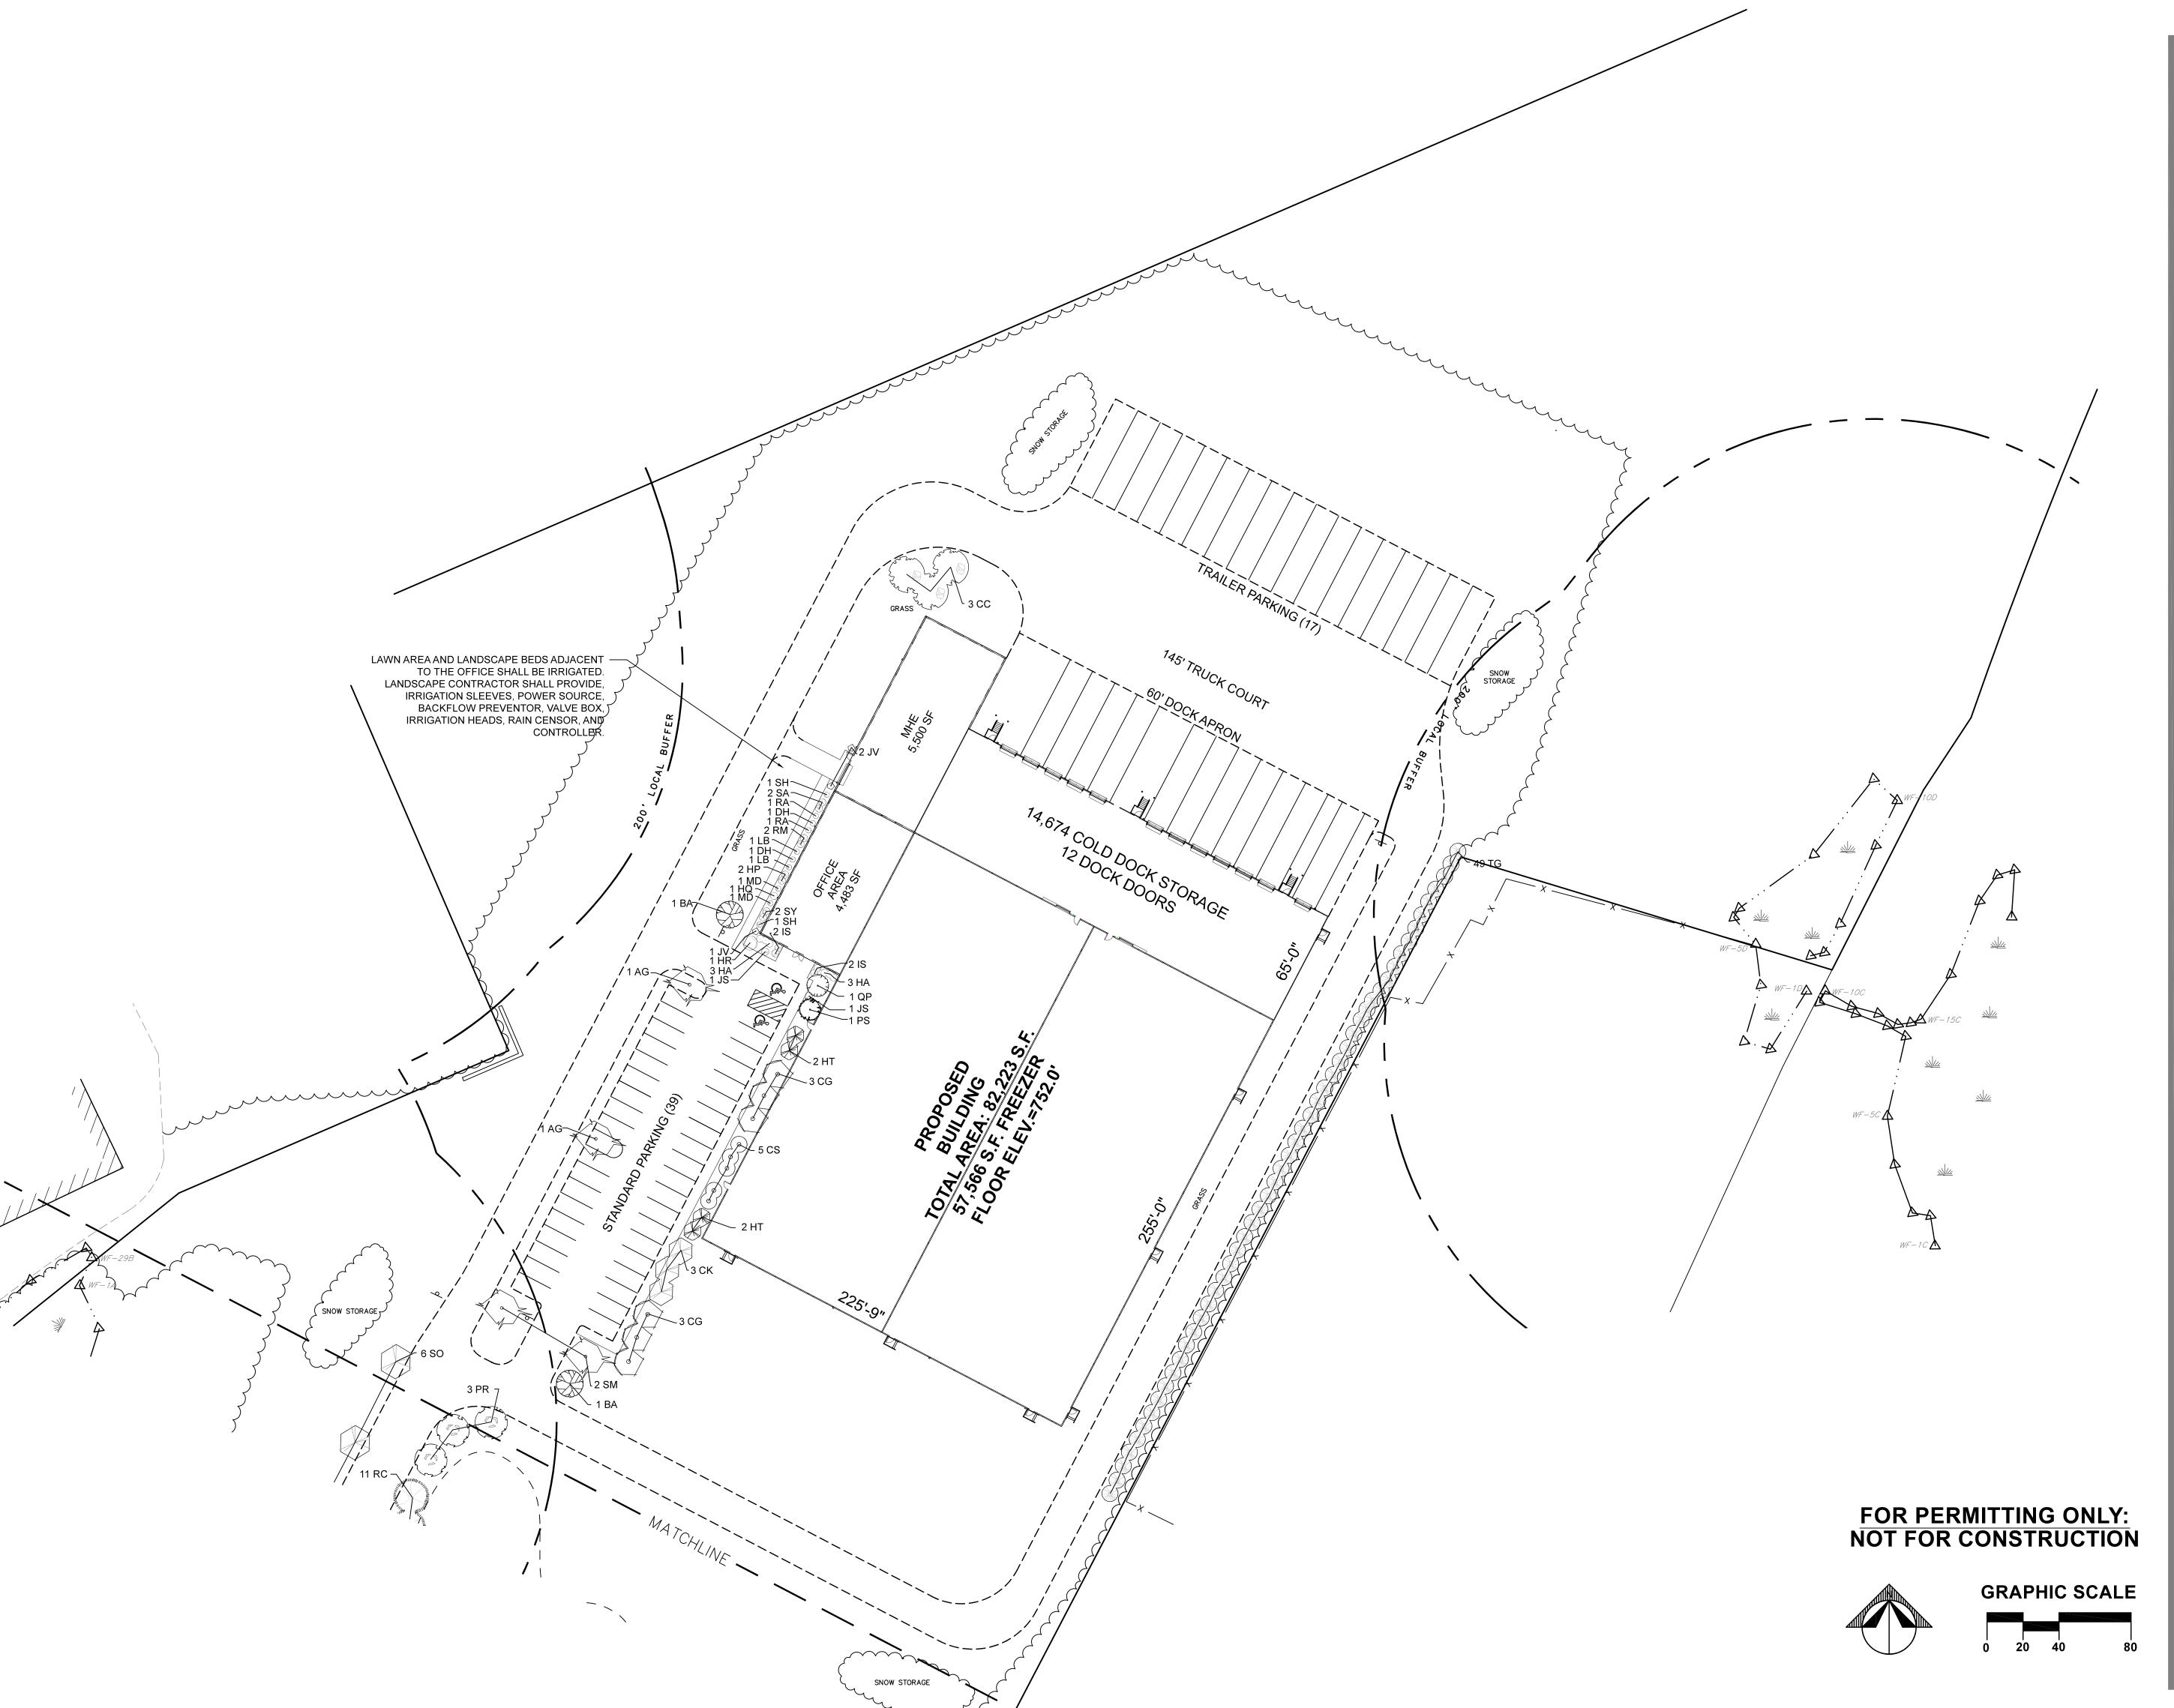









710 Main Street North Oxford, MA 01537

NEW ENGLAND COLD STORAGE, LLC.

> 6 PICKER ROAD STURBRIDGE, MA

LANDSCAPE

6/1/20 - PER CONSERVATION COMMISSION COMMENTS
REVISIONS

SCALE: 1" = 40'

DATE: MAY 12, 2

JOB NO: 20-122

PLAN NO: 20-122 DE

SHEET NO:

MAY 12, 2020 20-122 20-122 DEFINITIVE SITE PLAN 15 OF 18

PRELIMINARY SITE WORK:

1. MATERIAL REMOVED SHOULD BE STOCKPILED, SEPARATING THE TOPSOIL FOR FUTURE USE ON THE SITE. EROSION CONTROLS SHALL BE UTILIZED ALONG THE DOWNSLOPE SIDE OF THE PILES IF THE PILES ARE TO REMAIN MORE THAN THREE WEEKS OR SUBJECT TO EROSIVE CONDITIONS SUCH AS INTENSE RAIN. WIND OR OTHER EXPOSURE.

2. STOCKPILES SHALL BE LOCATED AS SPECIFIED HEREIN AND AS REQUIRED. SHOULD ADDITIONAL AREAS BE NEEDED THEY SHALL BE LOCATED WITHIN THE LIMITS OF DISTURBANCE, IN AREAS OF MINIMAL IMPACT. IF A STOCKPILE IS LOCATED ON A SLOPE, THE RUNOFF SHALL BE DIRECTED AWAY FROM THE PILE.

3. IF INTENSE RAINFALL IS ANTICIPATED, THE INSTALLATION OF SUPPLEMENTAL HAYBALE DIKES, SILT FENCES, OR ARMORED DIKES SHALL BE UTILIZED.

4. IF THE SITE CONSTRUCTION OCCURS AT ANY TIME OTHER THAN THE MAY —
NOVEMBER CONSTRUCTION SEASON, THE SITE DRAINAGE SYSTEM SHALL BE INSTALLED,
MAINTAINING HYDRAULIC CAPACITY, PRIOR TO ANY ROUGH GRADING IN THE BUFFER

INSTALLATION OF UTILITIES:

1. CARE SHALL BE TAKEN TO ASSURE THAT THE UTILITY TRENCHES DO NOT CHANNELIZE RUNOFF TOWARDS EXISTING STREETS OR OTHER OFF—SITE AREAS.

2. THE INSTALLATION OF SUBSURFACE UTILITIES AND APPURTENANCES SHALL BE IN ACCORDANCE WITH THE APPLICABLE UTILITY COMPANY SPECIFICATIONS.

3. TRENCH EXCAVATIONS SHALL BE LIMITED TO THE MINIMUM LENGTH REQUIRED FOR DAILY UTILITY INSTALLATION. ALL TRENCHES SHALL BE BACKFILLED AS SOON AS

LANDSCAPING:

1. LANDSCAPING SHALL OCCUR AS SOON AS POSSIBLE TO PROVIDE PERMANENT STABILIZATION OF DISTURBED SURFACES.

2. CONTRACTOR SHALL UTILIZE A VARIETY OF SLOPE STABILIZATION METHODS AND MATERIALS WHICH SHALL BE ADJUSTED TO THE SITE CONDITIONS. EROSION CONTROL BLANKETS OR MIRAFI MIRAMAT (OR SIMILAR PRODUCTS) SHALL BE AVAILABLE ON SITE.

3. IF THE SEASON OR ADVERSE WEATHER CONDITIONS DO NOT ALLOW THE

ESTABLISHMENT OF VEGETATION, TEMPORARY MULCHING WITH HAY, TACKIFIED WOOD CHIPS OR OTHER METHODS SHALL BE PROVIDED.

SPECIFIED GRADES.

5. SEED APPLICATIONS SHALL BE IN ACCORDANCE WITH THE GRASS AND SLOPE COVER

4. A MINIMUM OF 6" TOPSOIL SHALL BE PLACED AND ITS SURFACE SMOOTHED TO THE

PRE-CONSTRUCTION:

SPECIFICATIONS.

1. AN EROSION CONTROL BARRIER (SEE SHEET 4) SHALL BE INSTALLED AS DEPICTED ON THE SITE PLAN, BETWEEN THE AREAS TO BE DISTURBED AND WETLAND AREAS. THIS BARRIER SHALL REMAIN IN PLACE UNTIL ALL TRIBUTARY SURFACES HAVE BEEN FULLY STABILIZED. THE EROSION CONTROL BARRIERS AS SHOWN ON THE SITE PLAN ARE THE MINIMUM REQUIRED TO PROTECT THE ON & OFF SITE DRAINAGE SYSTEMS.

2. PHOTOGRAPHS AND/OR VIDEO IMAGES OF THE PRE—CONSTRUCTION CONDITION OF THE SITE AND SURROUNDING AREAS, ESPECIALLY THE ADJACENT STREETS SHALL BE TAKEN, DEVELOPED AND DATED. A COPY OF THESE MATERIALS SHALL BE SUBMITTED TO THE COMMISSION AND OWNER FOR THEIR FILES. THESE PICTURES AND IMAGES SHALL REFERENCE EXISTING SITE CONDITIONS AND PERMANENT REFERENCE MARKS TO ENABLE RECOGNITION OF THE AREA BEING PHOTOGRAPHED, AND SHALL REPRESENT A COMPREHENSIVE VIEW OF THE SITE PRIOR TO DEVELOPMENT.

3. THE CONTRACTOR SHALL ESTABLISH A STAGING AREA ON A PORTION OF THE AREA TO BE DISTURBED FOR THE OVERNIGHT STORAGE OF EQUIPMENT AND STOCKPILING OF MATERIALS. THE STAGING AREA SHALL BE OUTSIDE OF THE 100' WETLANDS BUFFER ZONE.

4. IN THE STAGING AREA, THE CONTRACTOR SHALL HAVE A STOCKPILE OF MATERIALS REQUIRED TO CONTROL EROSION ON—SITE TO BE USED TO SUPPLEMENT OR REPAIR EROSION CONTROL DEVICES. THESE MATERIALS SHALL INCLUDE, BUT ARE NOT LIMITED TO: HAYBALES, SILT FENCE AND CRUSHED STONE.

5. A TEMPORARY STONE CONSTRUCTION ENTRANCE IS REQUIRED TO PREVENT TRACKING OF SILT, MUD, ETC. ONTO EXISTING ROADS. THE STONE SHALL BE REPLACED REGULARLY AS WELL AS WHEN THE STONE IS SILT LADEN OR EQUIPMENT IS OBSERVED TO BE TRACKING SOIL ONTO THE ROADWAYS.

6. THE CONTRACTOR IS RESPONSIBLE FOR EROSION CONTROL ON SITE AND SHALL UTILIZE EROSION CONTROL MEASURES WHERE NEEDED, REGARDLESS OF WHETHER THE MEASURES ARE SPECIFIED HEREIN, ON THE PLAN OR IN ANY ORDER OF CONDITIONS.

GENERAL CONSTRUCTION REQUIREMENTS:

1. ANY REFUELING OF CONSTRUCTION VEHICLES AND EQUIPMENT SHALL TAKE PLACE
OUTSIDE OF THE 100 FOOT BUFFER ZONE TO THE ENTRANCE TO THE DRAINAGE SYSTEM
AND SHALL NOT BE CONDUCTED IN PROXIMITY TO SEDIMENTATION BASINS OR DIVERSION
SWALES.

2. NO ON—SITE DISPOSAL OF SOLID WASTE, INCLUDING BUILDING MATERIALS IS ALLOWED IN THE 100 FOOT BUFFER ZONE. THE BURIAL OF STUMPS, CONSTRUCTION DEBRIS OR OTHER MATERIALS SHALL NOT BE ALLOWED ANYWHERE ON—SITE.

3. NO MATERIALS SHALL BE DISPOSED OF INTO THE WETLANDS OR EXISTING OR PROPOSED DRAINAGE SYSTEMS. ALL CONTRACTORS INCLUDING: CONCRETE SUPPLIERS, PAINTERS AND PLASTERERS, SHALL BE INFORMED THAT THE CLEANING OF EQUIPMENT IS PROHIBITED IN AREAS WHERE THE WASH—WATER WILL DRAIN DIRECTLY TO THE SITE DRAINAGE SYSTEMS.

4. CONTRACTOR IS RESPONSIBLE FOR DUST CONTROL WHICH SHALL INCLUDE STREET SWEEPING OF ALL PAVED SURFACES WITHIN THE SITE AND OFF—SITE AREAS THAT ARE IMPACTED BY SITE CONSTRUCTION ON A REGULAR BASIS, AS NEEDED.

CONSTRUCTION NOTES

1.) ALL MATERIALS AND CONSTRUCTION PRACTICES SHALL BE IN CONFORMANCE WITH THE LATEST EDITION OF THE MASSACHUSETTS DEPARTMENT OF PUBLIC WORKS (MDPW) CONSTRUCTION STANDARDS AND THE MDPW "STANDARD SPECIFICATIONS FOR HIGHWAYS AND BRIDGES", UNLESS OTHERWISE SPECIFIED BY LOCAL AUTHORITY OR THE ENGINEER.

2.) THE CONTRACTOR SHALL UTILIZE ALL MEASURES AND MATERIALS NECESSARY TO ENSURE THE SAFETY OF ALL PERSONS AND PROPERTIES AT THE SITE DURING CONSTRUCTION. ALL EXCAVATIONS SHALL CONFORM TO CURRENT OSHA STANDARDS.

3.) UNLESS OTHERWISE NOTED, ALL DISTURBED AREAS SHALL BE DRESSED WITH A MINIMUM OF FOUR INCHES (4") OF LOAM AND SHALL BE SEEDED WITH AN APPROVED GRASS MIX.

4.) THE CONTRACTOR SHALL PROVIDE APPROPRIATE EROSION AND SEDIMENTATION CONTROL MEASURES AT ALL TIMES. DEWATERING OPERATIONS SHALL BE PROVIDED, IF REQUIRED; ALL DISCHARGE SHALL PASS THROUGH SEDIMENTATION CONTROL DEVICES TO PREVENT IMPACTS UPON WATER BODIES, BORDERING VEGETATED WETLANDS, DRAINAGE SYSTEMS AND ABUTTING PROPERTIES.

5.) NO MATERIALS SUBJECT TO EROSION SHALL BE STOCKPILED OVERNIGHT WITHIN 100 FEET OF A CATCH BASIN. ALL MATERIALS STOCKPILED WITHIN 100 FEET OF A CATCH BASIN, SHALL BE RELOCATED, MULCHED OR OTHERWISE TREATED TO INSURE THAT THE MATERIALS ARE NOT CARRIED TO THE CATCH BASIN.

6.) DISTURBED AREAS SHALL BE STABILIZED BY LOAMING AND SEEDING SOON AFTER THE FINISHED GRADE HAS BEEN MET. IF FINAL GRADING DOES NOT OCCUR DURING THE GROWING SEASON, THESE AREAS SHALL BE MULCHED WITH HAY SECURED BY WEIGHTED SNOW FENCE, CHICKEN WIRE MESH OR JUTE NETTING WITH STAPLES. SEED FOR PERMANENT GRASS COVER SHOULD BE ACCORDING TO SOIL CONSERVATION SERVICE GUIDELINES FOR SOIL AND MOISTURE CONDITIONS FOUND ON THE SITE.

7.) SEDIMENTATION CONTROL FENCE AND/OR HAY BALES SHALL BE MAINTAINED UNTIL ALL SLOPES HAVE BEEN STABILIZED AND THERE IS NO DANGER OF EROSION OUTSIDE OF THE PROPERTY.

8.) PRIOR TO INITIATING CONSTRUCTION, SEDIMENTATION CONTROL DEVICES SHALL BE INSTALLED AS SHOWN ON THE PLANS. THE CONTRACTOR SHALL MAINTAIN THE DEVICES UNTIL ALL WORK IS COMPLETE AND ALL AREAS HAVE BEEN STABILIZED.

9.) ACCUMULATED SEDIMENT SHALL BE REMOVED AND DISPOSED OF BY THE CONTRACTOR AS REQUIRED BY THE CONSERVATION COMMISSION OR AS DIRECTED BY THE ENGINEER.

10.) THE FUNCTIONING OF TEMPORARY CULVERTS, DITCHES, SWALES, OR CONSTRUCTION OPERATIONS SHALL NOT CAUSE NOTICEABLE SEDIMENTATION PLUMES. IF PLUMES OCCUR, THE CONTRACTOR SHALL STOP WORK AND INSTALL ADDITIONAL SEDIMENTATION CONTROL DEVICES IMMEDIATELY TO PREVENT FURTHER SEDIMENTATION.

11.) IT SHALL BE THE RESPONSIBILITY OF THE CONTRACTOR TO COORDINATE HIS WORK WITH THE APPROPRIATE HIGHWAY AND UTILITY DEPARTMENTS. CONTRACTOR SHALL MAINTAIN ALL EXISTING AND NEWLY INSTALLED UTILITIES IN GOOD WORKING ORDER AND SHALL PROTECT THEM FROM DAMAGE AT ALL TIMES UNTIL THE WORK IS COMPLETED AND ACCEPTED.

12.) THE CONTRACTOR SHALL PROVIDE FOR ALL TRAFFIC CONTROL IN ACCORDANCE WITH THE TOWN OF STURBRIDGE REQUIREMENTS.

13.) NO TRENCHES SHALL BE ALLOWED TO REMAIN OPEN OVERNIGHT.

14.) ALL POTABLE WATER AND SANITARY BUILDING SERVICE CONNECTIONS SHALL BE SEPARATED HORIZONTALLY BY A MINIMUM OF TEN FEET.

15.) ALL REQUIRED PERMITS SHALL BE SECURED PRIOR TO COMMENCING WORK, INCLUDING ANY NECESSARY TRENCH PERMITS.

16.) ALL PROPOSED FENCING TO BE INSTALLED ALONG THE PROPERTY LINE UNLESS OTHERWISE DESIGNATED. ALL FENCING ALONG PROPERTY LINES SHALL NOT EXCEED 6 FEET IN HEIGHT.

17.) ALL PROPOSED LIGHTING TO BE LESS THAN 20' HIGH & HAVE DOWN—SHADES TO PREVENT LIGHT SPILLOVER. THERE SHALL BE NO MORE THAN ONE—FOOT CANDLE OF SPILLOVER ONTO RESIDENTIAL ABUTTING PROPERTIES.

18.) PROPERTY OWNER SHALL MAINTAIN LANDSCAPING ELEMENTS DURING & AFTER CONSTRUCTION.

19.) ALL PAVING ELEMENTS SHALL BE IN CONFORMANCE WITH THE TOWN OF STURBRIDGE DPW REQUIREMENTS.

20.) EXISTING TREES THAT ARE GREATER THAN 9" CALIBER ARE INDICATED ON THE SITE PLAN SET.

21.) THE OWNER OF THE PROPERTY SHALL BE RESPONSIBLE FOR MAINTAINING THE HEALTH AND VISUAL APPEAL OF ALL LANDSCAPING ELEMENTS AFTER CONSTRUCTION.

22.) EXCESS SNOW SHALL BE TRUCKED OFF OF THE SITE ONCE THE AMOUNT WITHIN THE SNOW STORAGE AREA BEGINS TO IMPEDE ACCESS TO THE REQUIRED PARKING SPACES OR ONCE SIGHT LINE ACCESS IS IMPEDED FROM ANY DIRECTION.

23). NO EXISTING VEGETATION SHALL BE RETAINED UNLESS ITEMIZED ON PLANS. SEE LANDSCAPING PLAN/TABLE FOR GUIDANCE.

PLAN VIEW

GRADE TO

TO BASIN

DIRECT FLOW

PROFILE VIEW

10'X5' +

BASIN

1/2" - 3/4"-

: LINES OF WATTLES TO

BE PERPENDICULAR TO RUNOFF

2X10 SET LEVEL

-LARGE STONES

TO HOLD 2X10 /

femporary dewatering area

1"x1"x24" STAKE

WATTLE


STAKE DEPTH – 1'MIN.


<u>SECTION</u>

TRAW WATTLES

NOT TO SCALE

>STAKED HAYBALE

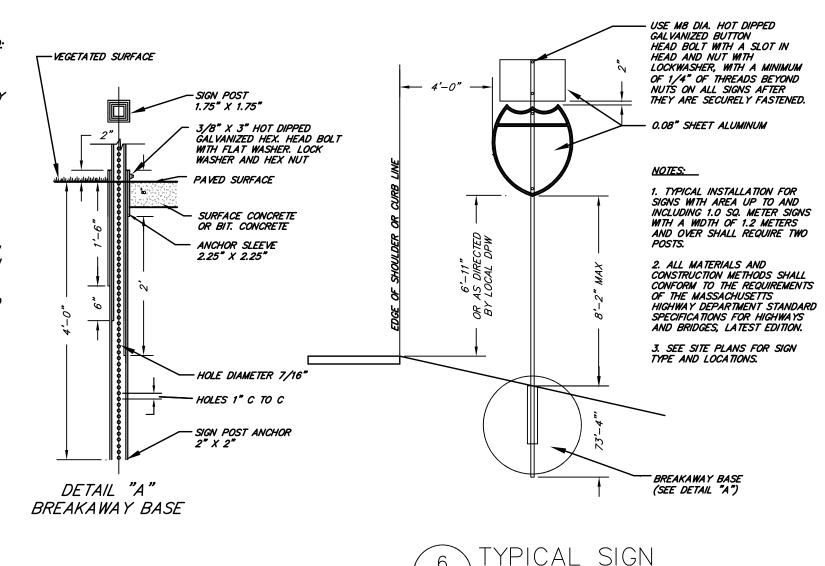

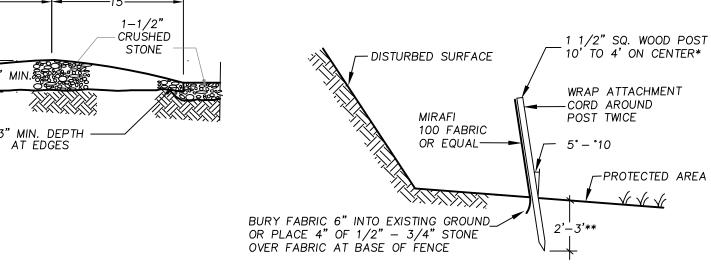

* STEEL POST MAY BE SUBSTITUTED. DISTANCE BETWEEN POSTS TO VARY
AS REQUIRED BY TRIBUTARY AREA: 10' FOR 100 SF/LF FENCE
6' FOR 500 SF/LF FENCE

IF POST IS TO BE SET IN PEAT OR UNSTABLE SOILS, THEN 3' OR DEPTH


NECESSARY TO PROVIDE A STABLE POST FOR LOADED FENCE CONDITIONS

NOT TO SCALE

SILT FENCE DETAIL

NOT TO SCALE

** DEPTH TO VARY WITH TRIBUTARY AREA: 2' FOR 100 SF ETC.

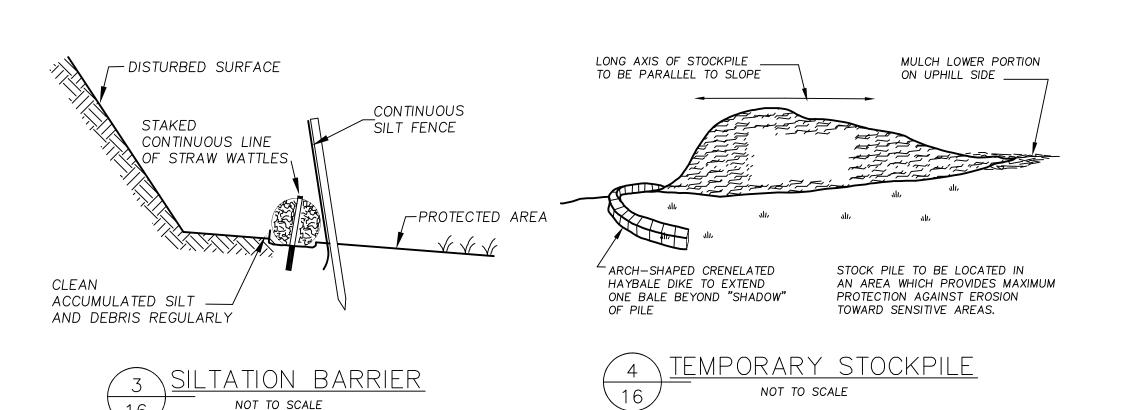




ARCO DESIGN/BUILD

380 Interstate North Pkwy. SE, Atlanta, GA 30339 Suite 210 770.541.1700





710 Main Street North Oxford, MA 01537

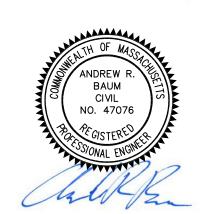

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NEW ENGLAND COLD STORAGE, LLC.

> 6 PICKER ROAD STURBRIDGE, MA

CONSTRUCTION DETAILS

6/1/20 - PER CONSERVATION COMMISSION COMMENTS
REVISIONS

 SCALE:
 AS SHOWN


 DATE:
 MAY 12, 2020

 JOB NO:
 20-122

JOB NO: 20-122

PLAN NO: 20-122 DEFINITIVE SITE PLAN

SHEET NO: 16 OF 19

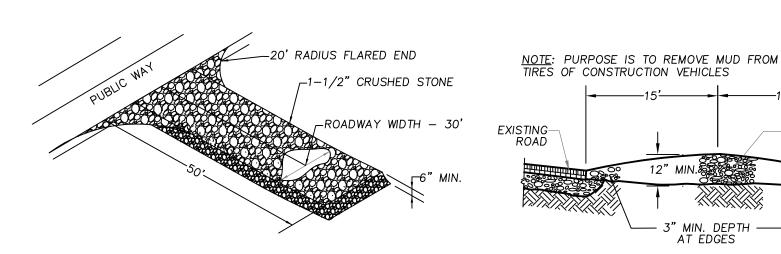

NOTES:

1. REPLACE STONE & ACCUMULATED DEBRIS, MUD & ENTRAPPED MATERIALS AS IS NECESSARY TO PREVENT TRACKING ON PUBLIC ROADWAYS. REPLACE MONTHLY AS A MINIMUM REQUIREMENT.

2. DISPOSE OF STONE & ENTRAPPED MATERIALS IN A

NON SENSITIVE AREA ON—SITE.


3. DO NOT REUSE STONE FOR SAME PURPOSE.


4. ALL TRAFFIC ENTERING / EXISTING SITE TO CROSS

1 TEMPORARY CONSTRUCTION ENTRANCE
NOT TO SCALE

TEMPORARY CONSTRUCTION ENTRANCE

ARCC

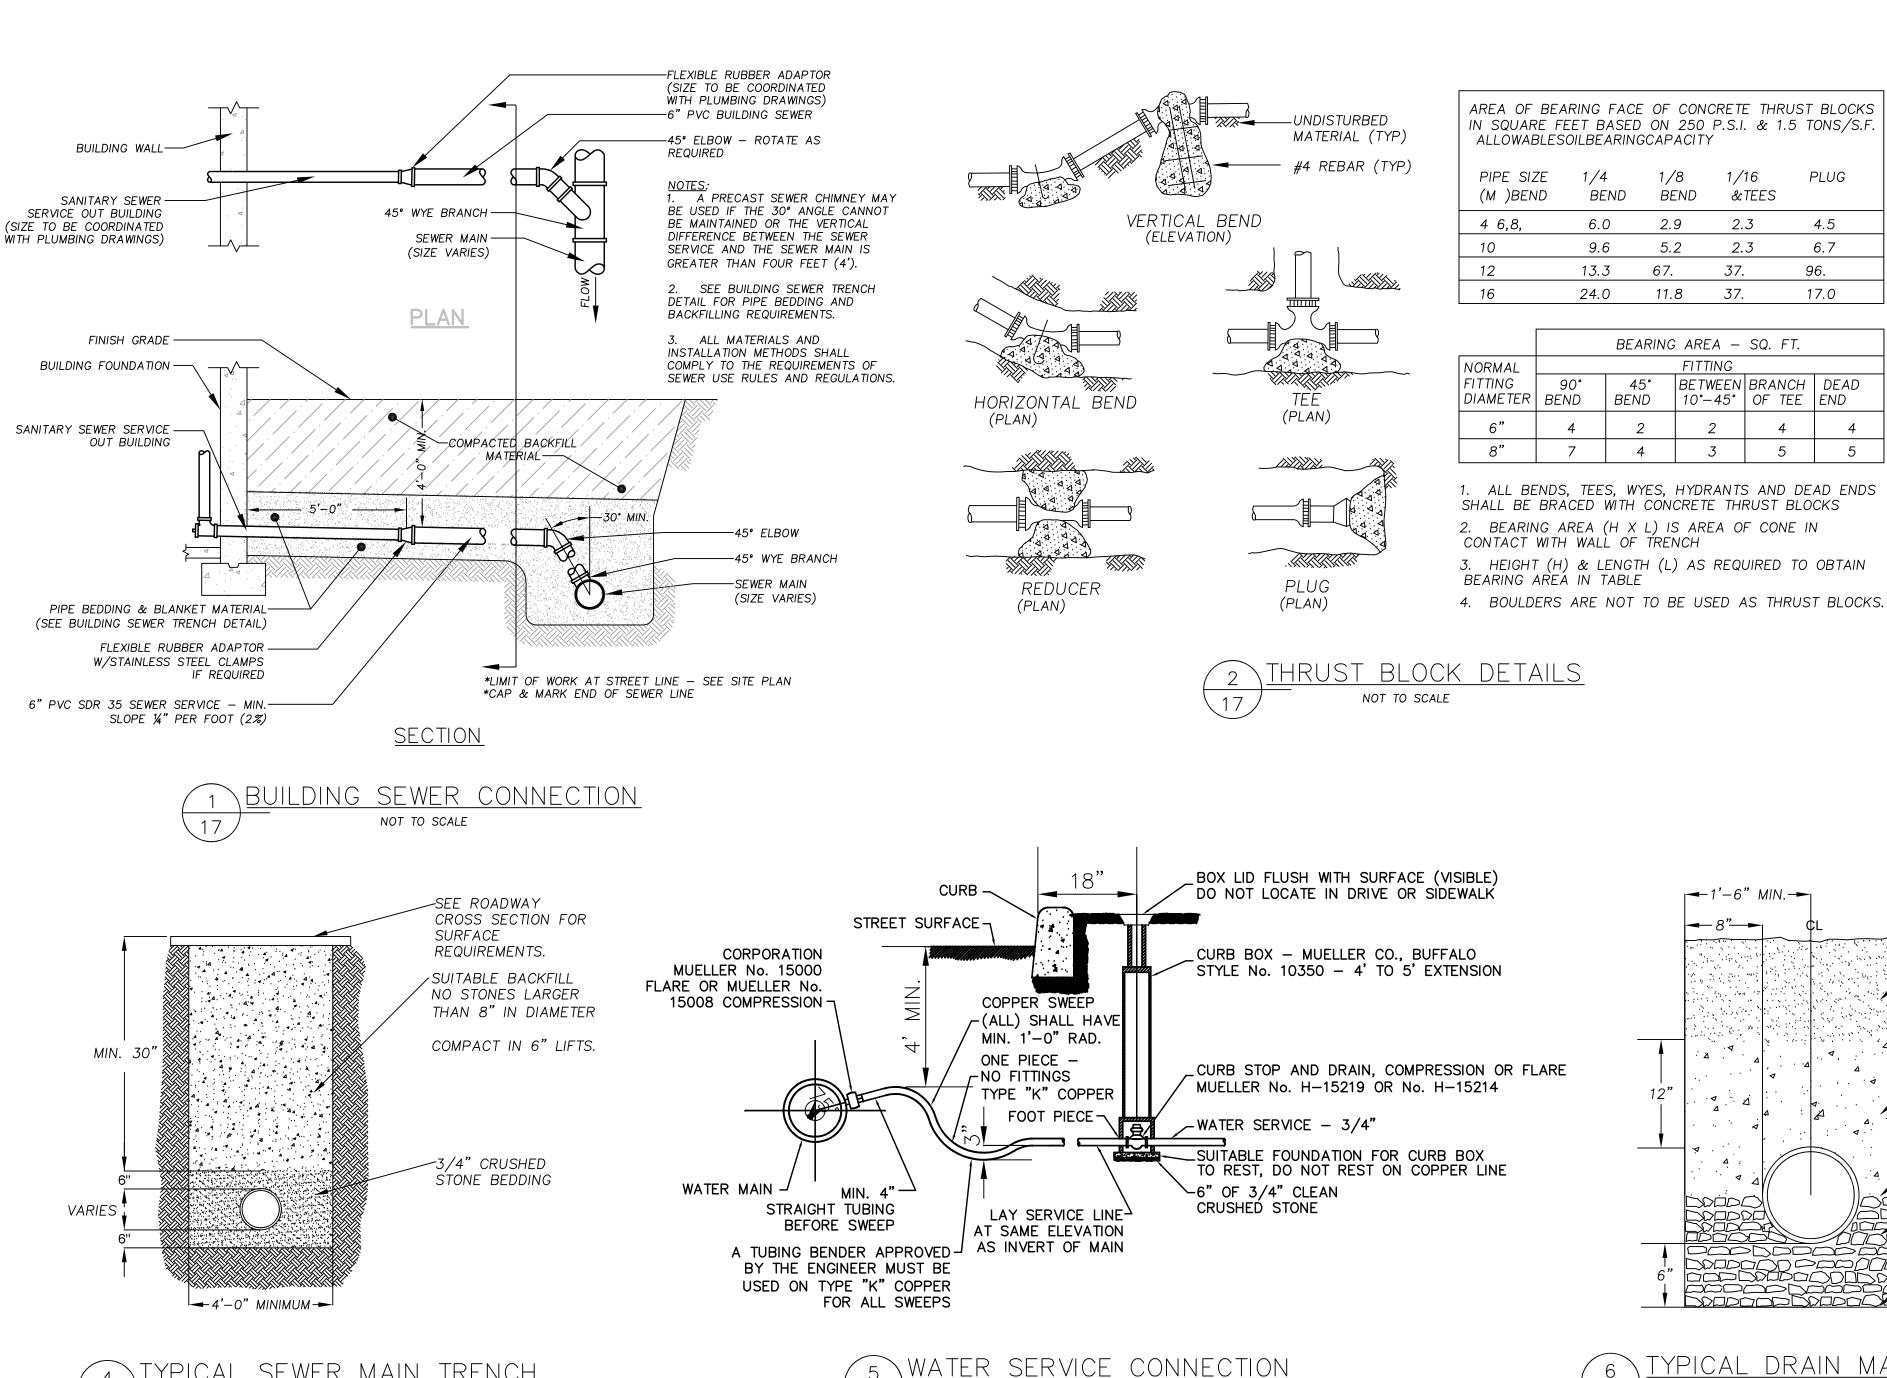

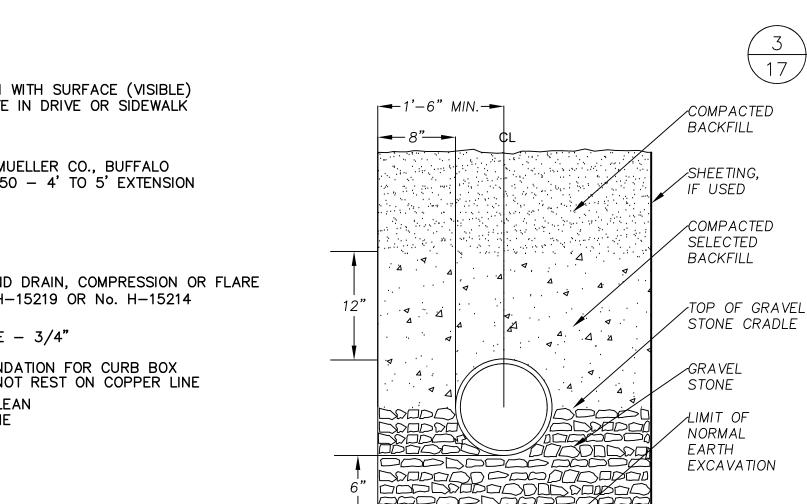

1/16

&TEES

2.3

2.3

45° | BETWEEN | BRANCH | DEAD

10°-45° | OF TEE | END

5

37.

1/8

2.9

5.2

11.8 37.

BEARING AREA - SQ. FT.

3

67.

BEND

1/4

BEND

6.0

13.3

24.0

7

BEND

4


PLUG


4.5

6.7

96.

17.0

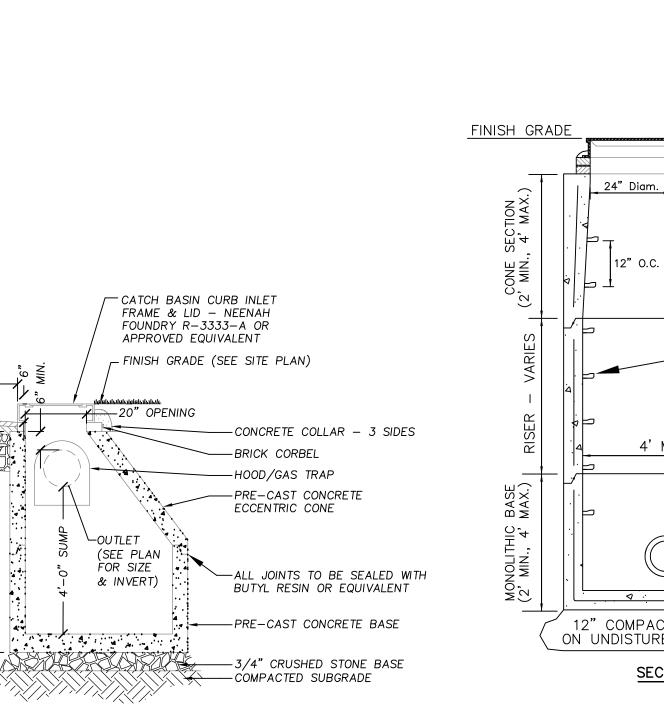

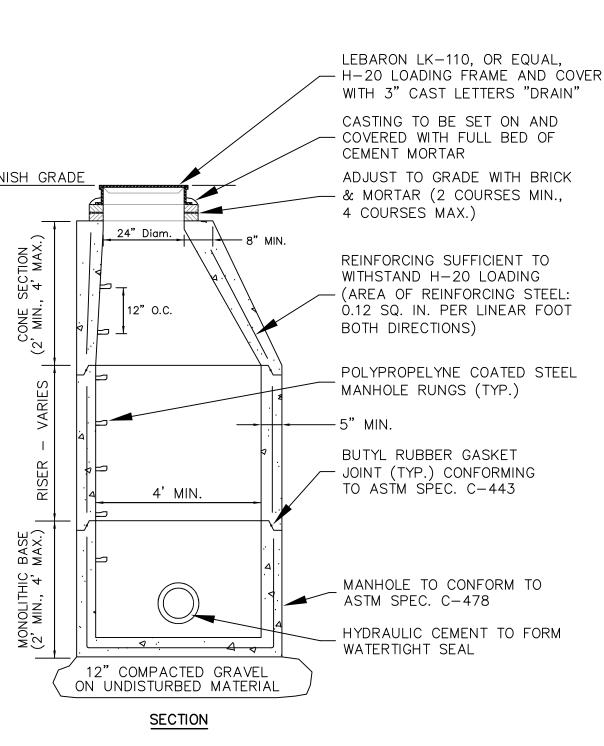


. DRAIN MAIN TRENCH

NOT TO SCALE

PRECAST DRAIN MANHOLE NOT TO SCALE


KENNEDY HYDRANT K81D BY KENNEDY VALVE CO. INC. 5-1/4" VALVE DIAMETER. HYDRANT PAINTED HI-VISIBILTY YELLOW. PENTAGONAL OPERATING NUT SHALL BE 1-5/8" POINT TO FLAT, OPENING RIGHT. 2-2.5" HOSE AND 1-4.5" PUMP NOZZELS, N.S. THREADS

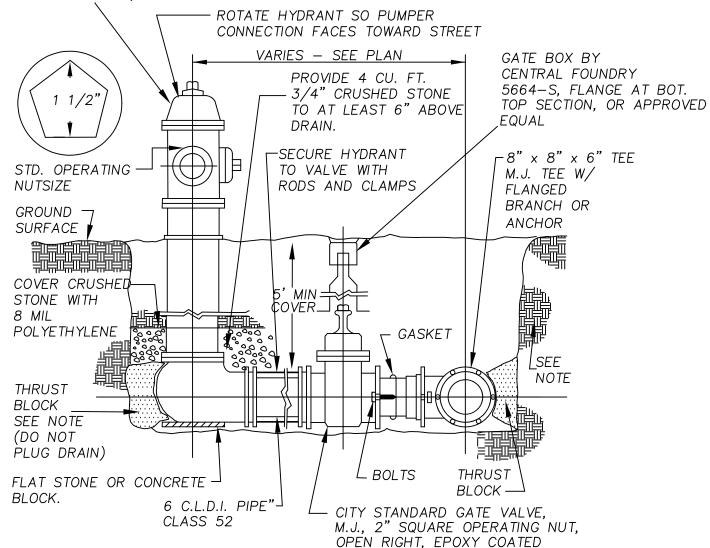

THRUST BLOCK SHALL BE MINIMUM 4.000PSI CONCRETE AT 28 DAYS PLACED AGAINST UNDISTURBED MATERIAL MINIMUM BEARING AREA TO BE 4 SQUARE FEET

HYDRANTS SHALL BE TO THE TOWN OF STURBRIDGE STANDARDS.

TYPICAL HYDRANT AND VALVE NOT TO SCALE

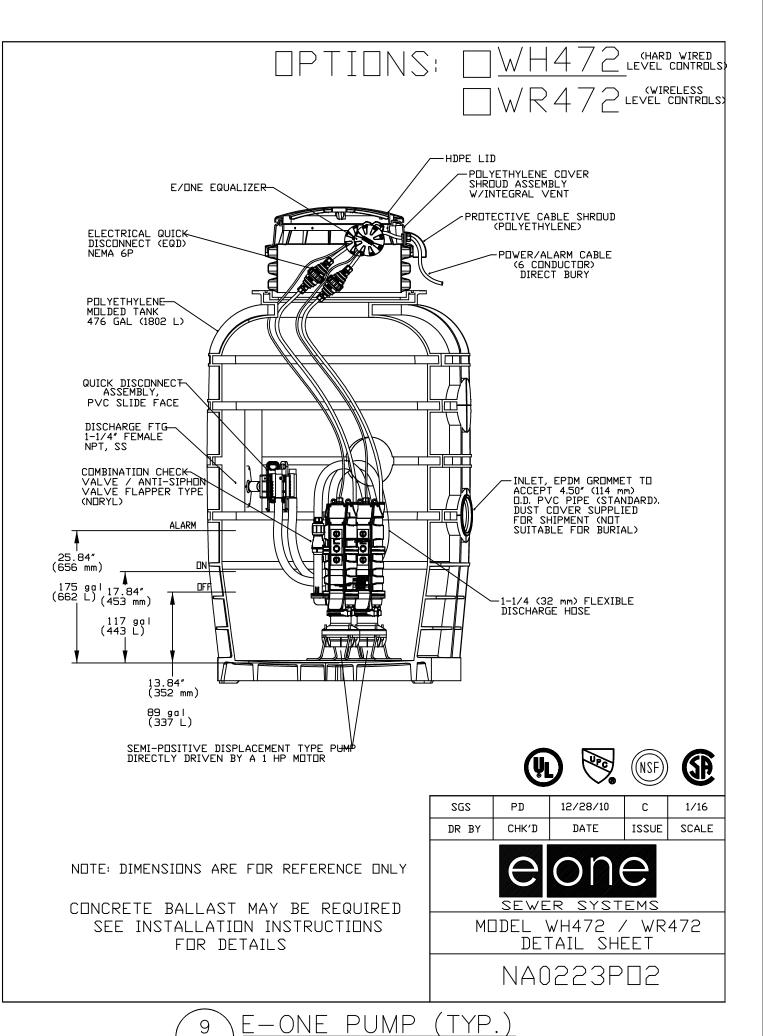






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710 Main Street North Oxford, MA 01537



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NEW ENGLAND COLD STORAGE, LLC.

6 PICKER ROAD STURBRIDGE, MA

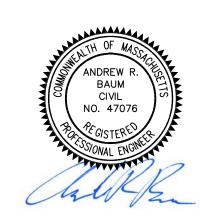CONSTRUCTION **DETAILS**

6/1/20 - PER CONSERVATION COMMISSION COMMENTS **REVISIONS**

SCALE: AS SHOWN

MAY 12, 2020 DATE: 20-122 JOB NO: 20-122 DEFINITIVE SITE PLAN PLAN NO: 17 OF 19 SHEET NO:



BENCH HEIGHT /= 0.75 PIPE DIA

FLOW ——

A CONC. BENCH A A

6" - 3/4" STONE

UNDISTURBED

SUBGRADE

YPICAL SEWER MAIN TRENCH

FRAME & COVER

- GRADE

PATTERN NO. 1104B CAMPBELL FOUNDRY CO.

MORTAR

BRICK COURSE TO SUIT

CONCRETE COMPRESSIVE

REINFORCING ASTM A-185

AREA=0.12 IN2/VERTCIAL FT.

ASTM C445/C361 RUBBER ASTM D1056 NEOPRENE

STRENGTH 4000 P.S.I.

TROWEL COAT OF

BITUMINOUS MATERIAL


-1 1/2" (MIN.) THICKNESS

NON-SHRINK GROUT

ALL-AROUND

NOT TO SCALE

4'ø DIAMETER

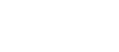

PIPE DIA. NOT TO EXCEED

2. IF H* IS GREATER THEN 24"

USE DROP CONNECTION.

36" DIAMETER.

ROADWAY - SEE -

CONSTRUCTION

REQUIREMENTS

DETAIL FOR

INLET CATCHBASIN NOT TO SCALE

NOT TO SCALE

CATCH BASIN CURB INLET

FRAME & LID - NEENAH FOUNDRY R-3333-A OR

APPROVED EQUIVALENT

20" OPENING

└OUTLET


(SEE PLAN FOR SIZE

& INVERT)

FINISH GRADE (SEE SITE PLAN)


-BRICK CORBEL



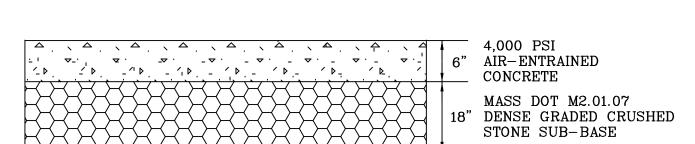



PAVEMENT DETAIL



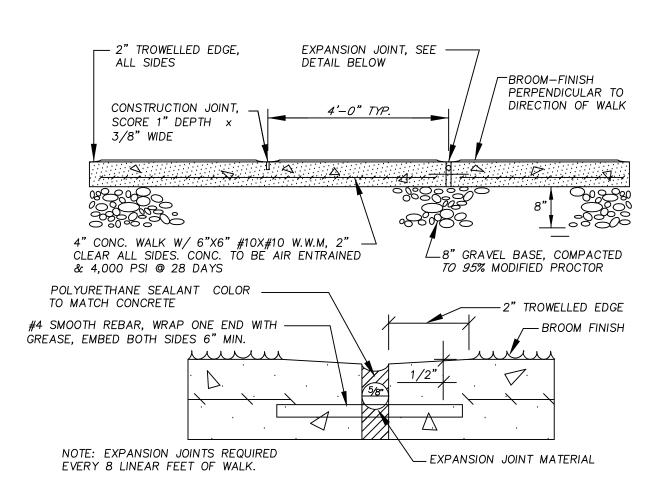




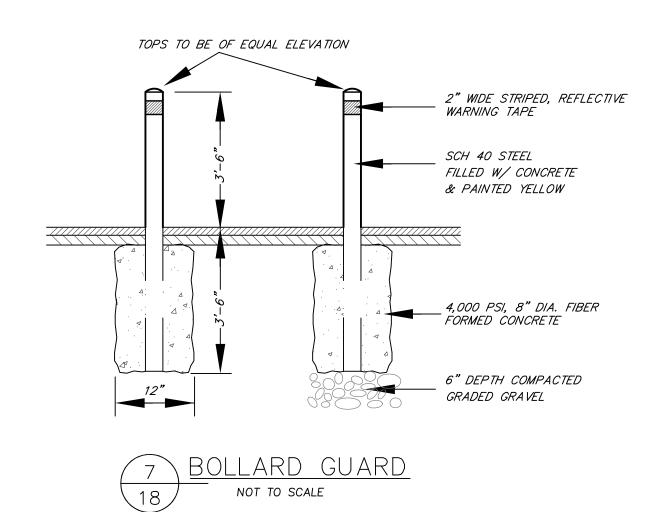

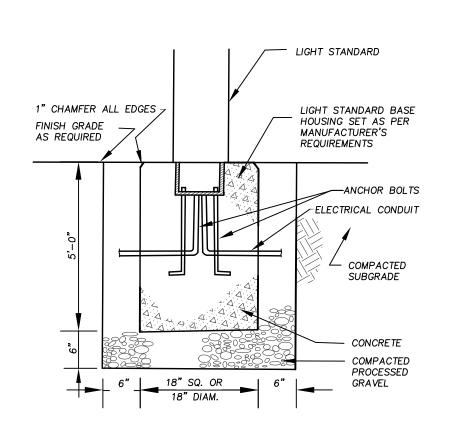

GHT STANDARD BASE NOT TO SCALE

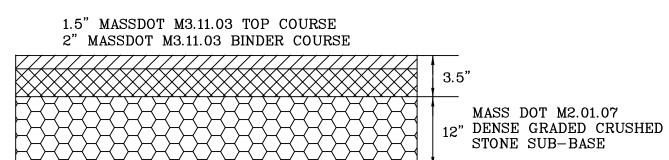

TANDARD PAVEMENT DETAIL

(MIN.)

FRAME & GRATE / TOP OF GRADE

-4"ø PVC PIPE

\W/4" CAP

4"ø OUTLET→

1. THE USE OF FLEXIBLE CONNECTIONS IS RECOMMENDED

2. THE COVER SHOULD BE POSITIONED OVER THE 4"0

CLEANOUT/VENT PIPE AND THE 4"0 INLET DOWN PIPE. 3. THE STORMCEPTOR SYSTEM IS PROTECTED BY ONE OR MORE

OFF THE FOLLOWING U.S. PATENTS: #4985148, #5498331,

RISER PIPE

SECTION THRU CHAMBER

AT THE OUTLET WHERE APPLICABLE.

#5725760, #5753115, #5849181.

HANDLE FOR-

REMOVABLE

4"ø INLET-

NOTE:

DOWN PIPE

(REMOVABLE)

DOME AND TEE

TRASH GUARD

WITH DOWN PIPE

\ MIN. 15" HIGH

STC 450i PRECAST CONCRETE STORMCEPTOR (450 US GALLON CAPACITY)

STORMCEPTOR

NEEDED

4. CONTRACTOR TO PROVIDE CRANE TO SET UNIT (HEAVIEST SECTION WEIGHS 5000 LB)

NOT TO SCALE

WATER QUALITY SEPARATOR

SEE NOTE 27

r4"ø PVC PIPE

LINSERT DOME AND TEE HERE

SECTION THRU PLAN VIEW

(TEE OPENINGS TO FACE SIDE WALLS)

CLEANOUT/VENT PIPE


r4"ø OUTLET

RISER PIPE


INSERT

∕GRADE ADJUSTERS

VAN SPACE

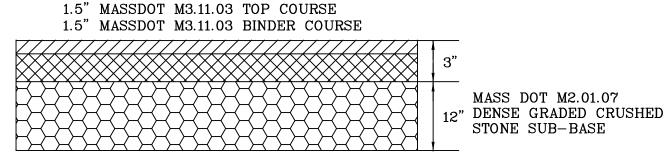




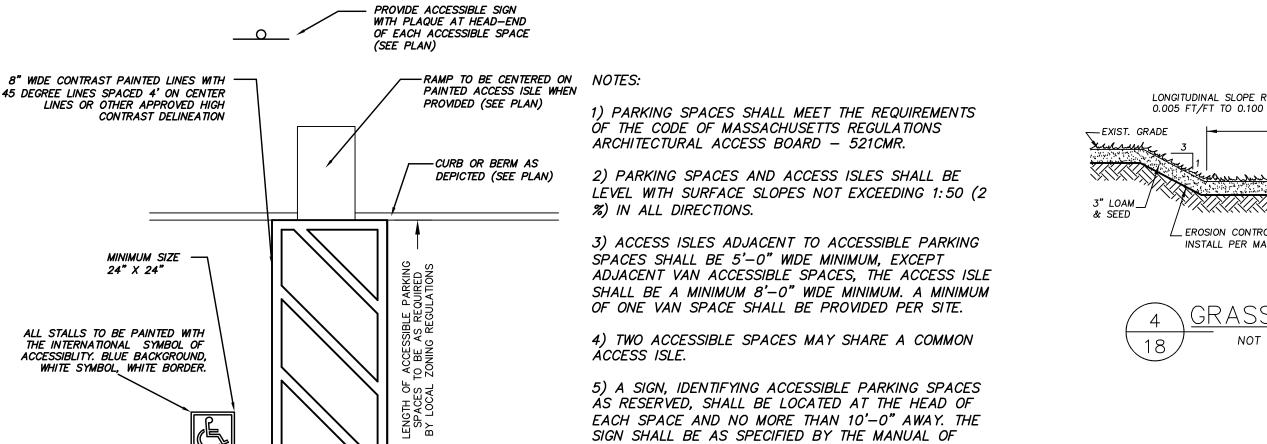


UNIFORM TRAFFIC CONTROL DEVICES (MUTCD), R7-8 OR APPROVED EQUAL.

6) SIGNS AT THE HEAD OF VAN ACCESSIBLE SPACES SHALL INCLUDE THE WORDS: VAN ACCESSIBLE, MUTCD R7-8B OR APPROVED EQUAL

OUTLET

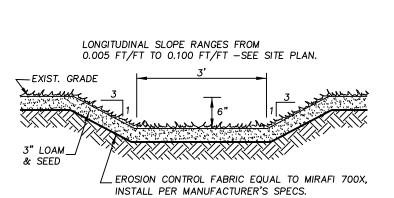

NOT TO SCALE

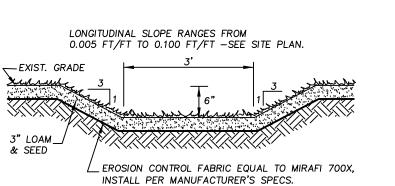

- 4" PRECAST CONCRETE CAP -PROVIDE REBAR HANDLES

FOR ACCESSIBILITY

--- CAST IN ORIFACE - SEE

FLOW & INVERT ELEVATIONS


SITE PLAN FOR DIMENSION

- 2'-0" WIDE x 4'-0" DEEP

- 3/4" CRUSHED STONE BASE

- UNDISTURBED EARTH

(INTERIOR DIMENSONS)
PRECAST CONCRETE
DROP INLET

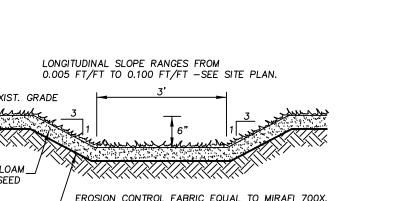

LARED END RIP RAP OUTLET NOT TO SCALE

1.5" MASSDOT M3.11.03 TOP COURSE

RIP-RAP SPECIFICATIONS

100 LB.

60 LB.

25 LB.

3" MASSDOT M3.11.03 BINDER COURSE

% OF TOTAL WEIGHT SMALLER

80%

NOT TO EXCEED 10%

THAN GIVEN SIZE

VARIES -

SEE SITE PLAN

EAVY DUTY PAVEMENT DETAIL

MASS DOT M2.01.07

STONE SUB-BASE

LOAM AND SEED-

18" RIP-RAP MATE

SEE SPECIFICATIONS.

EXTEND RIP-RAP


12" MIN. ABOVE PIPE.


12" COMPACTED

18" DENSE GRADED CRUSHED

- DRAIN PIPF

SEE SITE PLAN

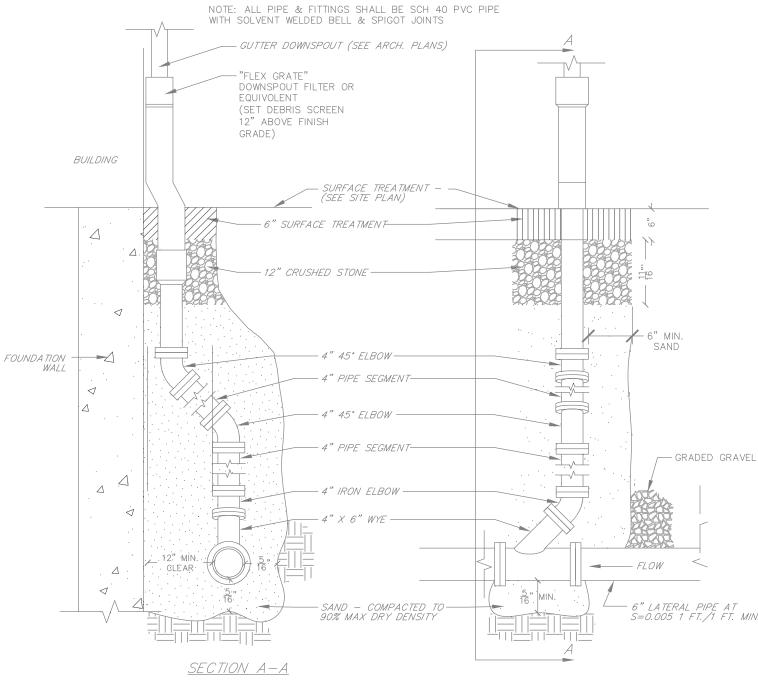


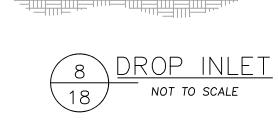

+8"+2'-0"-+8"+6" MIN.

OUTLET INVERT

> ROOF DRAIN CONNECTION NOT TO SCALE

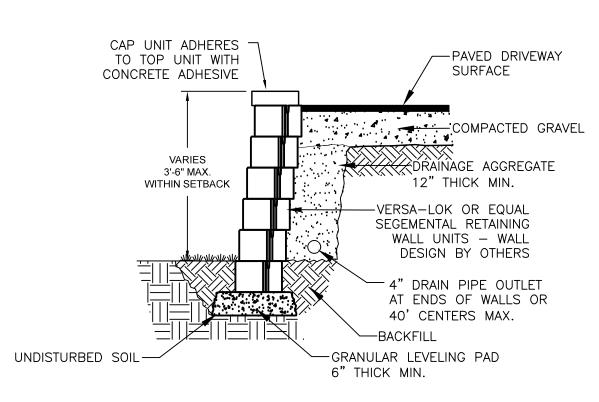

. SEGMENTAL RETAINING WALL NOT TO SCALE

GUARDRAIL TO BE INSTALLED AND CONSTRUCTED WITH MATERIALS AS SPECIFIED IN COMMONWEALTH OF MASS. DEPT. OF PUBLIC WORKS "CONSTRUCTION STANDARDS 1977" AND SECTION 601 OF THE STANDARD SPECIFICATIONS FOR HIGHWAY BRIDGES, 1973. 1'-0" 3'-0" SHOULDER BIT. CONC CURB



FOR PERMITTING ONLY: NOT FOR CONSTRUCTION






380 Interstate North Pkwy. SE, Atlanta, GA 30339 770.541.1700






710 Main Street North Oxford, MA 01537

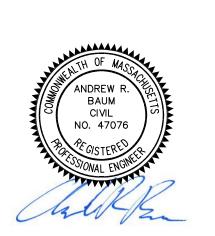

NEW ENGLAND COLD STORAGE, LLC.


6 PICKER ROAD STURBRIDGE, MA


CONSTRUCTION **DETAILS**

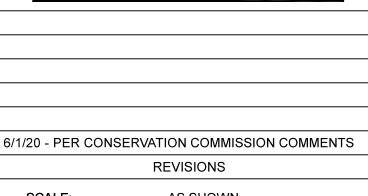


SCALE: AS SHOWN

MAY 12, 2020 DATE: 20-122 JOB NO: PLAN NO: 20-122 DEFINITIVE SITE PLAN SHEET NO: 18 OF 19

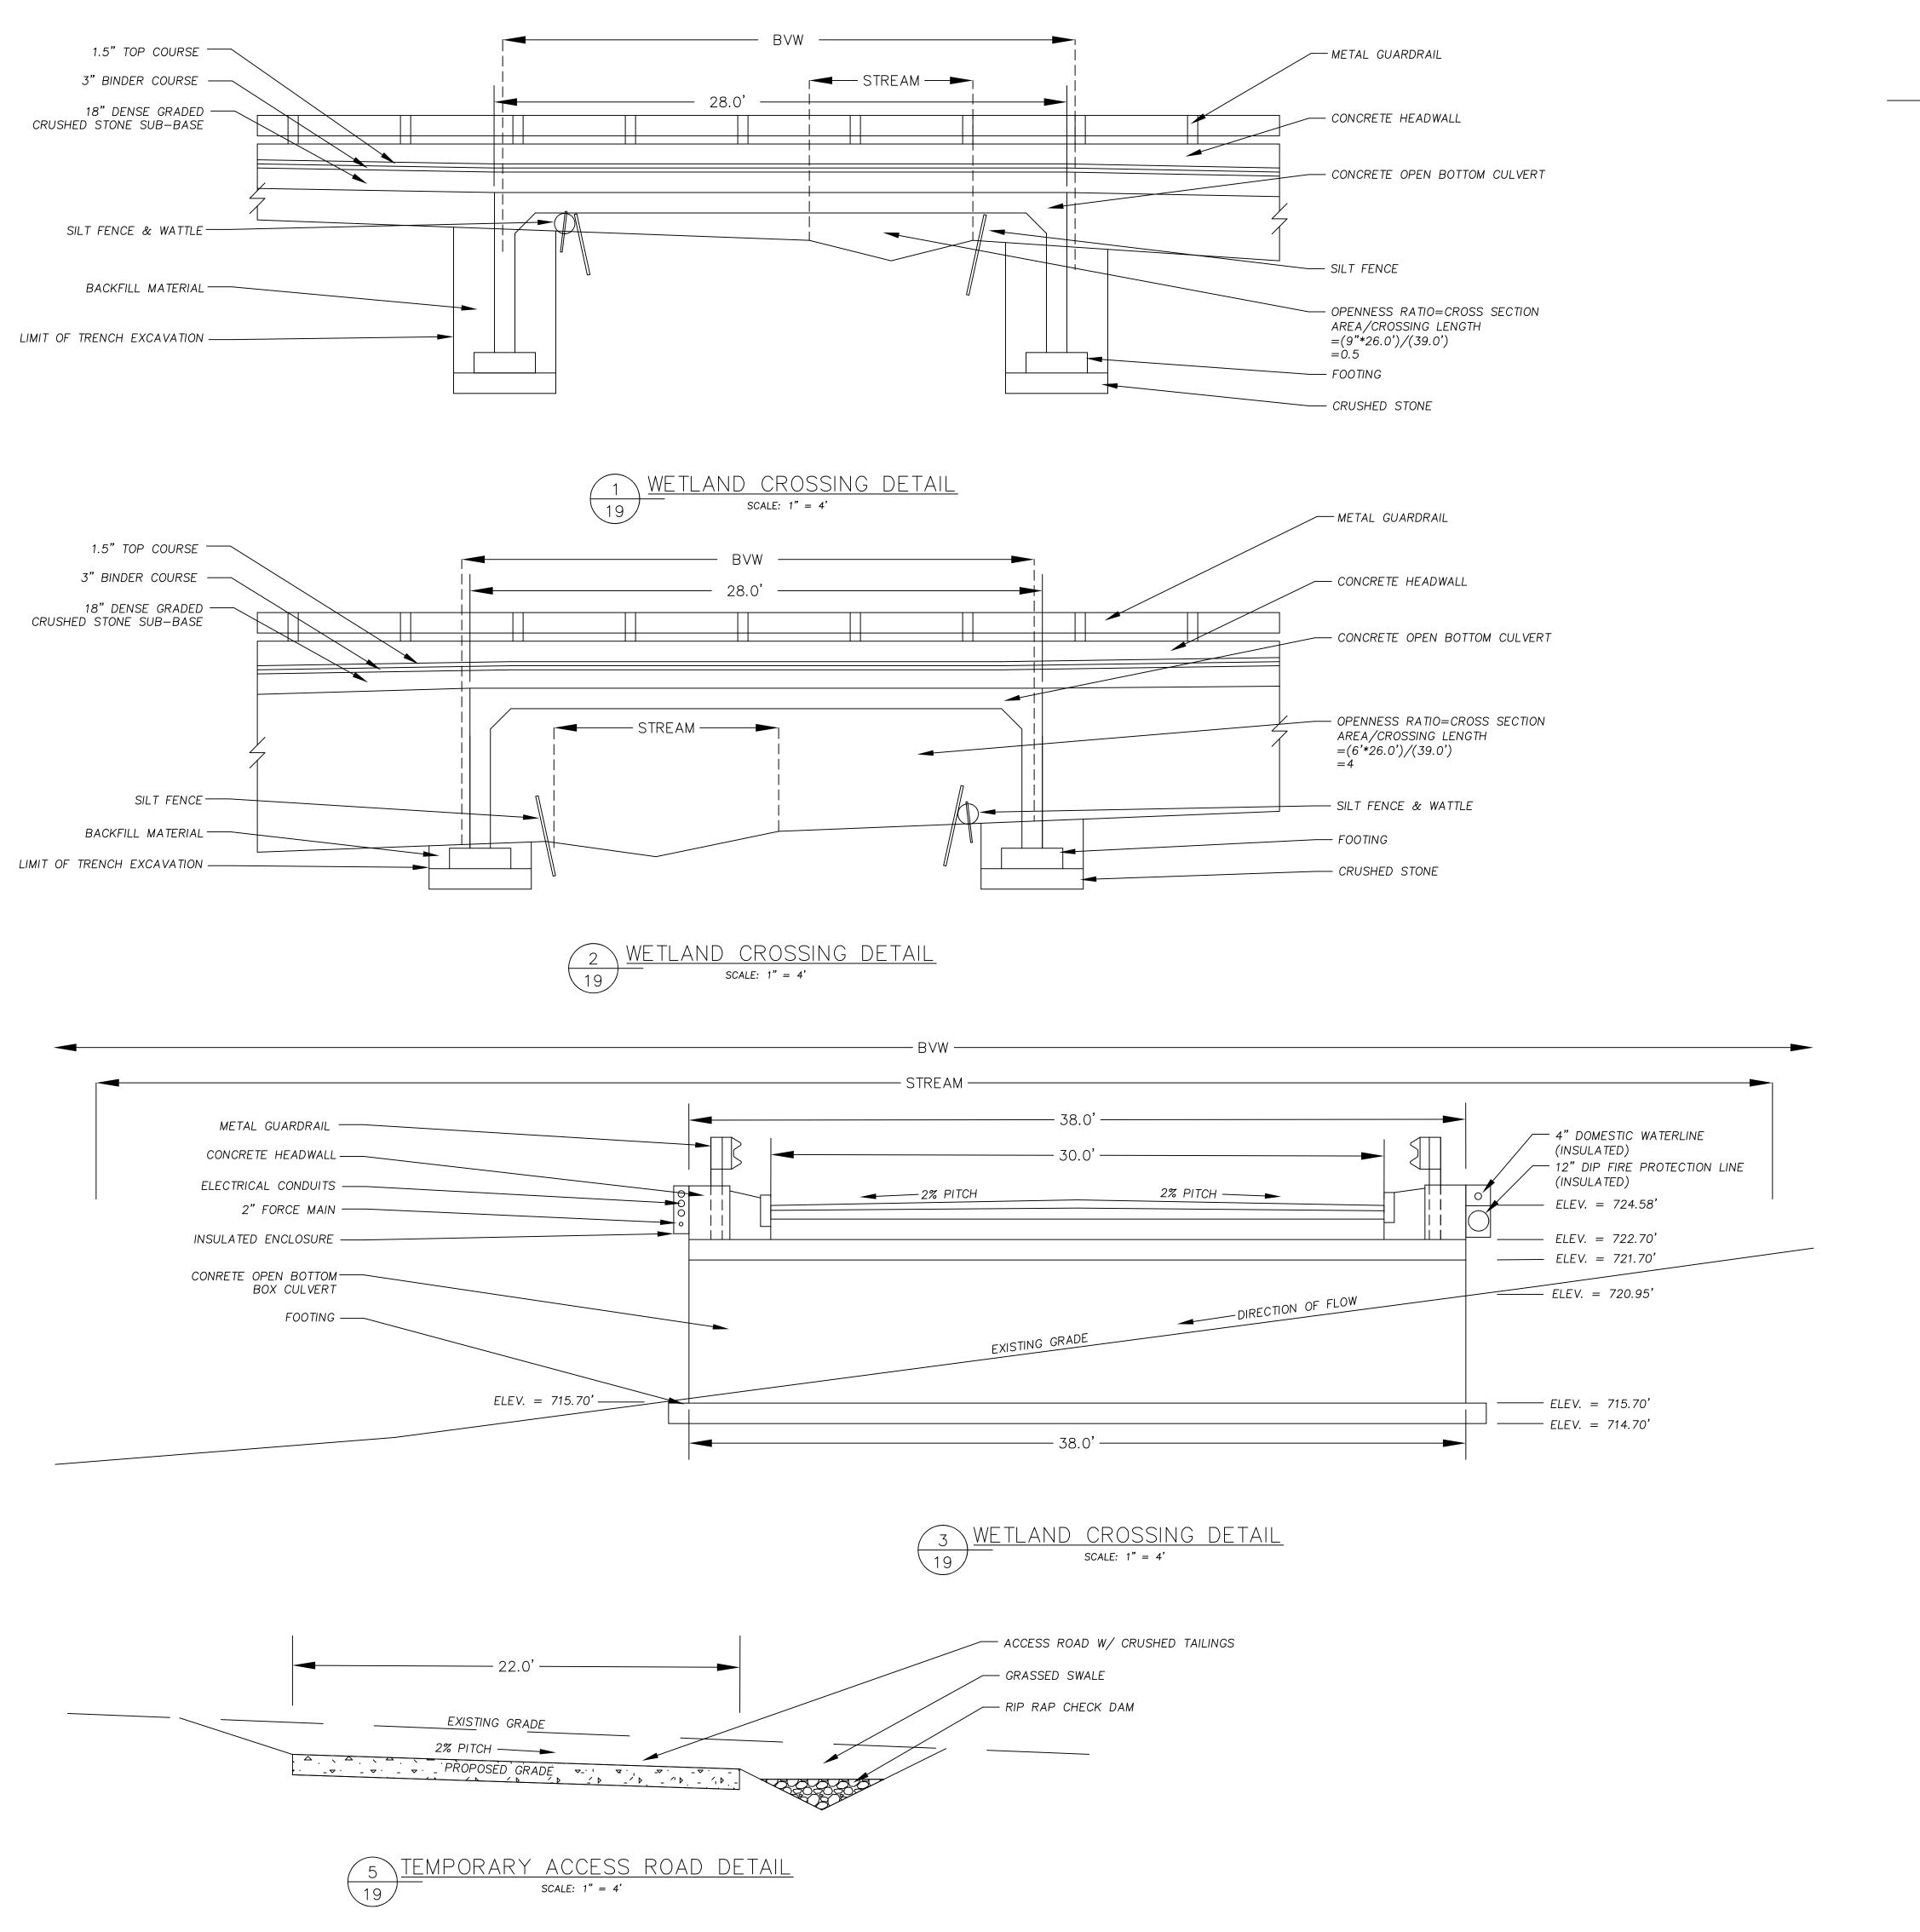

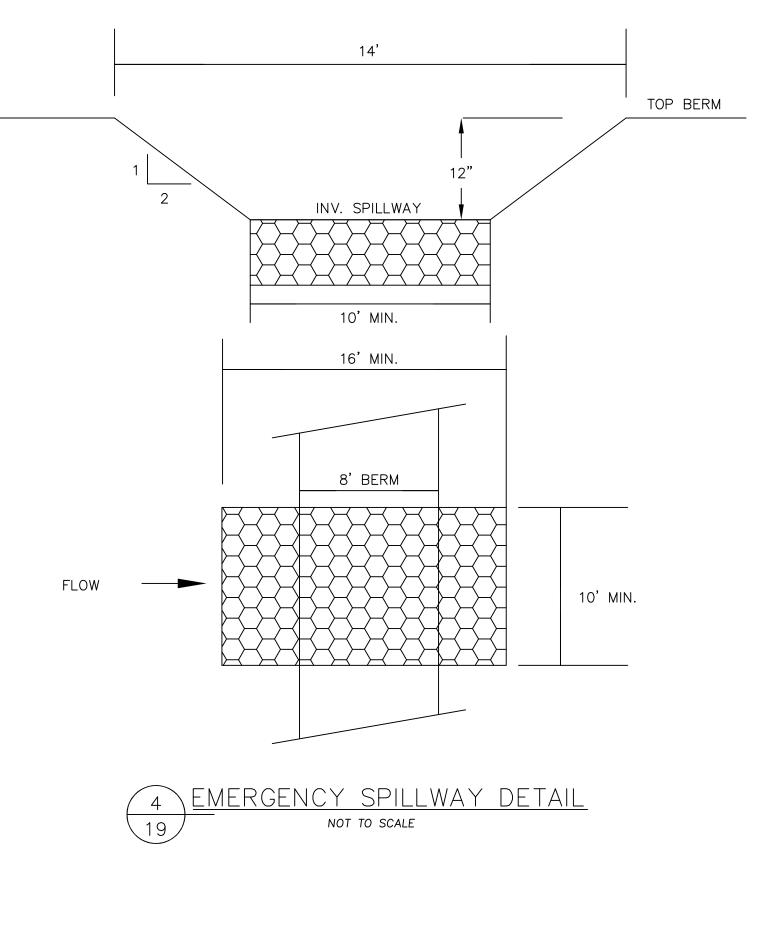

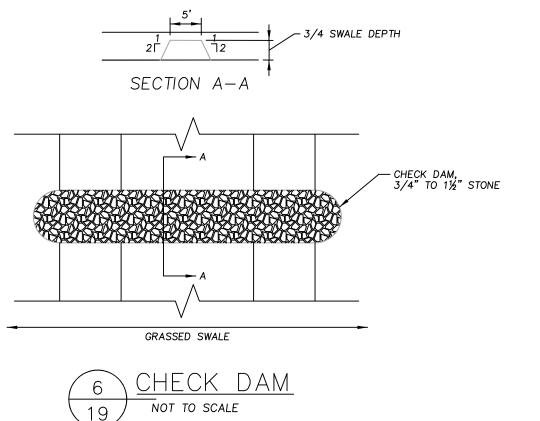









710 Main Street North Oxford, MA 01537



NEW ENGLAND COLD STORAGE, LLC.

> 6 PICKER ROAD STURBRIDGE, MA

CONSTRUCTION DETAILS

6/1/20 - PER CONSERVATION COMMISSION COMMENTS
REVISIONS

SCALE: AS SHOWN
DATE: MAY 12, 2020

20-122

19 OF 19

20-122 DEFINITIVE SITE PLAN

JOB NO:

PLAN NO:

SHEET NO:

FOR PERMITTING ONLY: NOT FOR CONSTRUCTION